

# GENERALIZED DEVELOPMENT PLANS

# SPOTSYLVANIA SOLAR ENERGY CENTER C

## SPECIAL USE PERMIT - SUP 18-0003



## LIVINGSTON MAGISTERIAL DISTRICT

## SPOTSYLVANIA COUNTY, VA

This document, together with the concepts and designs presented herein, is intended only for the specific purpose and client for which it was prepared. Reuse of and improper reliance on this document without written authorization and adaptation by Kimley-Horn and Associates, Inc. shall be without liability to Kimley-Horn and Associates, Inc.

**S-POWER**  
An AES and AIMCo Company  
2180 SOUTH 1300 EAST, SUITE 600  
SALT LAKE CITY, UT 84106  
PHONE: 801-679-3500 FAX: 801-679-3501  
WWW.SPOWER.COM

**Kimley-Horn**  
© 2018 KIMLEY-HORN AND ASSOCIATES, INC.  
11400 COMMERCE PARK DRIVE, SUITE 400  
RESTON, VA 20191  
PHONE: 703-674-1300  
WWW.KIMLEY-HORN.COM

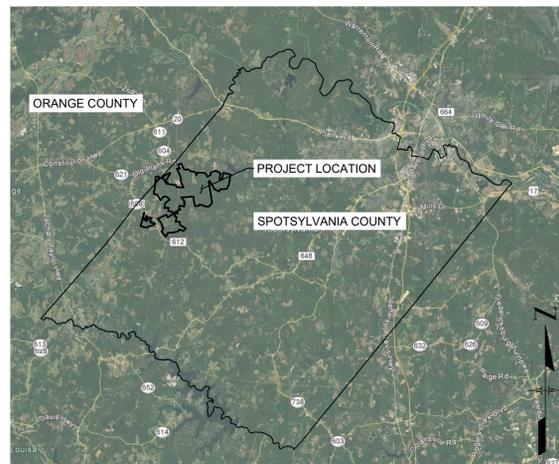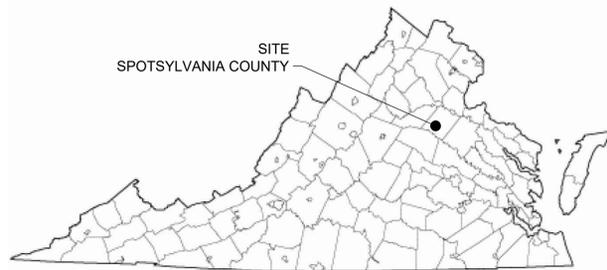


VICINITY MAP - SPOTSYLVANIA COUNTY, VA  
1" = 30,000'

SPOTSYLVANIA SOLAR ENERGY CENTER	
OWNER	sPOWER
EXISTING AND PROPOSED ZONING	AGRICULTURE 3 (A-3)
EXISTING USE	SILVICULTURE
PROPOSED USE	SOLAR ENERGY FACILITY
TOTAL POWER TO BE GENERATED	500 MEGAWATTS AC (MWac)
OVERALL PROJECT SITE DATA:	
PROPERTY AREA	6,350 ACRES
DISTURBED AREA	3,500 ACRES
POWER GENERATED	500 MWac
SITE A DATA:	
PROPERTY AREA	5,200 ACRES
DISTURBED AREA	2,800 ACRES
POWER GENERATED	400 MWac
SITE B DATA:	
PROPERTY AREA	245 ACRES
DISTURBED AREA	200 ACRES
POWER GENERATED	30 MWac
SITE C DATA:	
PROPERTY AREA	905 ACRES
DISTURBED AREA	500 ACRES
POWER GENERATED	70 MWac

**OWNER/APPLICANT**  
sPOWER  
2180 SOUTH 1300 EAST, SUITE 600  
SALT LAKE CITY, UT 84106  
PHONE: 801-679-3513  
CONTACT: DANIEL MENAHEM  
EMAIL: DMENAHEM@SPOWER.COM

**CIVIL ENGINEER**  
KIMLEY-HORN AND ASSOCIATES, INC.  
11400 COMMERCE PARK DRIVE, SUITE 400  
RESTON, VA 20191  
PHONE: 703-674-1337  
CONTACT: SEAN MILLOT, P.E.  
EMAIL: SEAN.MILLOT@KIMLEY-HORN.COM

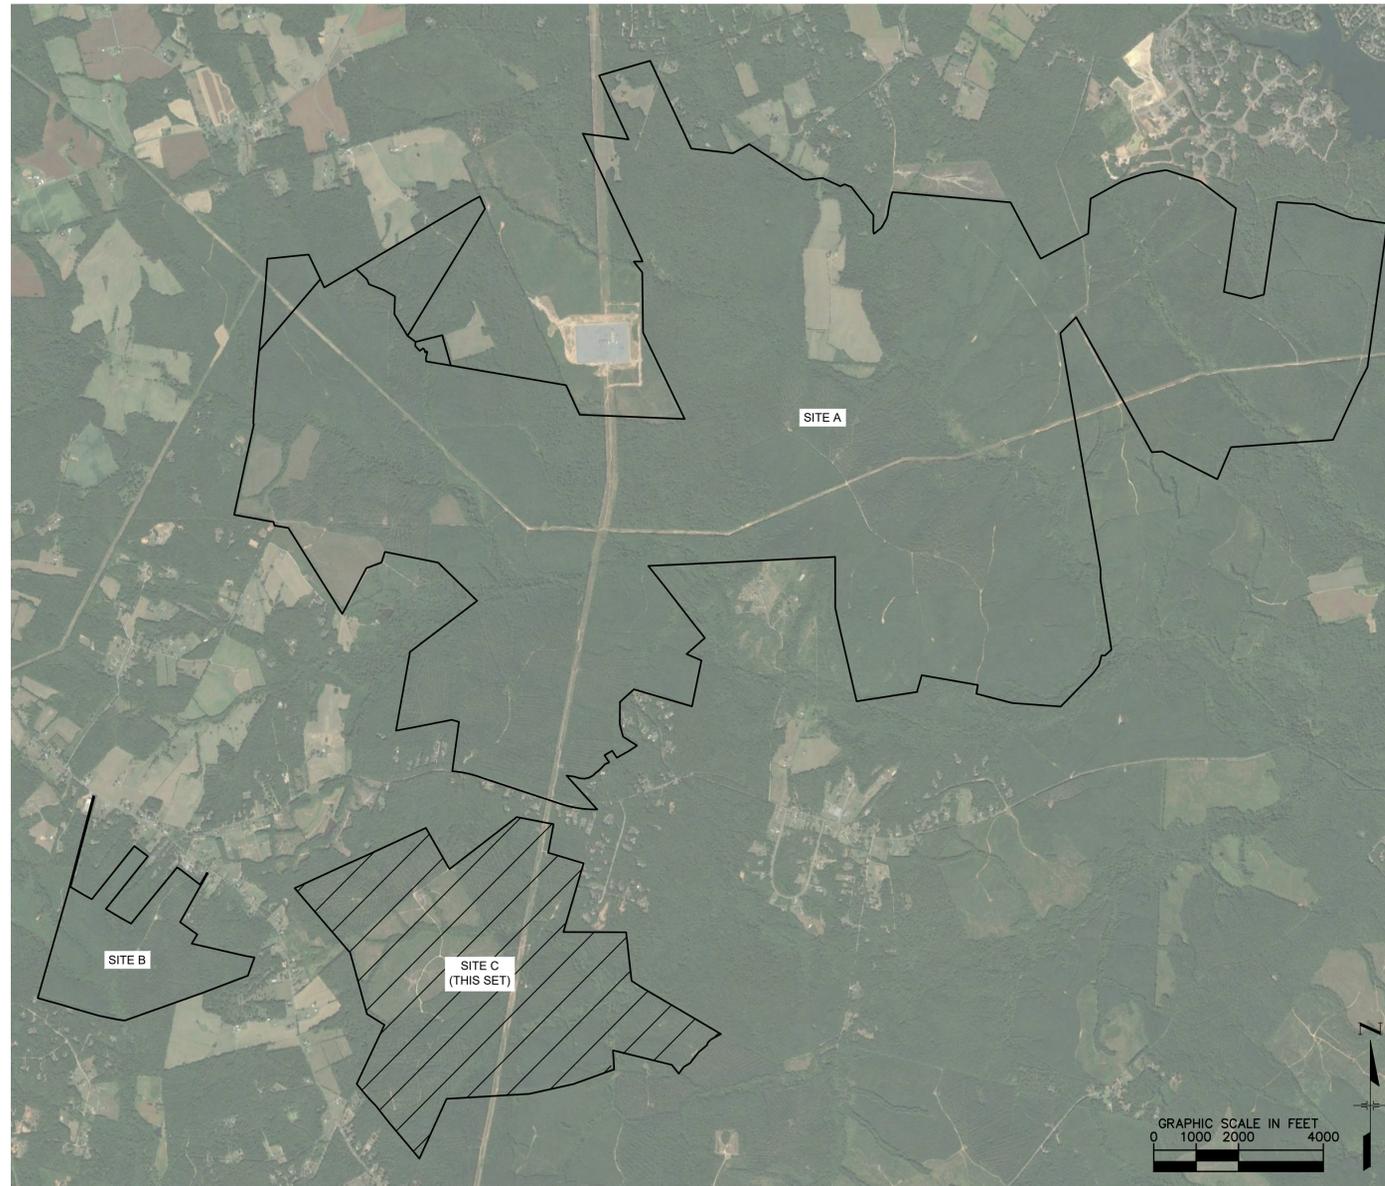

VICINITY MAP - PROJECT LIMITS  
1" = 2,000'

Sheet List Table	
Sheet No.	Sheet Title
C-01	GENERALIZED DEVELOPMENT PLAN COVER
EX-3-1	GENERALIZED DEVELOPMENT PLAN
EX-3-2	GENERALIZED DEVELOPMENT PLAN - 2
EX-3-3	PRESERVATION AREA PLAN
EX-3-4	LANDSCAPE AND BUFFER AREA PLAN
EX-3-5	ACCESS ROAD SERVICE AREAS
EX-3-6	COUNTY TRAIL OVERLAY PLAN
CD-1	CIVIL DETAILS
SHEETS 1-17	ALTA SURVEY

PROJECT INFORMATION - SITE C		
OWNER INFORMATION		
OWNER	TAX MAP PARCEL NUMBER	
RIVEROAK TIMBERLAND INVESTMENTS LLC	43-A-3	
RIVEROAK TIMBERLAND INVESTMENTS LLC	29-A-7	
NO KNOWN AIRPORTS WITHIN 5-MILE RADIUS OF SITE C.		
CULTURAL RESOURCES		
NO KNOWN HISTORIC BUILDINGS OR FEATURES WITHIN PROXIMITY OF SITE.		
TRAFFIC INFORMATION		
<ul style="list-style-type: none"> <li>VOLUMES SUBJECT TO CHANGE BASED ON TRAFFIC IMPACT STUDY RESULTS</li> <li>SEE TRAFFIC IMPACT ANALYSIS AND EXHIBITS FOR ADDITIONAL TRAFFIC DISTRIBUTION AND RECOMMENDATIONS</li> <li>PROPOSED CONSTRUCTION TRAFFIC: 300 VEHICLES PER DAY</li> </ul>		
IMPERVIOUS AREAS*		
	TOTAL	AREA (SF)
SOLAR PANEL POST**	38094	4190
(0.11 SF EACH)		0.10
INVERTER PAD	22	8800
(40' X 10')		0.20
GRAVEL DRIVES	29336 LF	352035
(12' WIDTH)		8.08
TOTAL IMPERVIOUS ACRES		8.38
TOTAL IMPERVIOUS % OF SITE		0.92%
*IMPERVIOUS AREAS SHOWN FOR THE SITE ARE FOR PRELIMINARY USE ONLY. NOT TO BE USED FOR DESIGN PURPOSES.		
**PER DEQ REGULATIONS, ONLY POLE MOUNTINGS FOR THE SOLAR PANELS ARE TO BE USED TO CALCULATE IMPERVIOUS AREA. ASSUMED SPACING OF 15' SUBJECT TO FINAL ENGINEERING.		
WATER QUALITY (VRRM)**		
TP LOAD REDUCTION REQUIRED (LB/YR)	19.61	
ACRES PLACED IN CONSERVATION AREA	224.11	
***WATER QUALITY VALUES SHOWN FOR THE SITE ARE FOR PRELIMINARY USE ONLY. NOT TO BE USED FOR DESIGN PURPOSES.		

**SOLID WASTE DISPOSAL CALCULATIONS FOR CONSTRUCTION FOR SITES A, B, AND C**



Step 1: Identification of Collection Method					Step 2: Determination of Minimum Storage Capacity				
Container Type (Compost, Roll Off, Dumpster, Cart)	Scale (Cubic Yards)	Number of Containers	Number of Pickups Per Week	Material (Trash or Recycle)	Combined Annual Waste Stream (Cubic Yards Per Ton)	Number of Annual Collections (Minimum 2)	Number of Containers (Minimum 2)	Minimum Size of Each Storage Container or Dumpster (Cubic Yards)	Minimum Size of Each Storage Container or Dumpster (Cubic Yards)
Domestic	40 YD	2	1	Trash	4.44	2	2	0.14	
Domestic	40 YD	2	2	Recycle	4.44	2	2	0.14	
Spotsylvania County Non-Residential Waste Generation Report					Spotsylvania County Non-Residential Waste Generation Report				
Building Use (Office, Industrial, Food/Restaurant, Public Facility, Elementary School, Warehouse)	Floor Area (square feet)	Annual Waste Generation Rate (lb/yr/sq ft)	Annual Waste Generation Rate (lb/yr/sq ft)	Annual Waste Generation Rate (lb/yr/sq ft)	Combined Annual Waste Stream (Cubic Yards)	Number of Annual Collections (Minimum 2)	Number of Containers (Minimum 2)	Minimum Size of Each Storage Container or Dumpster (Cubic Yards)	Minimum Size of Each Storage Container or Dumpster (Cubic Yards)
Office	200	0.0013	0.26	0	4.44	2	2	0.14	
Industrial	X	0.0016	0	0					
Food/Restaurant	X	0.0007	0	0					
Public Facility	X	0.0005	0	0					
Elementary School	X	0.0005	0	0					
Warehouse	X	0.0015	0	0					
Combined Annual Waste Stream					Combined Annual Waste Stream				
					4.88				

APPROVAL  
COMMONWEALTH OF VIRGINIA  
SEAN MILLOT  
Lic. No. 0402052332  
11/20/2018  
PROFESSIONAL ENGINEER

KHA PROJECT 116626000  
DATE 11/20/2018  
SCALE AS SHOWN  
DESIGNED BY JREB  
DRAWN BY JREB  
CHECKED BY SMIM


SUP 18-0003  
GENERALIZED DEVELOPMENT PLAN COVER  
SPOTSYLVANIA SOLAR ENERGY CENTER C  
PREPARED FOR S-POWER  
SPOTSYLVANIA COUNTY VIRGINIA  
SHEET NUMBER C-01

This document, together with the concepts and designs presented herein, is intended only for the specific purpose and client for which it was prepared. Reuse of and improper reliance on this document without written authorization and adaptation by Kimley-Horn and Associates, Inc. shall be without liability to Kimley-Horn and Associates, Inc.

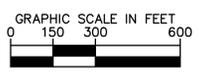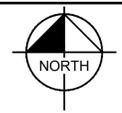

**LEGEND**

	PROPERTY LINE
	INTERNAL PROPERTY LINE
	BUILDABLE AREA
	DELINEATED WETLANDS
	EXISTING OVERHEAD ELECTRIC
	EXISTING OHE EASEMENT
	PROPOSED 10' - 16' ACCESS ROAD
	PROPOSED EASEMENT CROSSING
	PROPOSED WETLAND CROSSING
	MINIMUM 50' SETBACK/ALLOWING NATURAL REGROWTH
	PROPOSED 50' BUFFER/SETBACK REFERENCE BUFFER PLAN FOR DETAILS
	PROPOSED CHAIN LINK FENCE
	PROPOSED PROJECT ACCESS POINT
	POTENTIAL STORMWATER CATCHMENT POND
	FEMA 100-YEAR FLOODPLAIN
	SOLAR PANEL ARRAY AND INVERTER

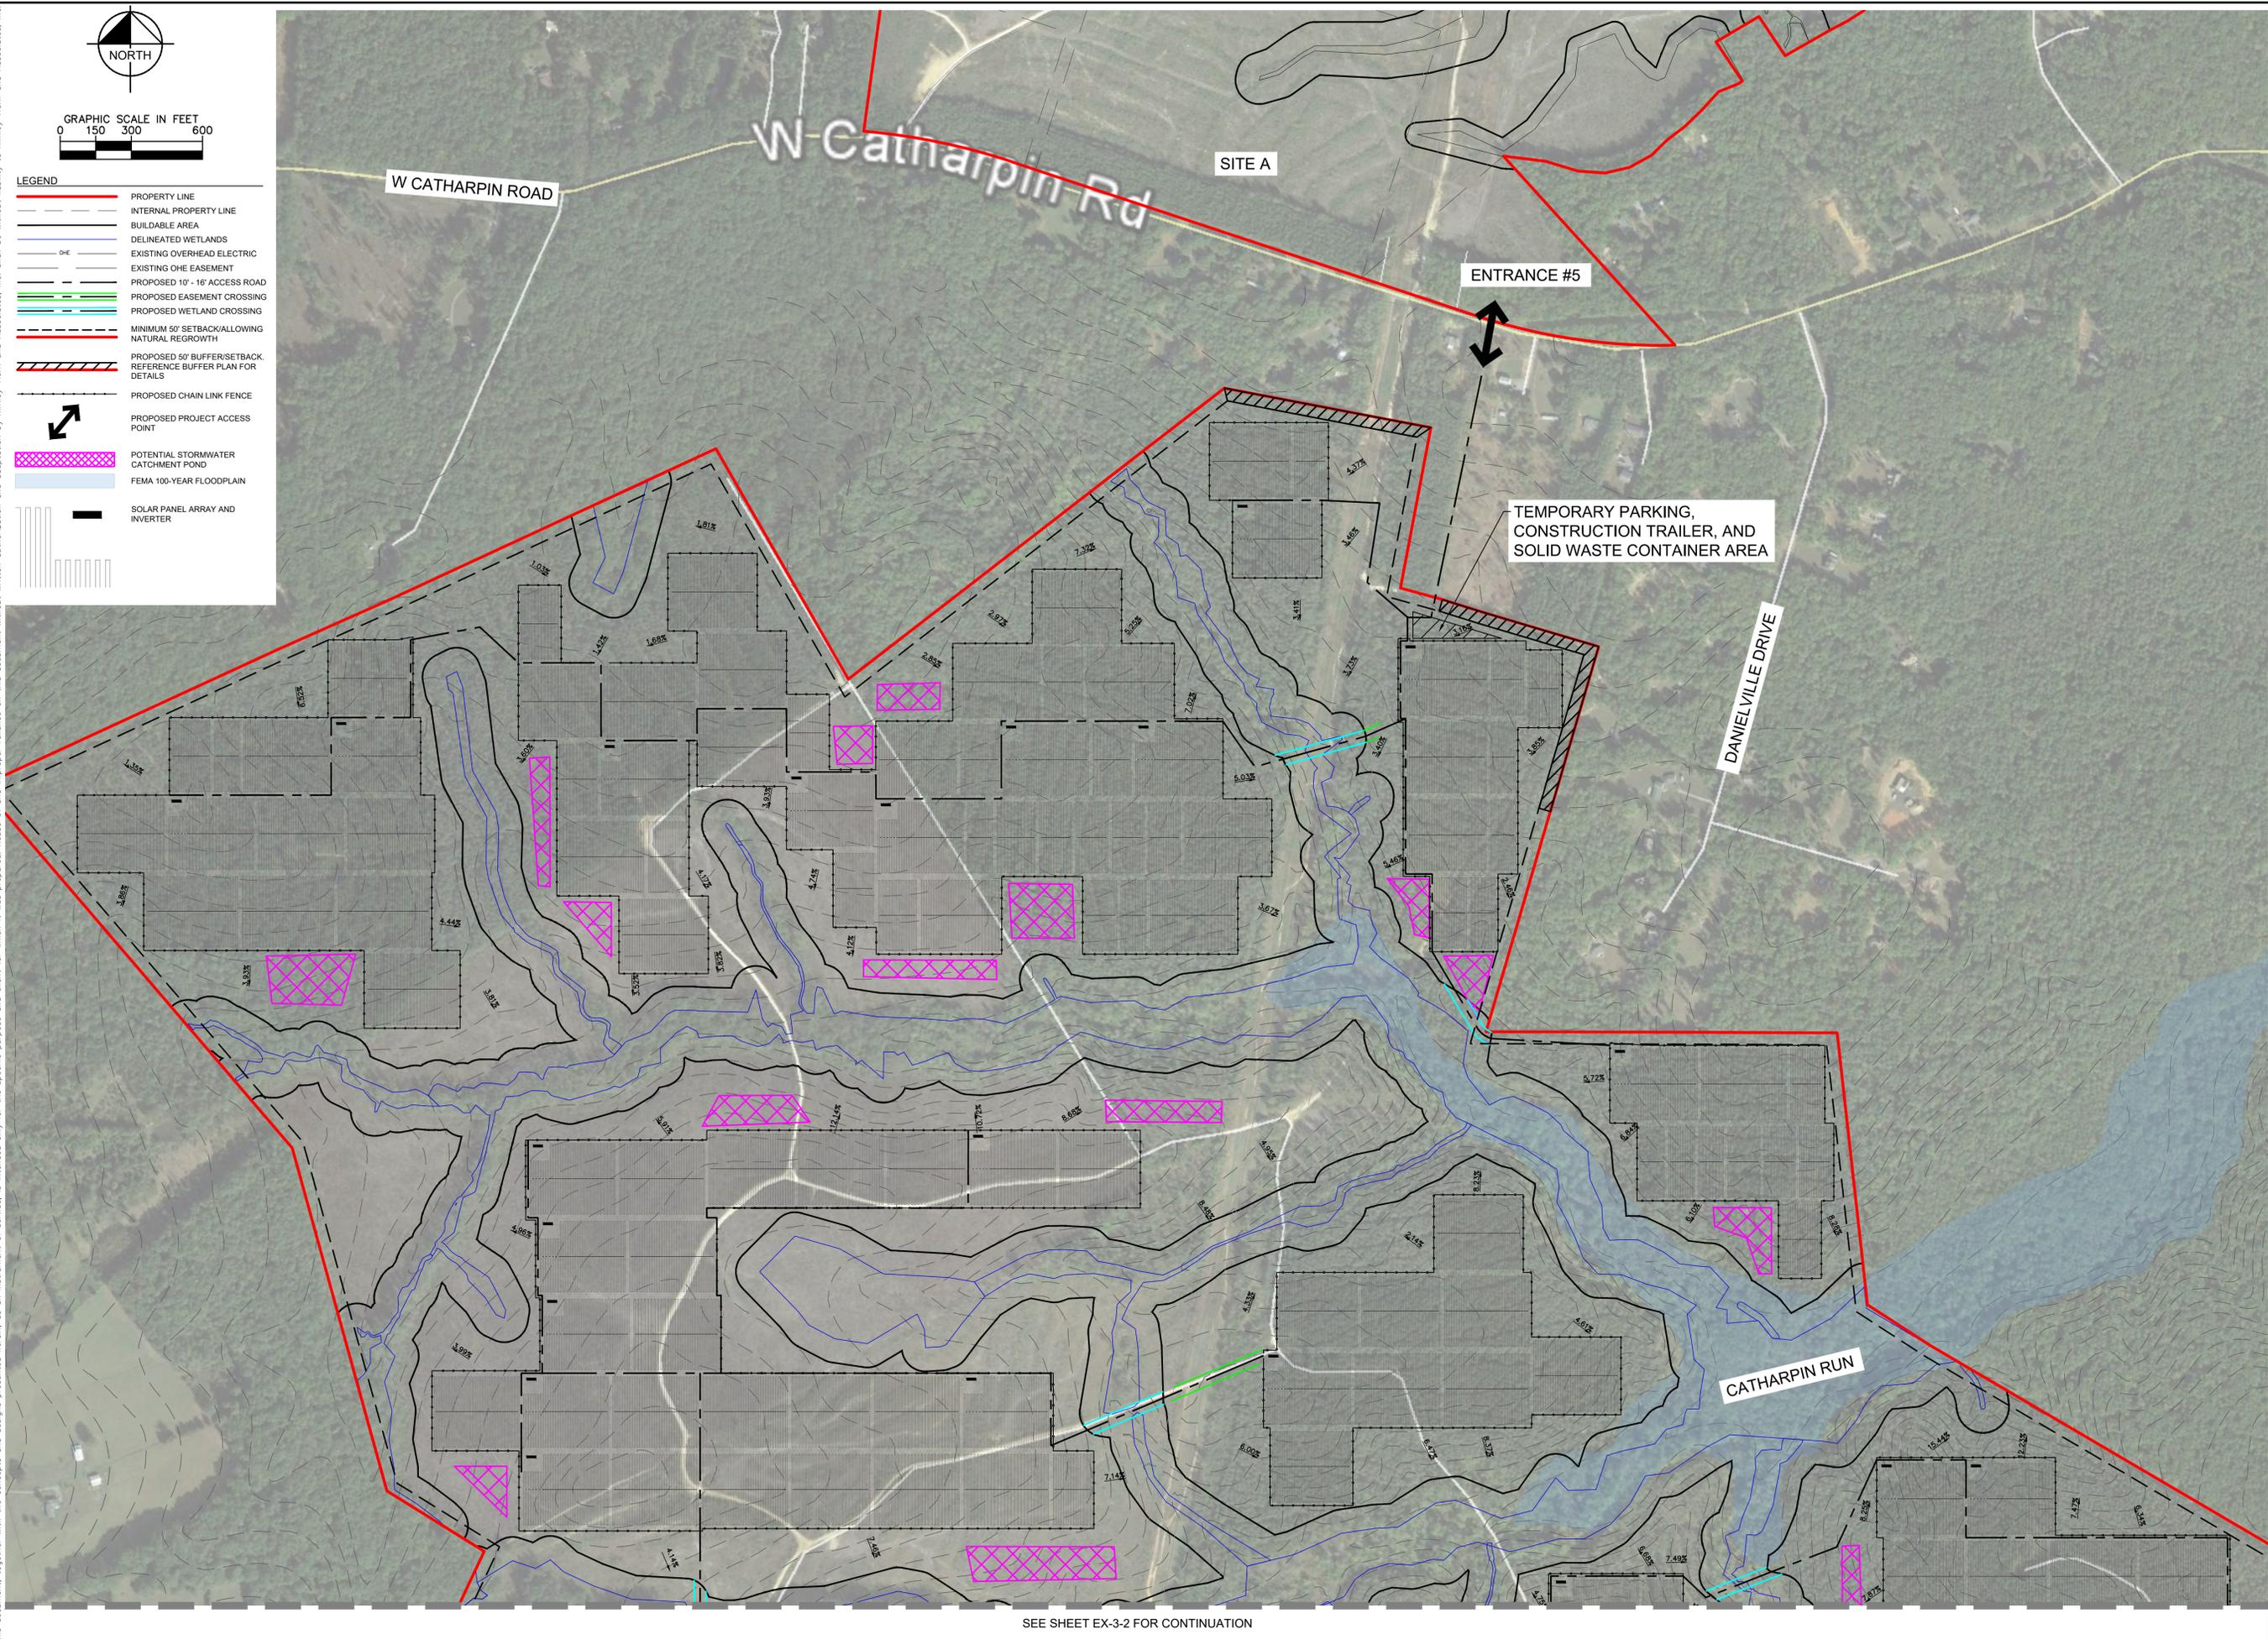

SEE SHEET EX-3-2 FOR CONTINUATION

**S-POWER**  
An AES and AIMCo Company

2180 SOUTH 1300 EAST, SUITE 600  
SALT LAKE CITY, UT 84106  
PHONE: 801-679-3500 FAX: 801-679-3501  
WWW.S-POWER.COM

**Kimley-Horn**

© 2018 KIMLEY-HORN AND ASSOCIATES, INC.  
11400 COMMERCE PARK DR, SUITE 400  
RESTON, VA 20191  
PHONE: 703-874-1300  
WWW.KIMLEY-HORN.COM

APPROVAL



KHA PROJECT	116626000
DATE	10/26/2018
SCALE	AS SHOWN
DESIGNED BY	JRE
DRAWN BY	JRE
CHECKED BY	SMW

**SUP 18-0003**  
**GENERALIZED**  
**DEVELOPMENT PLAN**


**SPOTSYLVANIA SOLAR**  
**ENERGY CENTER C**  
PREPARED FOR  
**S-POWER**

SPOTSYLVANIA COUNTY VIRGINIA

SHEET NUMBER  
**EX-3-1**




This document, together with the concepts and designs presented herein, is intended only for the specific purpose and client for which it was prepared. Reuse of and improper reliance on this document without written authorization and adaptation by Kimley-Horn and Associates, Inc. shall be without liability to Kimley-Horn and Associates, Inc.

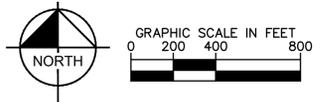

ANTICIPATED PRESERVED AREAS. FINAL PRESERVATION AREAS TO BE DETERMINED DURING FINAL SITE PLAN. VEGETATION WITHIN PRESERVATION AREAS WILL BE ALLOWED TO GROW BACK NATURALLY. SOME AREAS MAY BE RE-SEEDING WITH PRE-APPROVED SEED MIX.

**PRESERVATION AREA**  
DO NOT DISTURB  
**SIGN DETAIL**  
N.T.S.

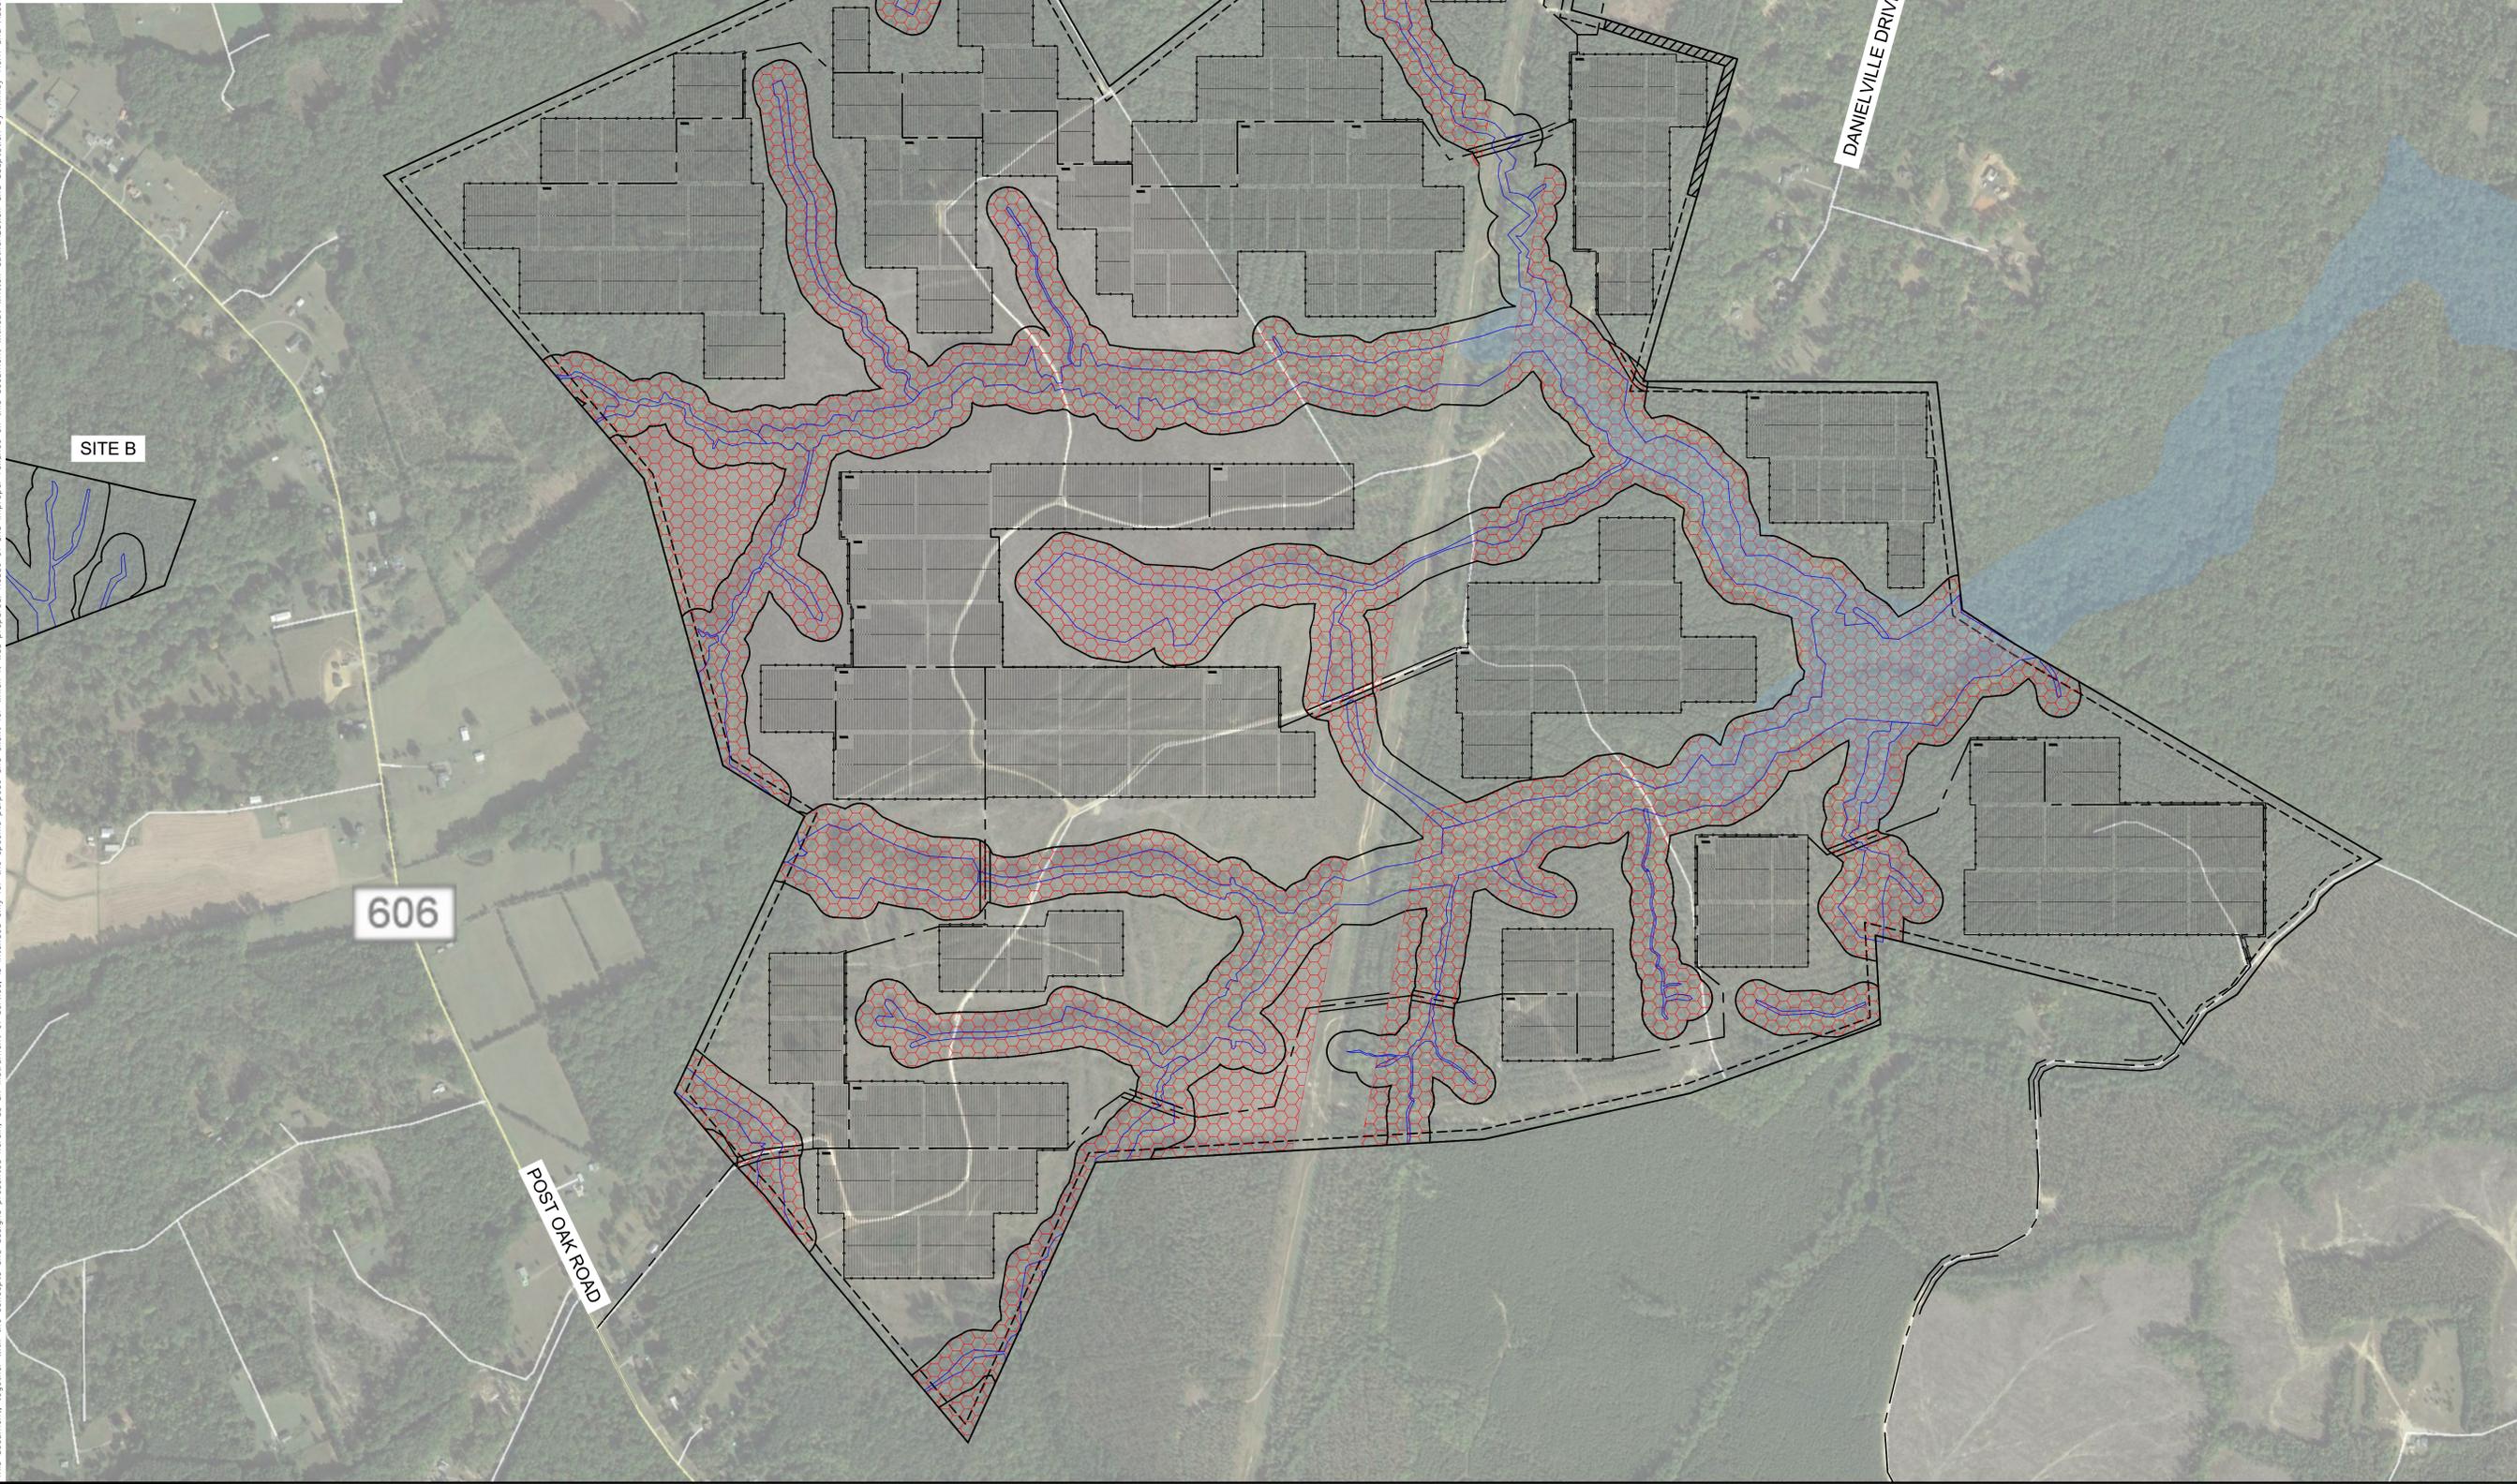

SITE B

606

POST OAK ROAD


W CATHARPIN ROAD

DANIELVILLE DRIVE

SPOTSYLVANIA SOLAR ENERGY CENTER C  
PREPARED FOR S-POWER

SUP 18-0003  
PRESERVATION AREA PLAN

KHA PROJECT	116626000
DATE	10/26/2018
SCALE	AS SHOWN
DESIGNED BY	JRE
DRAWN BY	JRE
CHECKED BY	SMH

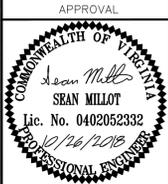


**Kimley-Horn**  
© 2018 KIMLEY-HORN AND ASSOCIATES, INC.  
11400 COMMERCE PARK DR., SUITE 400  
RESTON, VA 20191  
PHONE: 703-874-1300  
WWW.KIMLEY-HORN.COM

**S-POWER**  
An AES and AIMCo Company  
2180 SOUTH 1300 EAST, SUITE 600  
SALT LAKE CITY, UT 84106  
PHONE: 801-679-3500, FAX: 801-679-3501  
WWW.SPOWER.COM

SHEET NUMBER  
**EX-3-3**




This document, together with the concepts and designs presented herein, is intended only for the specific purpose and client for which it was prepared. Reuse of and improper reliance on this document without written authorization and adaptation by Kimley-Horn and Associates, Inc. shall be without liability to Kimley-Horn and Associates, Inc.

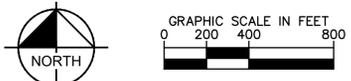

- ▬ PROPOSED RE-VEGETATION WITH PLANTINGS PER OPTION 1 OR OPTION 2 (SEE DETAIL THIS SHEET)
- ▬ PROPOSED RE-VEGETATION WITH SAPPLINGS
- ▬ 50' MINIMUM SETBACK WITH PRESERVED VEGETATION
- ▬ 50' MINIMUM SETBACK ALLOWING VEGETATION TO GROW BACK NATURALLY

- BUILDING WITHIN 100' OF PARCEL BOUNDARY
- BUILDING WITHIN 200' OF PARCEL BOUNDARY
- BUILDING WITHIN 300' OF PARCEL BOUNDARY

- NOTES:**
1. BUFFER LOCATIONS SHOWN ARE APPROXIMATE AND ARE BASED ON INITIAL PANEL PROXIMITY TO ROADWAYS AND ADJACENT PROPERTIES.
  2. PLANTINGS SHALL BE PER OPTION 1 AND/OR OPTION 2 DEPENDING ON PLANT AVAILABILITY AT TIME OF SITE PLAN AND DESIRE TO ADD VARIABILITY TO THE BUFFERS.

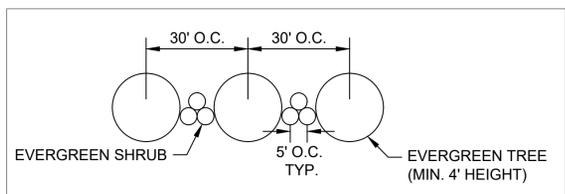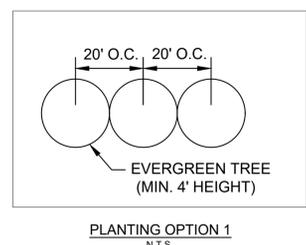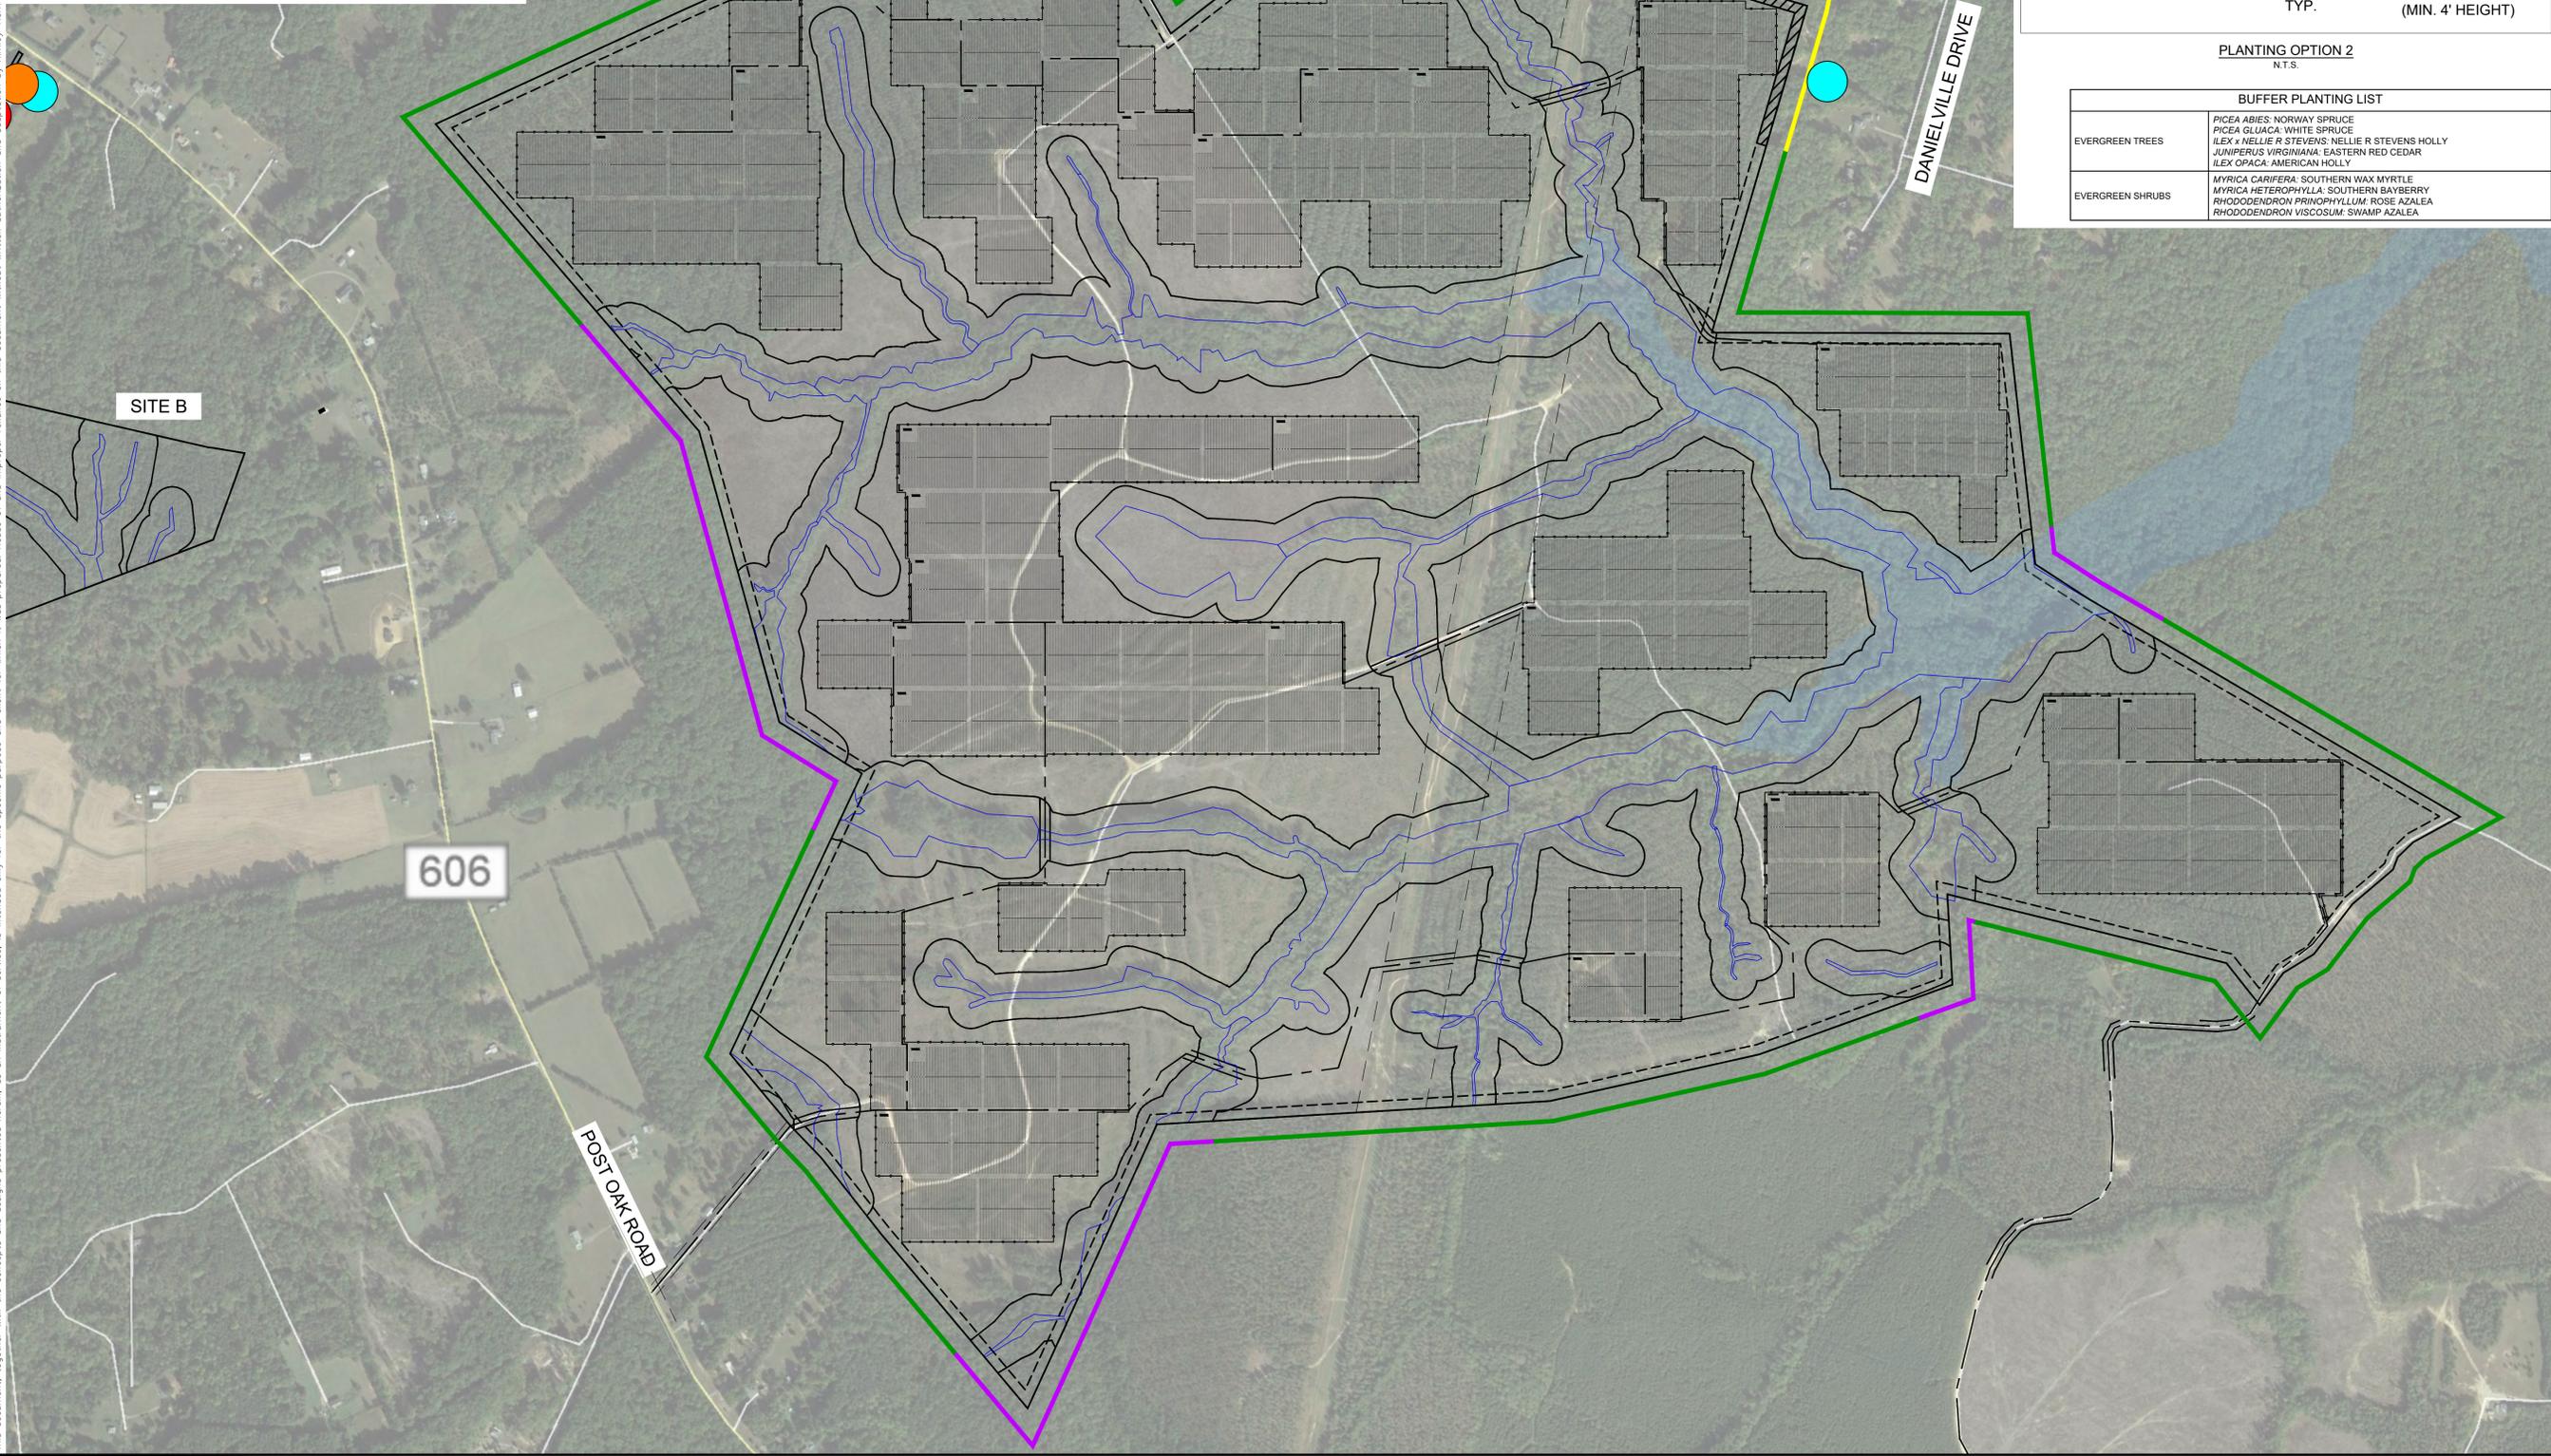

BUFFER PLANTING LIST	
EVERGREEN TREES	PICEA ABIES: NORWAY SPRUCE PICEA GLAUCA: WHITE SPRUCE ILEX x NELLIE R STEVENS: NELLIE R STEVENS HOLLY JUNIPERUS VIRGINIANA: EASTERN RED CEDAR ILEX OPACA: AMERICAN HOLLY
EVERGREEN SHRUBS	MYRTICA CARIFERA: SOUTHERN WAX MYRTLE MYRTICA HETEROPHYLLA: SOUTHERN BAYBERRY RHODODENDRON PRINOPHYLLUM: ROSE AZALEA RHODODENDRON VISCOSUM: SWAMP AZALEA

**S-POWER**  
An AES and AIMCo Company  
2180 SOUTH 1300 EAST, SUITE 600  
SALT LAKE CITY, UT 84106  
PHONE: 801-679-3500 FAX: 801-679-3501  
WWW.S-POWER.COM

**Kimley-Horn**  
© 2018 KIMLEY-HORN AND ASSOCIATES, INC.  
11400 COMMERCE PARK DR, SUITE 400  
RESTON, VA 20191  
PHONE: 703-674-1300  
WWW.KIMLEY-HORN.COM


APPROVAL

SEAN MILLOT  
Lic. No. 0402052332  
10/26/2018  
PROFESSIONAL ENGINEER

KHA PROJECT	116626000
DATE	10/26/2018
SCALE	AS SHOWN
DESIGNED BY	JRE
DRAWN BY	JRE
CHECKED BY	SMH


**SUP 18-0003**  
**LANDSCAPE AND BUFFER**  
**AREA PLAN**

**SPOTSYLVANIA SOLAR**  
**ENERGY CENTER C**  
PREPARED FOR  
**S-POWER**

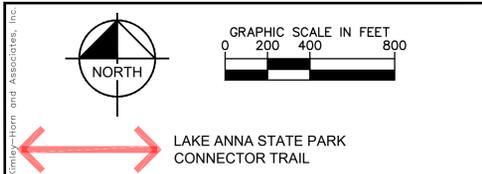

LAKE ANNA STATE PARK CONNECTOR TRAIL

NOTES:  
 1. TRAILS SHOWN ARE BASED ON THE SPOTSYLVANIA "TRAILWAYS MASTER PLAN" APPROVED IN 2011.  
 2. ALL TRAILS ARE OUTSIDE THE PANEL LAYOUT AREAS, AND THEREFORE, WILL NOT COMPROMISE THE IMPLEMENTATION OF THE TRAILWAYS MASTER PLAN.

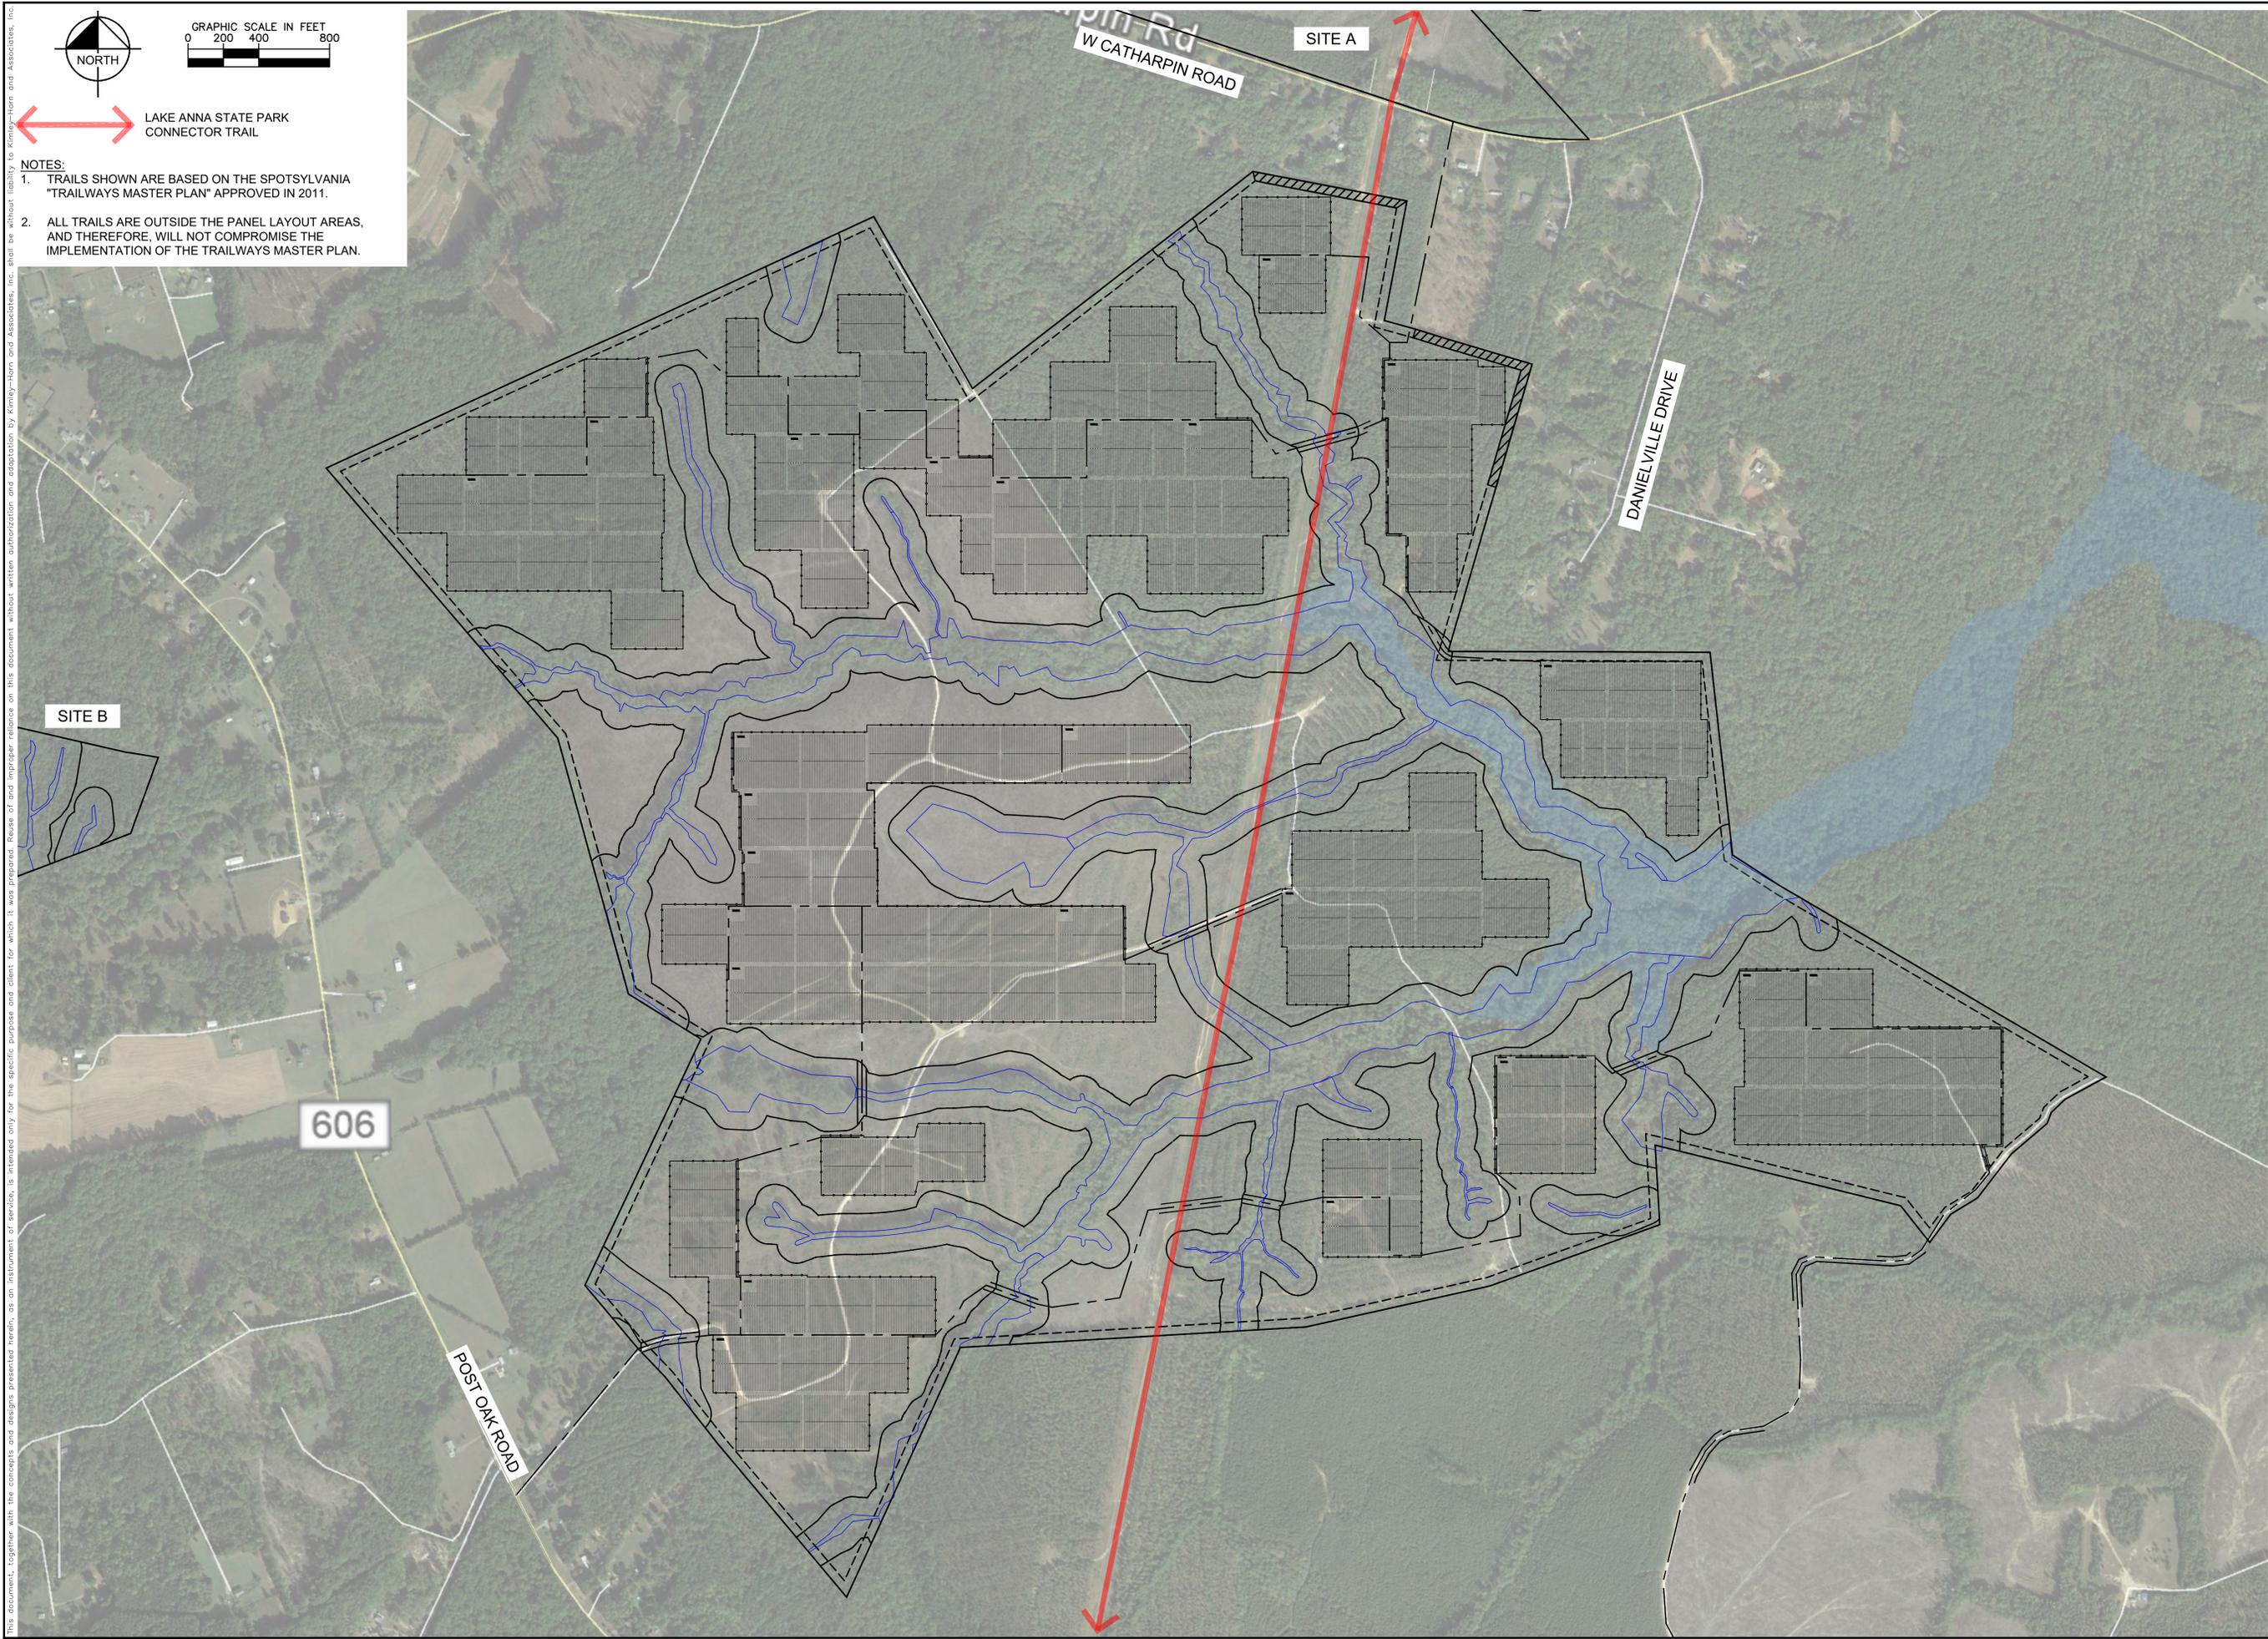

This document, together with the concepts and designs presented herein, is intended only for the specific purpose and client for which it was prepared. Reuse of and improper reliance on this document without written authorization and adaptation by Kimley-Horn and Associates, Inc. shall be without liability to Kimley-Horn and Associates, Inc.

**S-POWER**  
 An AES and AIMCo Company

2180 SOUTH 1300 EAST, SUITE 600  
 SALT LAKE CITY, UT 84106  
 PHONE: 801-679-3500, FAX: 801-679-3501  
 WWW.S-POWER.COM

**Kimley-Horn**

© 2018 KIMLEY-HORN AND ASSOCIATES, INC.  
 11400 COMMERCE PARK DR., SUITE 400  
 RESTON, VA 20191  
 PHONE: 703-674-1300  
 WWW.KIMLEY-HORN.COM

APPROVAL





KHA PROJECT	116626000
DATE	10/26/2018
SCALE	AS SHOWN
DESIGNED BY	JRE
DRAWN BY	JRE
CHECKED BY	SMW

SUP 18-0003  
 COUNTY TRAIL OVERLAY  
 PLAN

SPOTSYLVANIA SOLAR  
 ENERGY CENTER C  
 PREPARED FOR  
 S-POWER

SHEET NUMBER  
 EX-3-6


This document, together with the concepts and designs presented herein, is intended only for the specific purpose and client for which it was prepared. Reuse of and improper reliance on this document without written authorization and adaptation by Kimley-Horn and Associates, Inc. shall be without liability to Kimley-Horn and Associates, Inc.

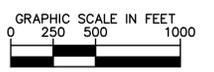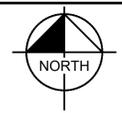

**LEGEND**

- PROPERTY LINE
- BUILDBLE AREA
- DELINEATED WETLANDS
- EXISTING OVERHEAD ELECTRIC
- EXISTING OHE EASEMENT
- PROPOSED 10' - 16' ACCESS ROAD
- PROPOSED EASEMENT CROSSING
- PROPOSED WETLAND CROSSING
- - - MINIMUM 50' SETBACK/ALLOWING NATURAL REGROWTH
- - - PROPOSED 50' BUFFER/SETBACK REFERENCE BUFFER PLAN FOR DETAILS
- - - PROPOSED CHAIN LINK FENCE WITH BARBED WIRE
- MAIN ACCESS ROAD ROUTE
- ↔ PROPOSED PROJECT ACCESS POINT
- ▬ SOLAR PANEL ARRAY AND INVERTER

ACCESS ROAD DETAILS				
ENTRANCE #	EASEMENT WIDTH	ROAD WIDTH	ESTIMATED TRANSPORTATION LOAD	VEHICLE ACCESS
5	50'	20'	HEAVY	ALL
6	50'	20'	HEAVY	ALL
7	50'	20'	HEAVY	ALL

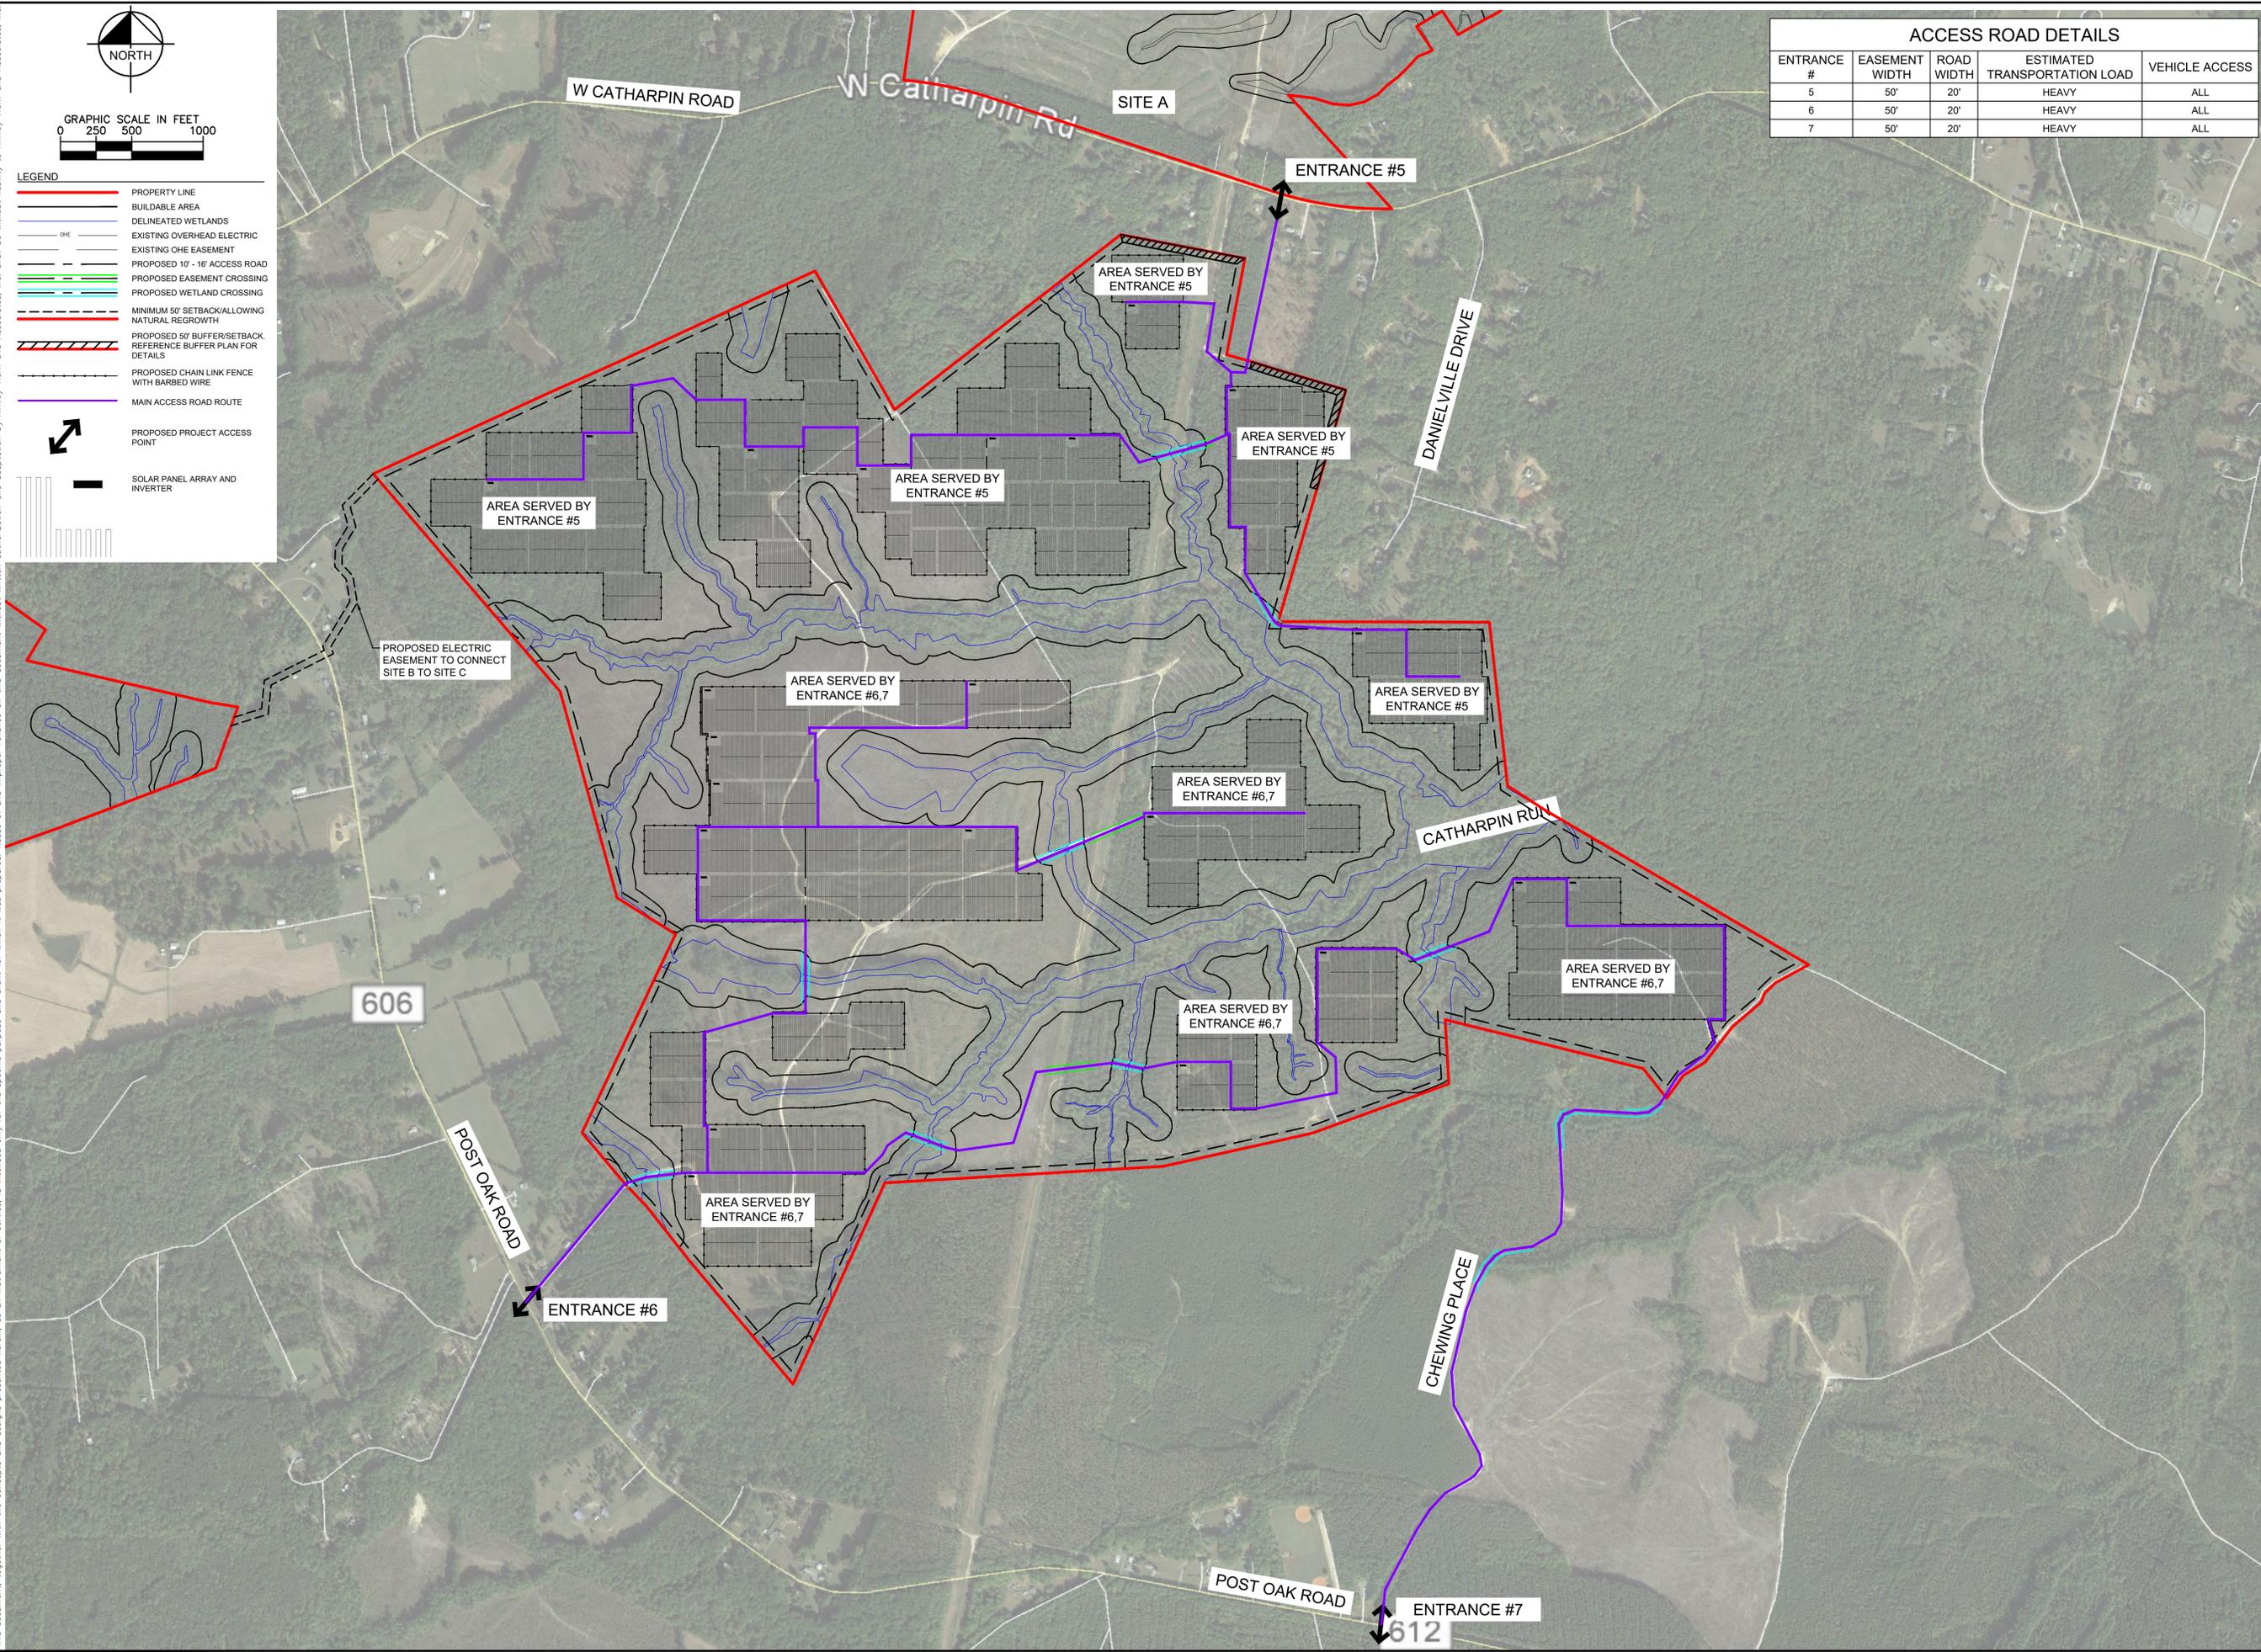


**S-POWER**  
An AES and AIMCo Company

2180 SOUTH 1300 EAST, SUITE 600  
SALT LAKE CITY, UT 84106  
PHONE: 801-679-3500 FAX: 801-679-3501  
WWW.SPOWER.COM

**Kimley-Horn**  
© 2018 KIMLEY-HORN AND ASSOCIATES, INC.  
11400 COMMERCE PARK DR, SUITE 400  
RESTON, VA 20191  
PHONE: 703-874-1300  
WWW.KIMLEY-HORN.COM

APPROVAL

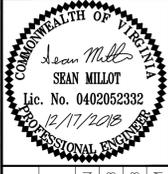

KHA PROJECT	116626000
DATE	12/17/2018
SCALE	AS SHOWN
DESIGNED BY	JRE
DRAWN BY	JRE
CHECKED BY	SMH


SUP 18-0003  
ACCESS ROAD SERVICE  
AREAS

SPOTSYLVANIA SOLAR  
ENERGY CENTER C  
PREPARED FOR  
S-POWER


SPOTSYLVANIA COUNTY VIRGINIA

SHEET NUMBER  
**EX-3-5**


This document, together with the concepts and designs presented herein, is intended only for the specific purpose and client for which it was prepared. Reuse of and improper reliance on this document without written authorization and adaptation by Kimley-Horn and Associates, Inc. shall be without liability to Kimley-Horn and Associates, Inc.

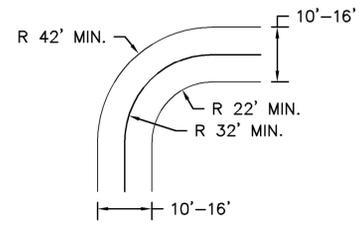


**TYPICAL SITE ACCESS ROAD 90° TURN**  
N.T.S.

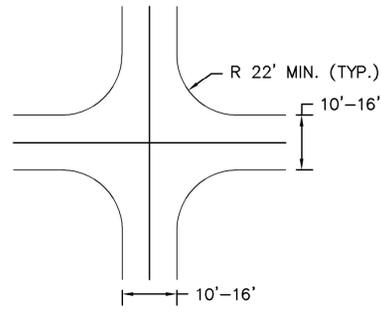

**TYPICAL SITE ACCESS ROAD 4-WAY INTERSECTION**  
N.T.S.

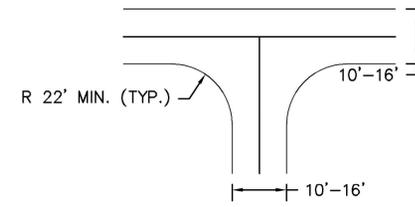


**TYPICAL SITE ACCESS ROAD "T" - INTERSECTION**  
N.T.S.

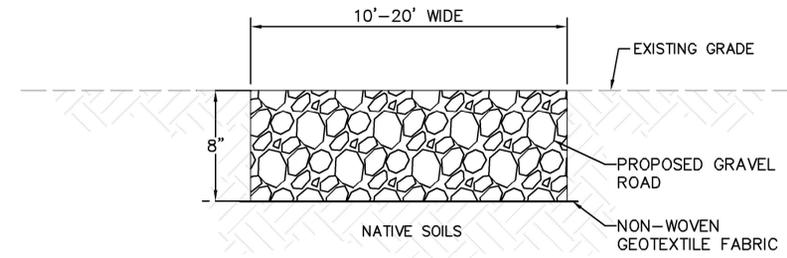


**NOTES:**

1. REMOVE ALL GRASSES AND ORGANICS WITHIN ACCESS ROAD AREA.
2. SCARIFY, MOISTURE CONDITION, AND RE-COMPACT EXISTING NATIVE SOILS TO 90% OF THE MATERIAL'S ASTM D-1557 MAXIMUM DRY DENSITY.
3. COMPACTION SHALL BE VERIFIED BY THE GEOTECHNICAL CONSULTANT.


**TYPICAL SITE ACCESS ROAD - GRAVEL ROAD SECTION**  
N.T.S.

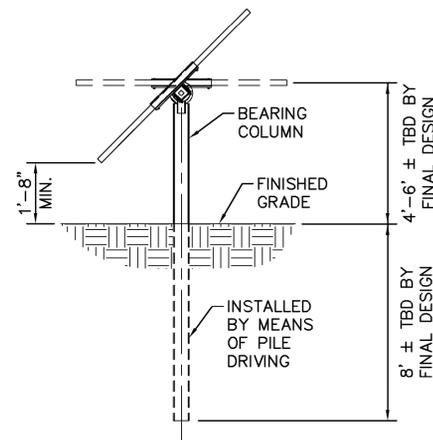


**TRACKER RACK AND FOUNDATION DETAIL**  
N.T.S.  
NOTE: ACTUAL CONSTRUCTION DETAIL OF TRACKER RACK AND FOUNDATION MAY VARY FROM THIS DETAIL.

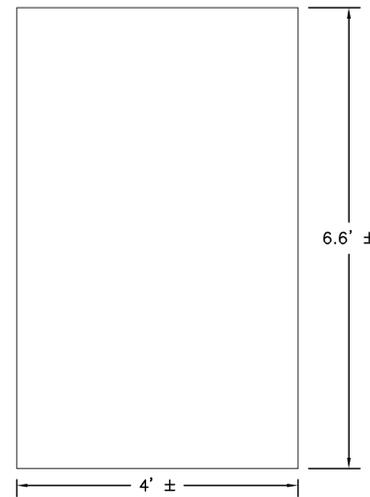


**MODULE DETAIL**  
N.T.S.  
NOTE: ACTUAL CONSTRUCTION DETAIL OF MODULE MAY VARY FROM THIS DETAIL.

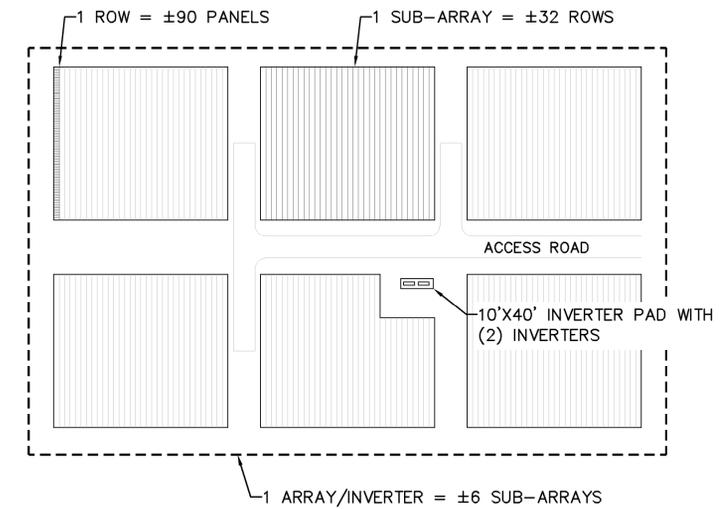


**INVERTER BLOCK EXAMPLE**  
N.T.S.  
NOTE: INVERTER PAD APPROXIMATELY 10'X40' WITH (2) 9'LX5.5'WX7.5'H INVERTERS SUBJECT TO FINAL ENGINEERING.

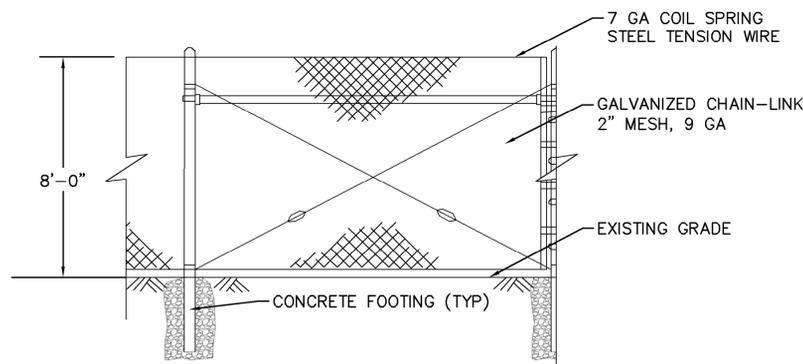

**CHAIN LINK SECURITY FENCE**  
N.T.S.

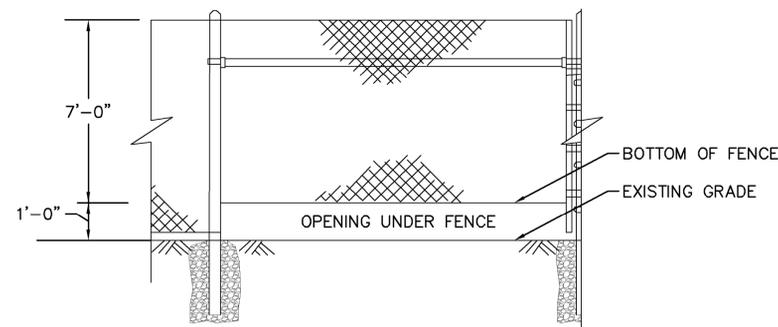

**WILDLIFE FENCE**  
N.T.S.  
NOTE: WILDLIFE FENCE WILL SPACED EVERY 2000 FEET ALONG FENCE LINE SUBJECT TO ENGINEERING AND SITE DESIGN.

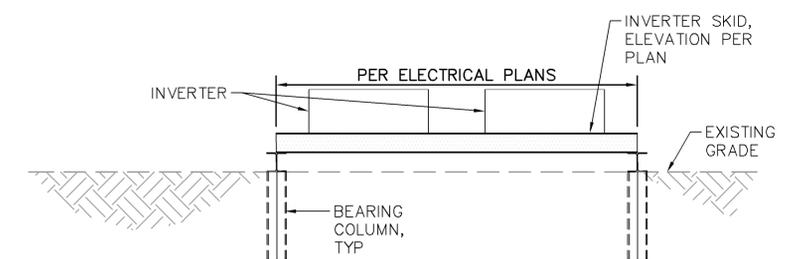

**INVERTER DETAIL**  
N.T.S.  
NOTE: INVERTER PAD APPROXIMATELY 10'X40' WITH (2) 9'LX5.5'WX7.5'H INVERTERS SUBJECT TO FINAL ENGINEERING.