



GENERALIZED DEVELOPMENT PLANS

SPOTSYLVANIA SOLAR ENERGY CENTER A

SPECIAL USE PERMIT - SUP 18-0001

LIVINGSTON MAGISTERIAL DISTRICT

SPOTSYLVANIA COUNTY, VA

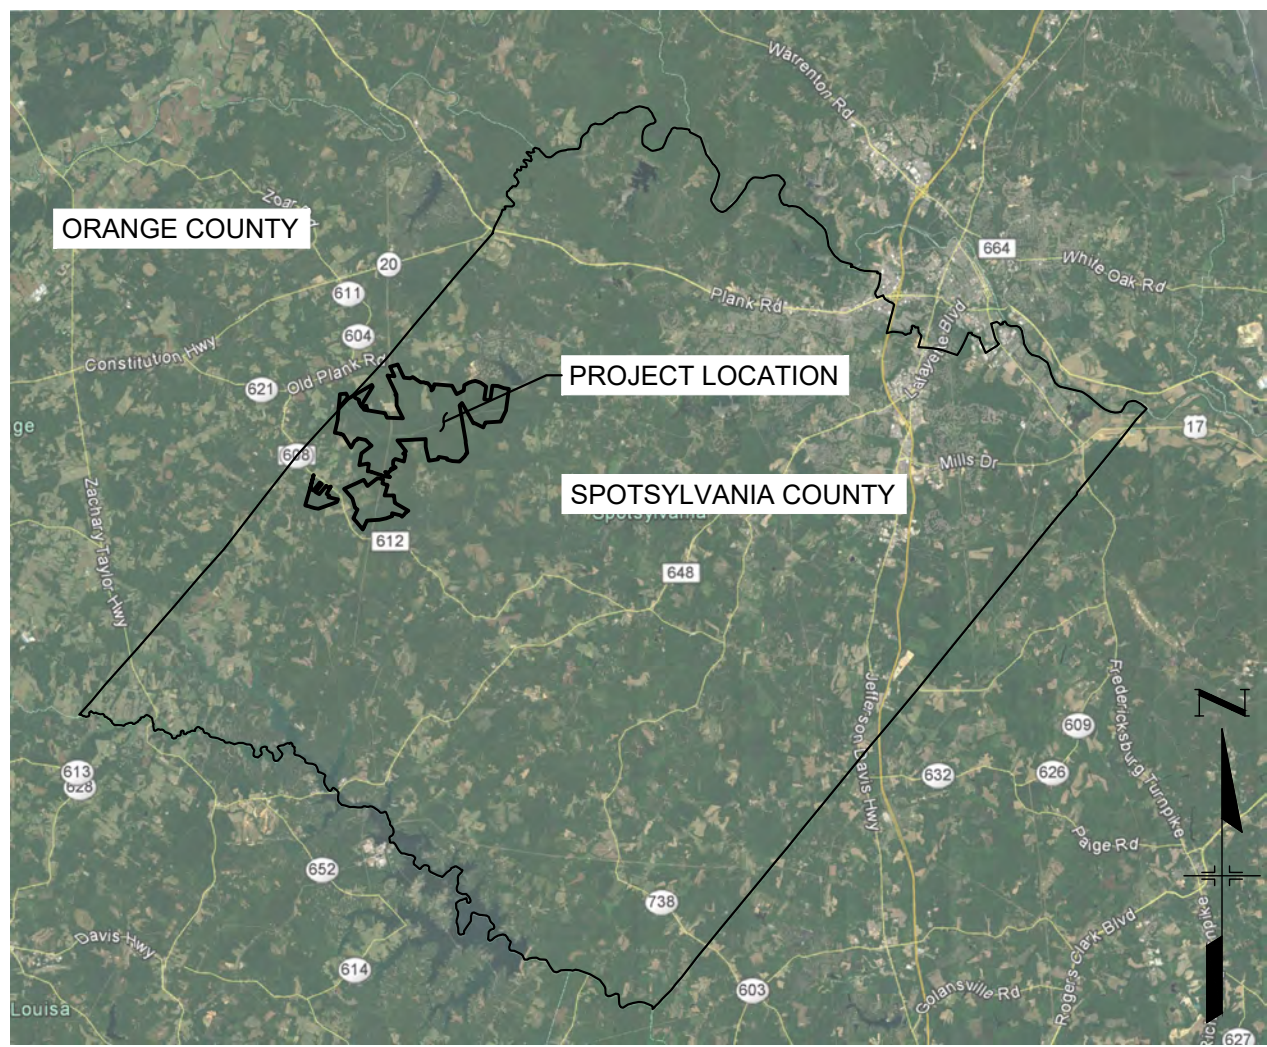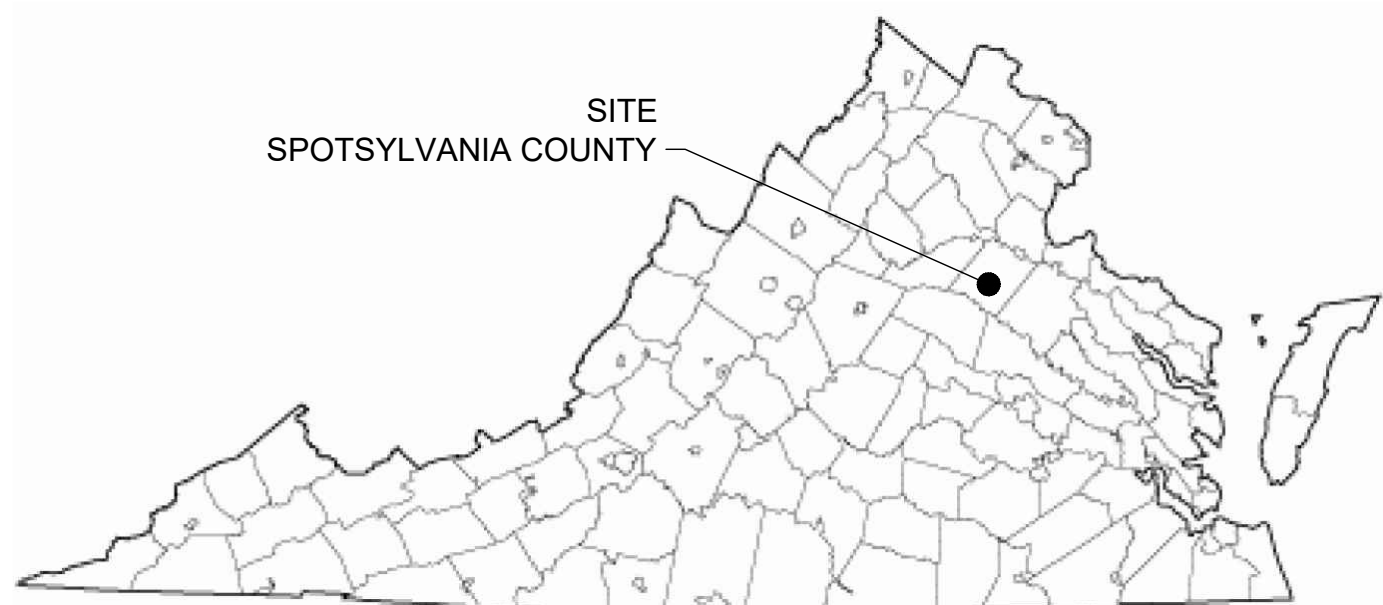

VICINITY MAP - SPOTSYLVANIA COUNTY, VA
1" = 30,000'


SPOTSYLVANIA SOLAR ENERGY CENTER	
OWNER	sPOWER
EXISTING AND PROPOSED ZONING	AGRICULTURE 3 (A-3)
EXISTING USE	SILVICULTURE
PROPOSED USE	SOLAR ENERGY FACILITY
TOTAL POWER TO BE GENERATED	500 MEGAWATTS AC (MWac)
OVERALL PROJECT SITE DATA:	
PROPERTY AREA	6,350 ACRES
DISTURBED AREA	3,500 ACRES
POWER GENERATED	500 MWac
SITE A DATA:	
PROPERTY AREA	5,200 ACRES
DISTURBED AREA	2,800 ACRES
POWER GENERATED	400 MWac
SITE B DATA:	
PROPERTY AREA	245 ACRES
DISTURBED AREA	200 ACRES
POWER GENERATED	30 MWac
SITE C DATA:	
PROPERTY AREA	905 ACRES
DISTURBED AREA	500 ACRES
POWER GENERATED	70 MWac

OWNER/APPLICANT

sPOWER
2180 SOUTH 1300 EAST, SUITE 600
SALT LAKE CITY, UT 84106
PHONE: 801-679-3513
CONTACT: DANIEL MENAHEM
EMAIL: DMENAHM@SPOWER.COM

CIVIL ENGINEER

KIMLEY-HORN AND ASSOCIATES, INC.
11400 COMMERCE PARK DRIVE, SUITE 400
RESTON, VA 20191
PHONE: 703-674-1337
CONTACT: SEAN MILLOT, P.E.
EMAIL: SEAN.MILLOT@KIMLEY-HORN.COM

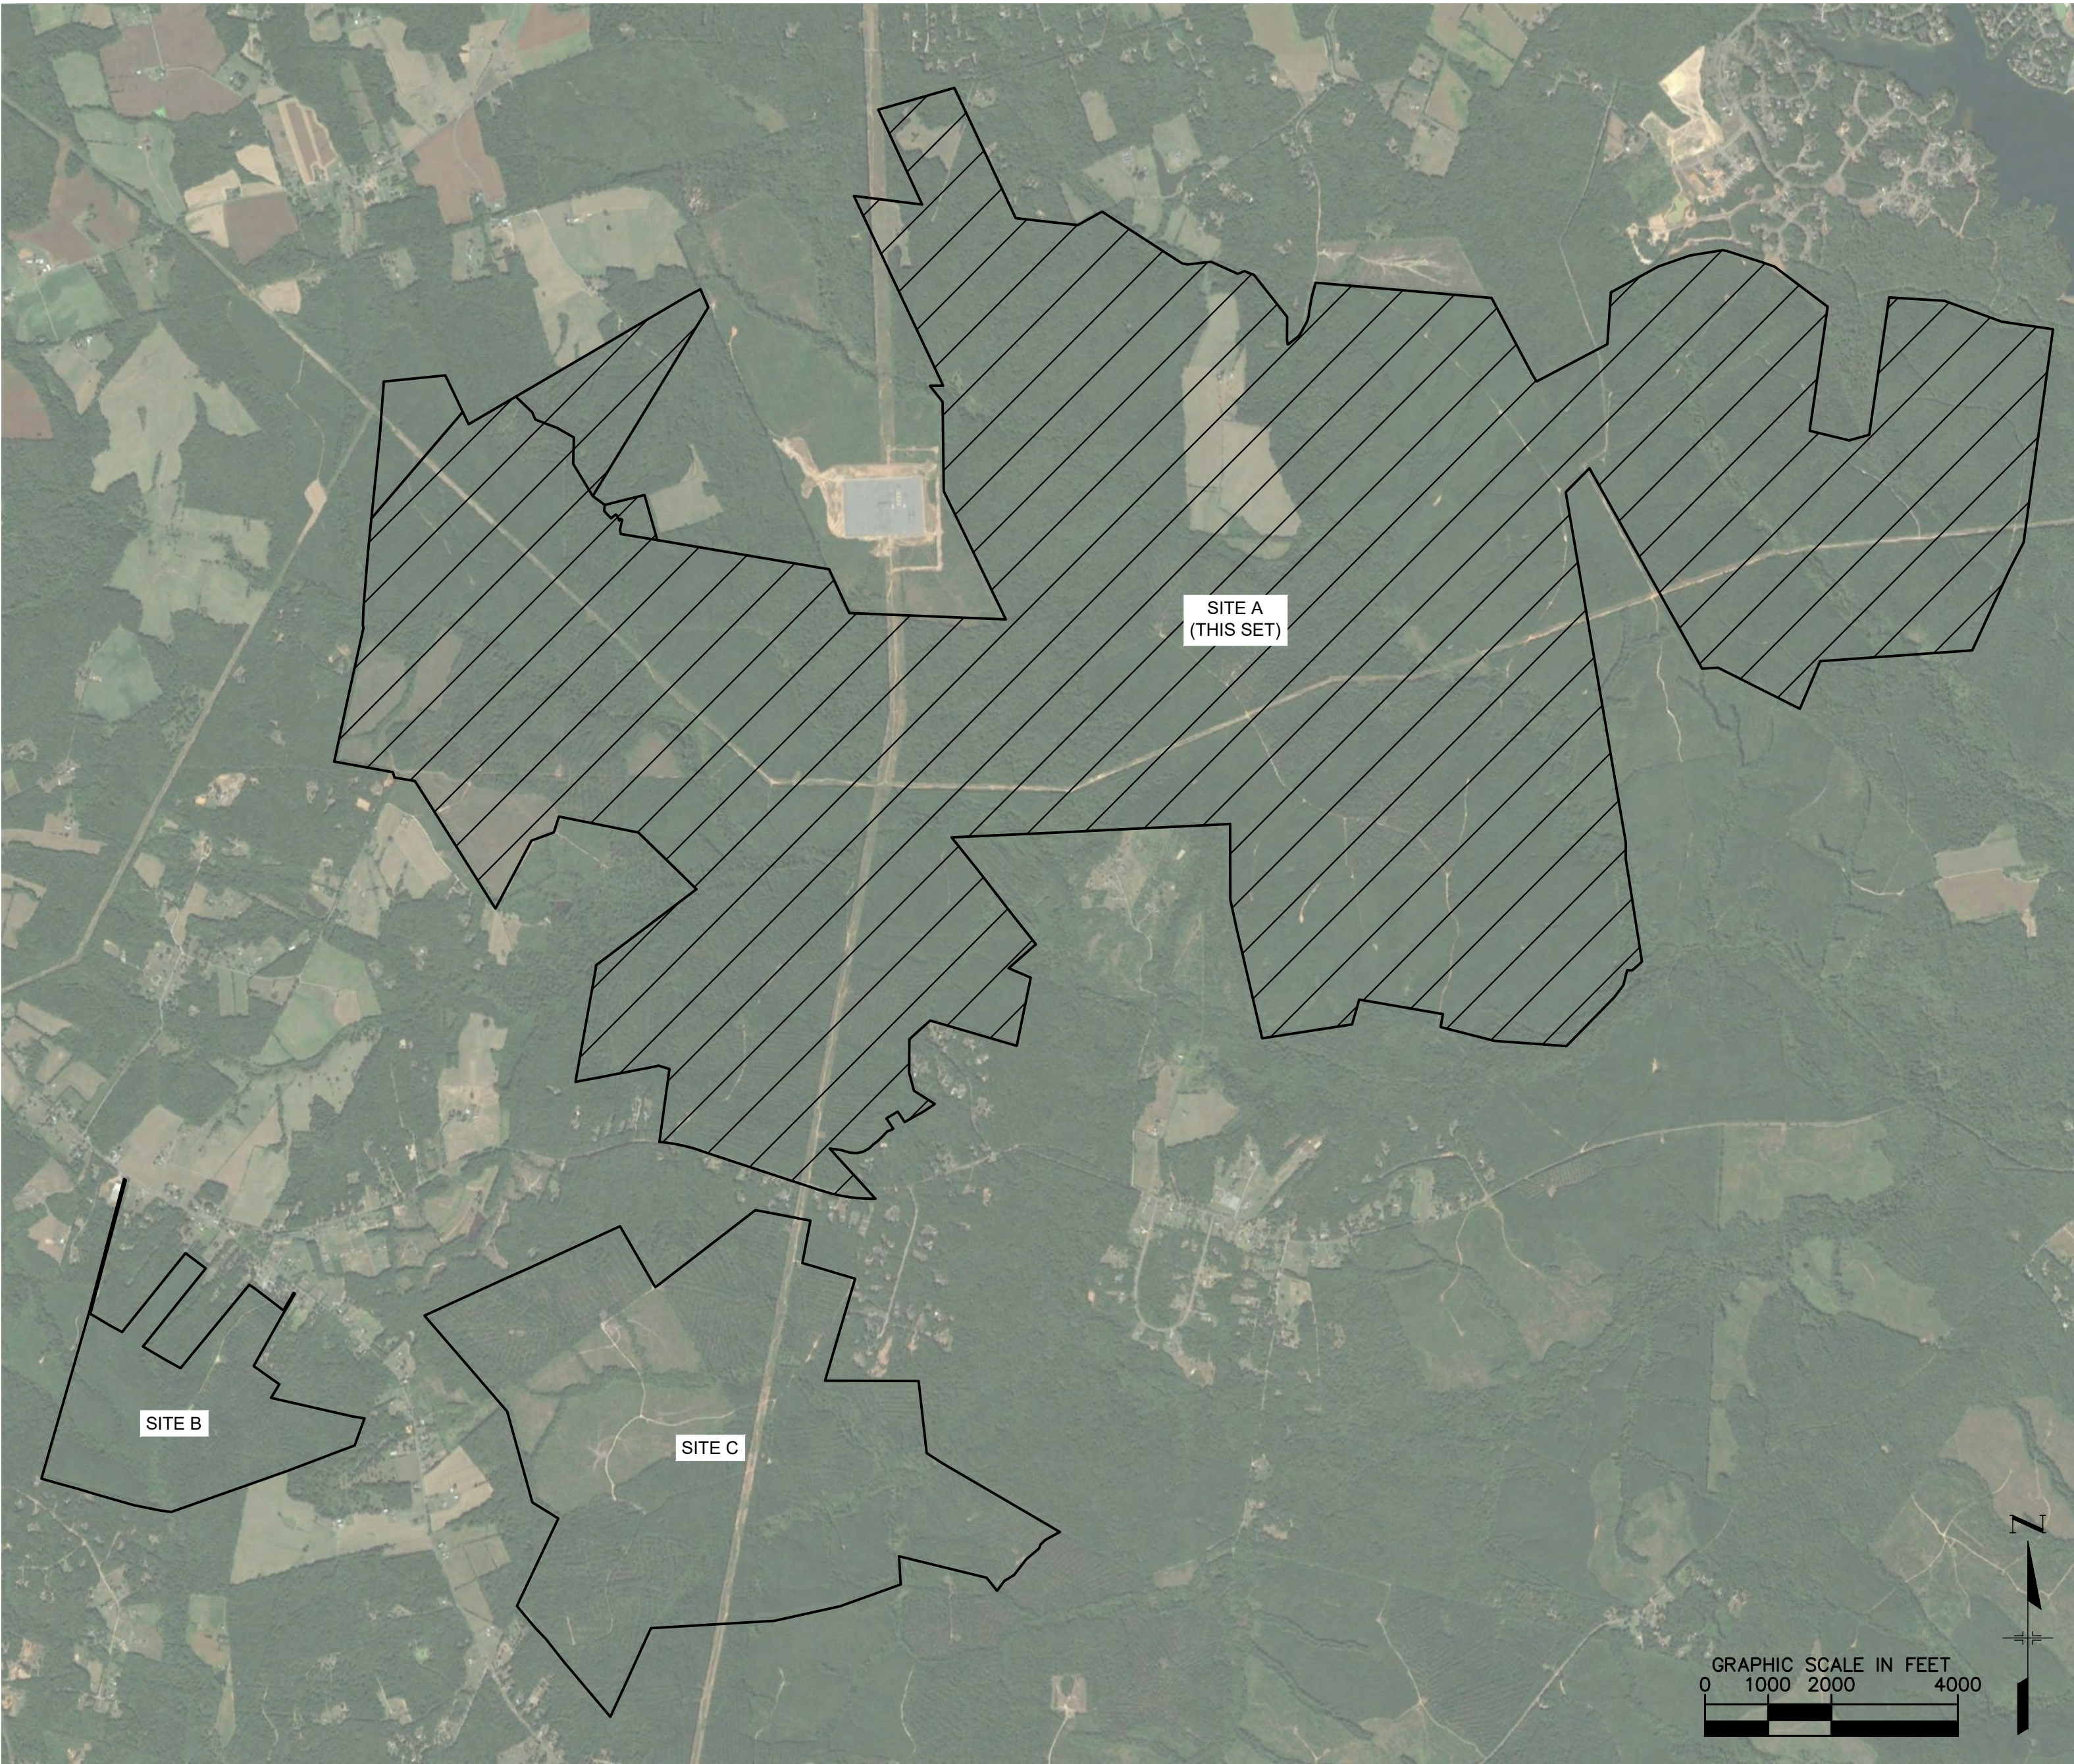

VICINITY MAP - PROJECT LIMITS
1" = 2,000'

Sheet List Table	
Sheet No.	Sheet Title
C-01	GENERALIZED DEVELOPMENT PLAN COVER
EX-1-0	GENERALIZED DEVELOPMENT PLAN - OVERALL
EX-1-1	GENERALIZED DEVELOPMENT PLAN - 1
EX-1-2	GENERALIZED DEVELOPMENT PLAN - 2
EX-1-3	GENERALIZED DEVELOPMENT PLAN - 3
EX-1-4	GENERALIZED DEVELOPMENT PLAN - 4
EX-1-5	GENERALIZED DEVELOPMENT PLAN - 5
EX-1-6	GENERALIZED DEVELOPMENT PLAN - 6
EX-1-7	GENERALIZED DEVELOPMENT PLAN - 7
EX-1-8	GENERALIZED DEVELOPMENT PLAN - 8
EX-1-9	GENERALIZED DEVELOPMENT PLAN - 9
EX-2-0	PRESERVATION AREA PLAN
EX-2-1	LANDSCAPE AND BUFFER AREA PLAN
EX-2-2	ACCESS ROAD SERVICE AREAS
EX-2-3	COUNTY TRAIL OVERLAY MAP
CD-1	CIVIL DETAILS
SHEETS 1-17	ALTA SURVEY

OWNER INFORMATION - SITE A	
OWNER	TAX MAP PARCEL NUMBER
RIVEROAK TIMBERLAND INVESTMENTS LLC	28-A-71
	29-A-2A
	29-A-2
	28-A-77
	16-A-1
	29-A-24
	29-A-25
	29-A-26
	29-A-27
	17-A-47
	29-A-28
	29-A-22
	18-A-15
	18-A-20
CHARLES WOOLFREY CONSTRUCTION INC	29-A-7
	28-A-1
ROBERT S COLEMAN JR	28-A-78
	29-A-1
GARY THOMAS WOOLFREY	28-A-79
	30-A-1
GOODWIN BROTHERS LUMBER COMPANY, LLC	18-A-16
	17-A-4
MEADOWS ENTERPRISES	17-A-3
	17-S-19
MWD PROPERTIES 2009, LLC	17-A-3A
	17-A-48
	17-A-7

PROJECT INFORMATION - SITE A			
AIRPORTS			
NO KNOWN AIRPORTS WITHIN A 5-MILE RADIUS OF SITE A.			
CULTURAL RESOURCES			
TWO KNOWN PLACES OF BURIAL ON OR NEAR PROXIMITY OF PROJECT. NO HISTORIC BUILDINGS EXIST AT THE PROJECT SITE.			
TRAFFIC INFORMATION			
• VOLUMES SUBJECT TO CHANGE BASED ON TRAFFIC IMPACT STUDY RESULTS			
• SEE TRAFFIC IMPACT ANALYSIS AND EXHIBITS FOR ADDITIONAL TRAFFIC DISTRIBUTION AND RECOMMENDATIONS			
• PROPOSED CONSTRUCTION TRAFFIC: 700 VEHICLES PER DAY			
IMPERVIOUS AREAS*			
	TOTAL	AREA (SF)	AREA (AC)
SOLAR PANEL POST** (0.11 SF EACH)	217,680	23,945	0.55
INVERTER PAD (40' X 10')	195	78,000	1.79
GRAVEL DRIVES (12' WIDTH)	215,439 LF	2,585,268	59.35
TOTAL IMPERVIOUS AREAS			61.69
TOTAL IMPERVIOUS % OF SITE			1.19%
*IMPERVIOUS AREAS SHOWN FOR THE SITE ARE FOR PRELIMINARY USE ONLY. NOT TO BE USED FOR DESIGN PURPOSES.			
**PER DEQ REGULATIONS, ONLY POLE MOUNTINGS FOR THE SOLAR PANELS ARE TO BE USED TO CALCULATE IMPERVIOUS AREA. ASSUMED SPACING OF 15' SUBJECT TO FINAL ENGINEERING.			
WATER QUALITY (VRRM)***			
TP LOAD REDUCTION REQUIRED (LB/YR)	377.09		
ACRES PLACED IN CONSERVATION AREA	1,173.01		
***WATER QUALITY VALUES SHOWN FOR THE SITE ARE FOR PRELIMINARY USE ONLY. NOT TO BE USED FOR DESIGN PURPOSES.			

SOLID WASTE DISPOSAL CALCULATIONS FOR CONSTRUCTION FOR SITES A, B, AND C

Step 1: Identification of Collection Method				
Container Type (Compactor, Roll Off, Dumpster, Cans)	Size (Cubic Yards)	Number of Containers	Number of Pickups Per Week	Material (Trash or Recycle)
Compactor	40 YD	2	1	Trash
Dumpster	40 YD	2	2	Trash
Combined Annual Waste Streams				
		4	3	

Step 2: Determination of Minimum Storage Capacity				
Container Type (Compactor, Roll Off, Dumpster, Cans)	Size (Cubic Yards)	Number of Containers	Number of Pickups Per Week	Material (Trash or Recycle)
Compactor	40 YD	2	1	Trash
Dumpster	40 YD	2	2	Trash
Combined Annual Waste Streams				
		4	3	

Step 3: Identification of Collection Method				
Container Type (Compactor, Roll Off, Dumpster, Cans)	Size (Cubic Yards)	Number of Containers	Number of Pickups Per Week	Material (Trash or Recycle)
Compactor	40 YD	2	1	Trash
Dumpster	40 YD	2	2	Trash
Combined Annual Waste Streams				
		4	3	

Step 4: Determination of Minimum Storage Capacity				
Container Type (Compactor, Roll Off, Dumpster, Cans)	Size (Cubic Yards)	Number of Containers	Number of Pickups Per Week	Material (Trash or Recycle)
Compactor	40 YD	2	1	Trash
Dumpster	40 YD	2	2	Trash
Combined Annual Waste Streams				
		4	3	

Step 5: Identification of Collection Method				
Container Type (Compactor, Roll Off, Dumpster, Cans)	Size (Cubic Yards)	Number of Containers	Number of Pickups Per Week	Material (Trash or Recycle)
Compactor	40 YD	2	1	Trash
Dumpster	40 YD	2	2	Trash
Combined Annual Waste Streams				
		4	3	

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PHONE: 801-679-3501
WWW.SPOWER.COM

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11400 COMMERCE PARK DRIVE, SUITE 400
RESTON, VA 20191
PHONE: 703-674-1300
WWW.KIMLEY-HORN.COM

APPROVAL

SEAN MILLOT
Lic. No. 0402052332
11/20/2018
PROFESSIONAL ENGINEER


KHA PROJECT 116626000
DATE 11/20/2018
SCALE AS SHOWN
DESIGNED BY JRB
DRAWN BY JRB
CHECKED BY SMH

SUP 18-0001
GENERALIZED
DEVELOPMENT PLAN
COVER


SPOTSYLVANIA SOLAR
ENERGY CENTER A
PREPARED FOR
sPOWER
SPOTSYLVANIA COUNTY



SHEET NUMBER
C-01

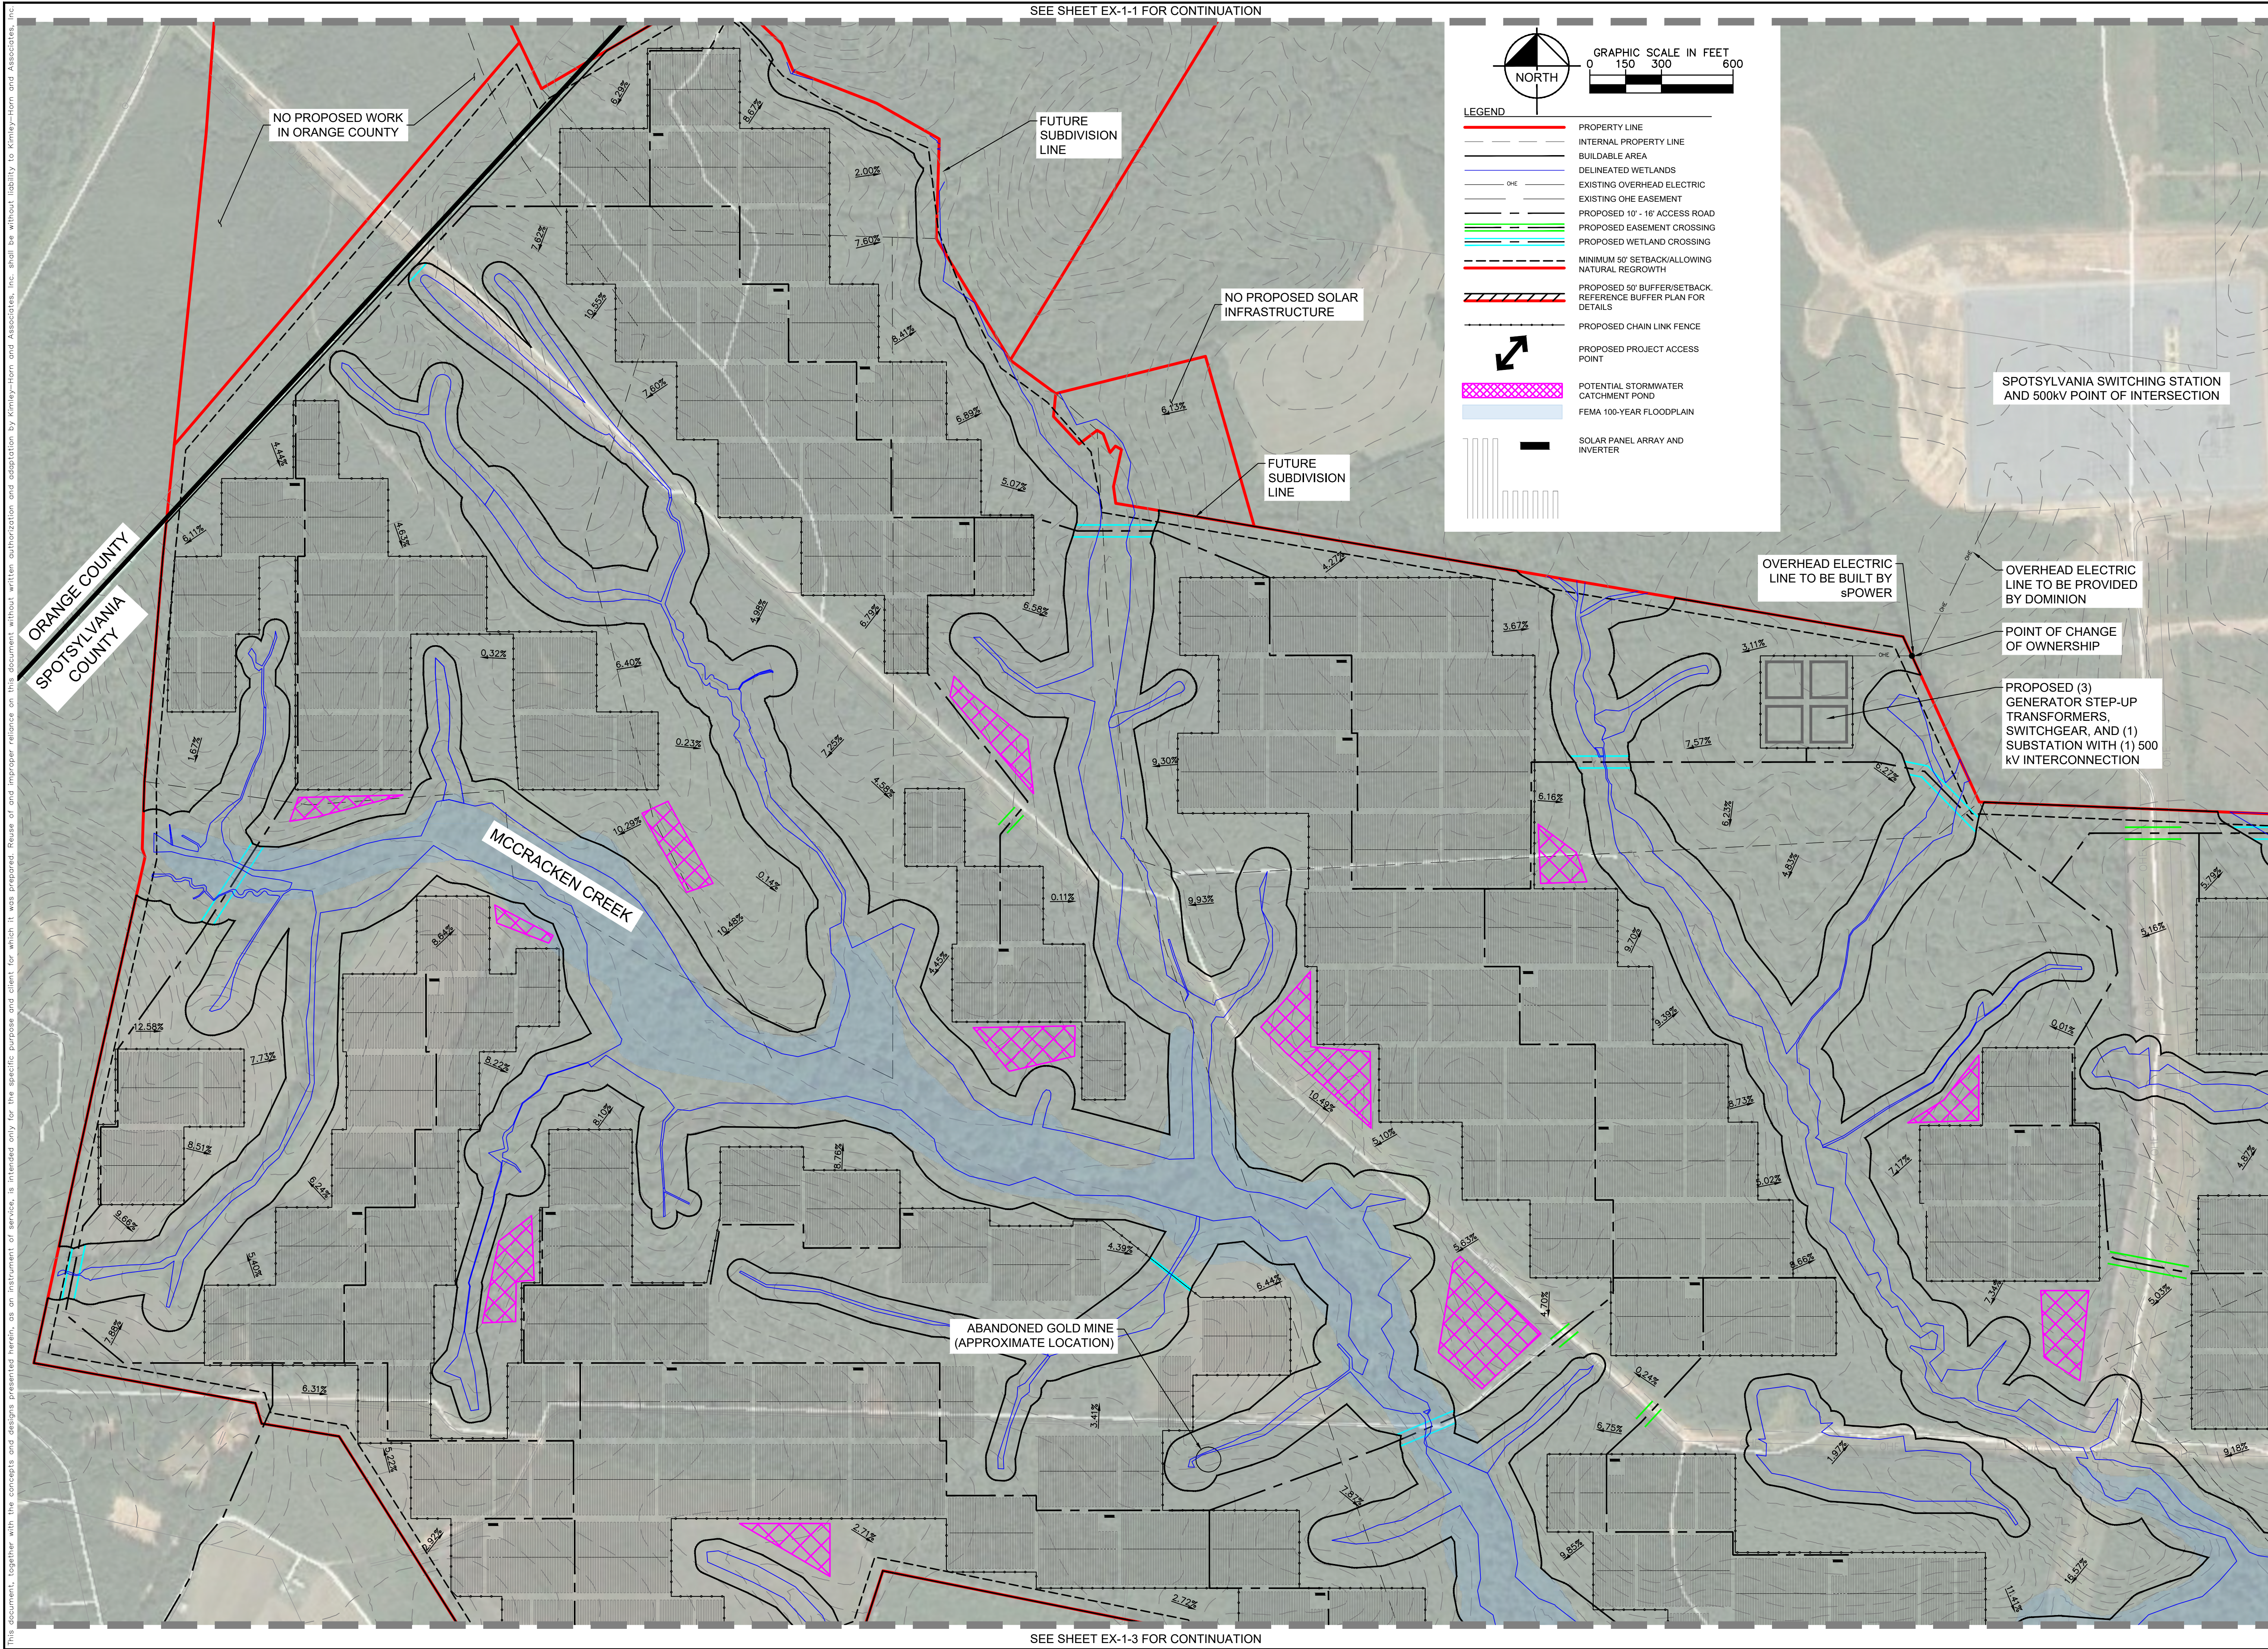SEE SHEET EX-1-3 FOR CONTINUATION

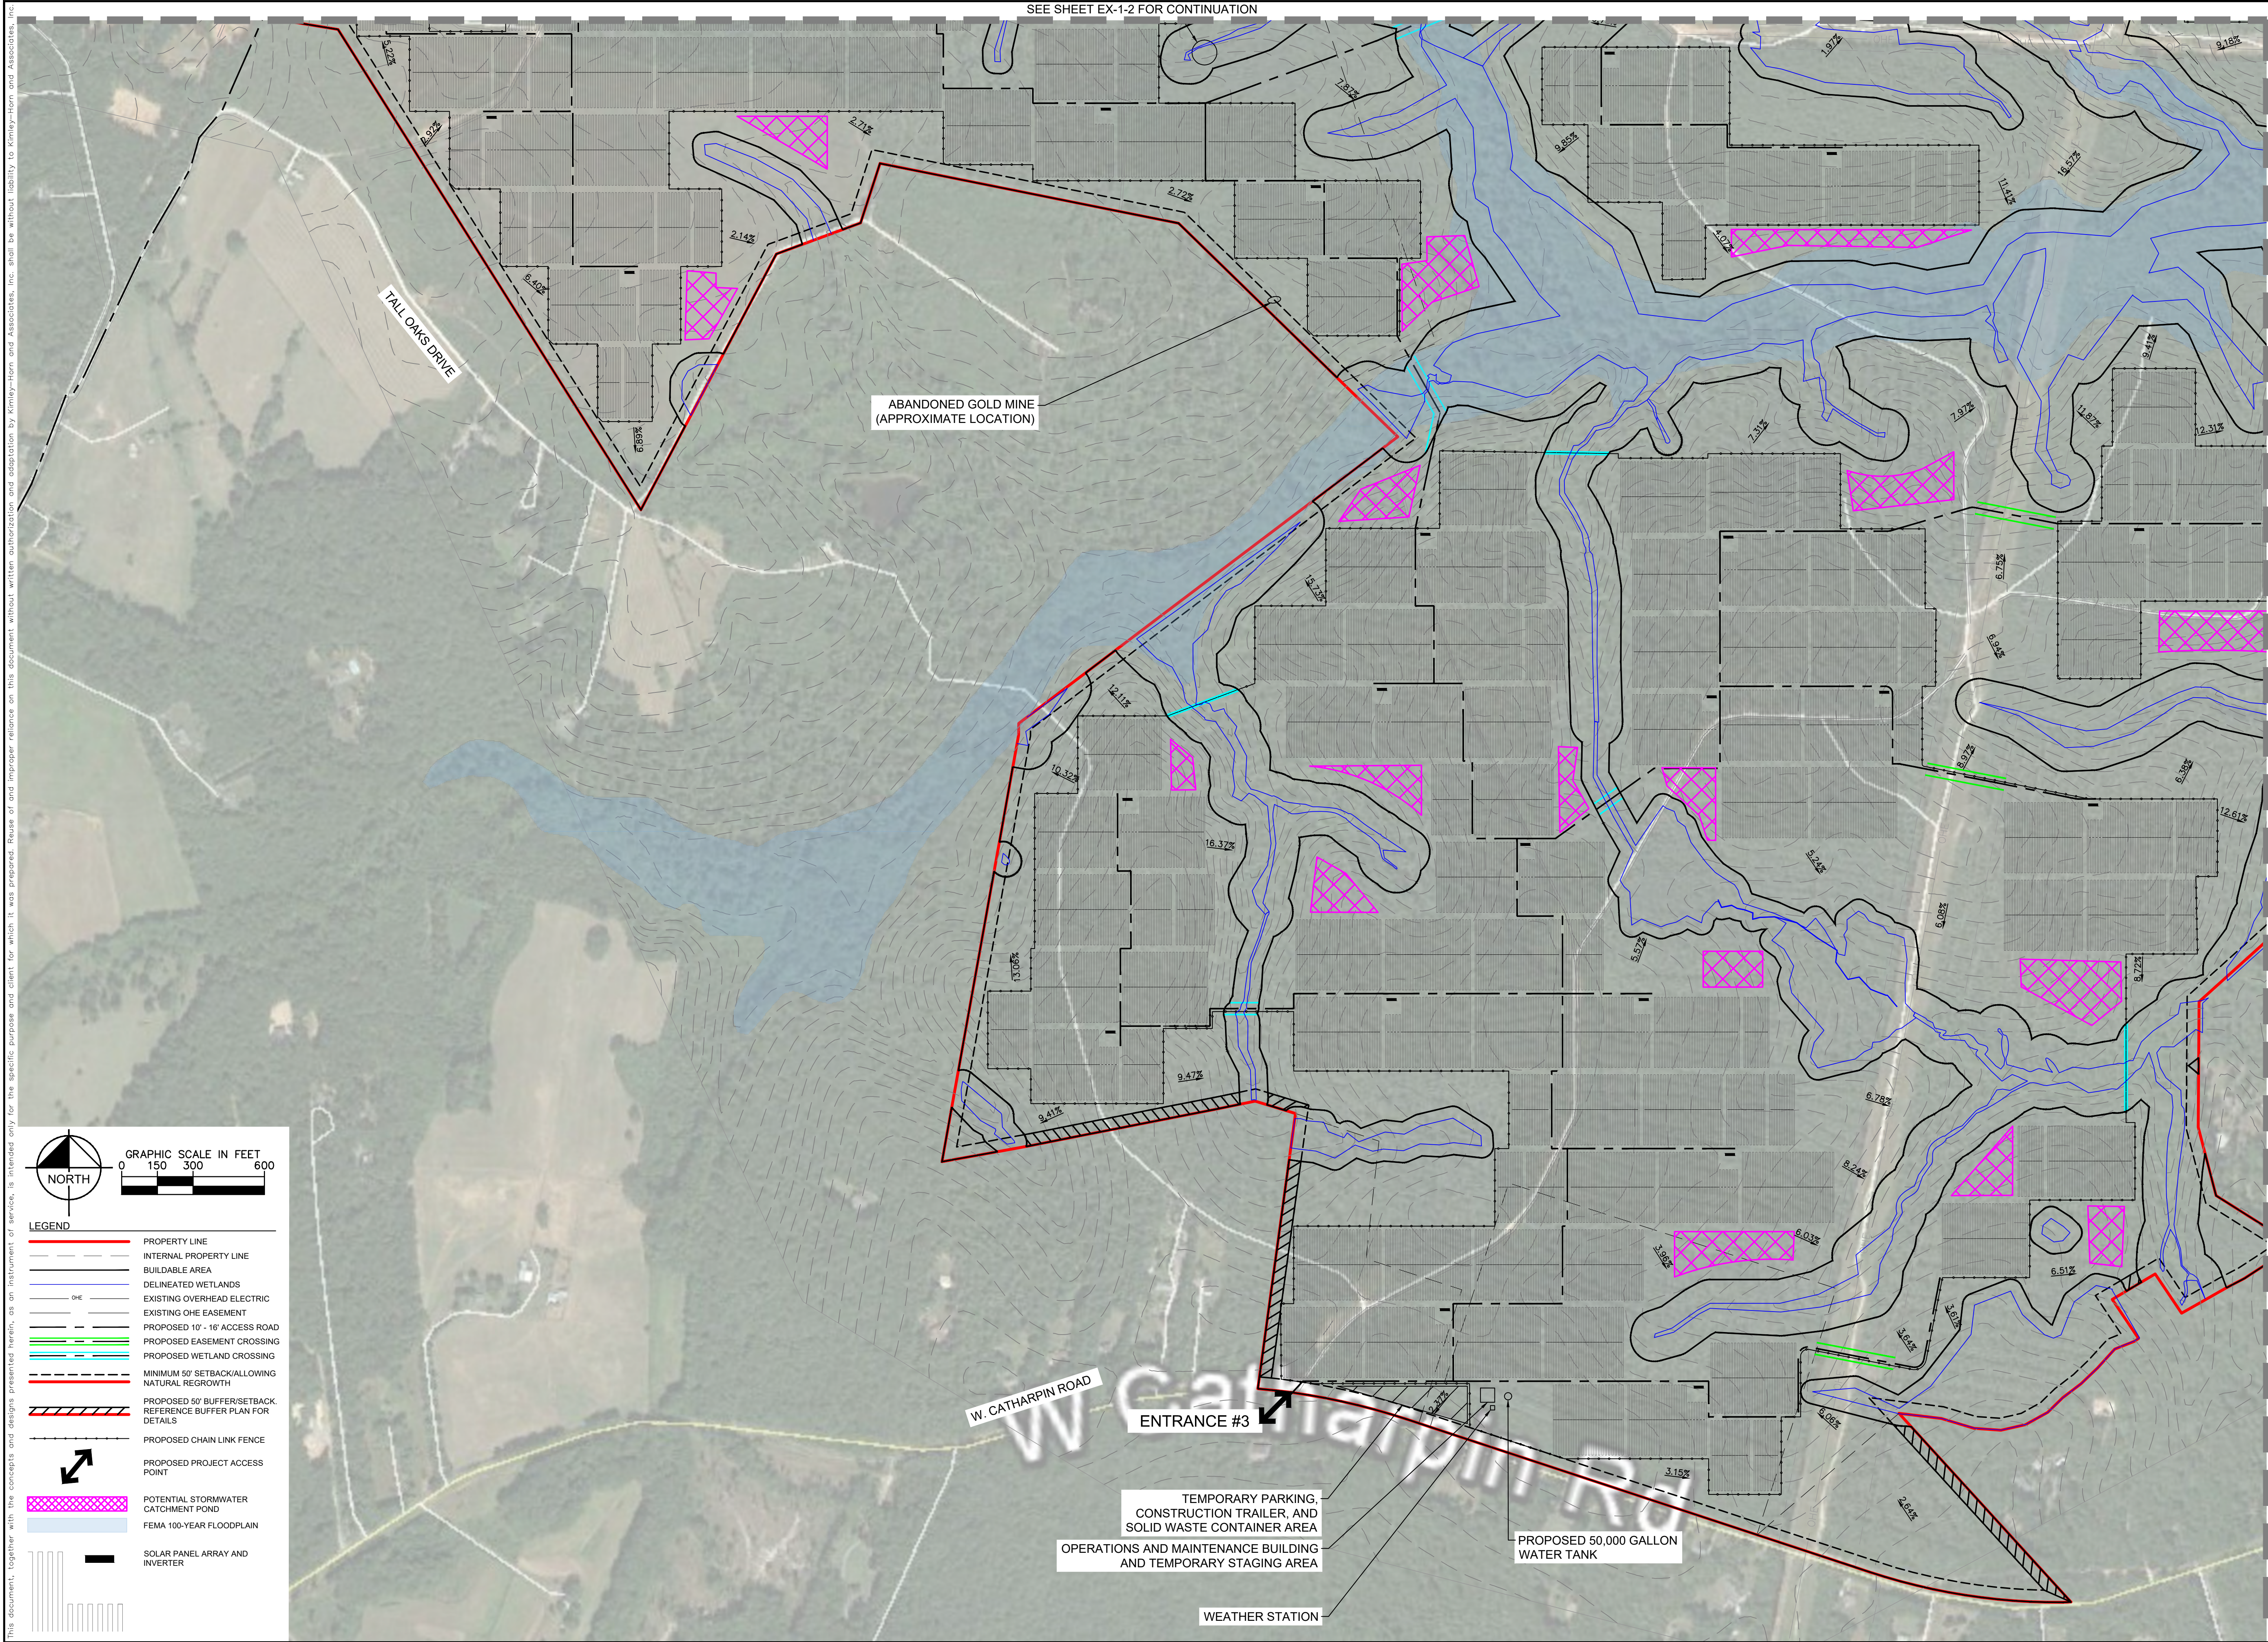


SPOTSYLVANIA SOLAR ENERGY CENTER A PREPARED FOR S-POWER SPOTSYLVANIA COUNTY VIRGINIA	SUP 18-0001 GENERALIZED DEVELOPMENT PLAN - 2	KHA PROJECT 116626000 DATE 10/26/2018 SCALE AS SHOWN DESIGNED BY JRB DRAWN BY JRB CHECKED BY SMW		APPROVAL	Kimley»Horn 2018 KIMLEY-HORN AND ASSOCIATES, INC. 11400 COMMERCE PARK DR., SUITE 400 RESTON, VA 20191 PHONE: 703-674-1300 WWW.KIMLEY-HORN.COM	S-POWER An AES and AMCo Company 2180 SOUTH 1300 EAST, SUITE 600 SALT LAKE CITY, UT 84106 PHONE: 801-655-5000 FAX: 801-679-3501 WWW.S-POWER.COM
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SPOTSylvania SOLAR ENERGY CENTER A PREPARED FOR S-POWER SPOTSylvania COUNTY VIRGINIA	SUP 18-0001 GENERALIZED DEVELOPMENT PLAN - 3		SEE SHEET EX-1-6 FOR CONTINUATION	APPROVAL 	Kimley»Horn © 2018 KIMLEY-HORN AND ASSOCIATES, INC. 11400 COMMERCE PARK DR., SUITE 400 RESTON, VA 20191 PHONE: 703-674-1300 WWW.KIMLEY-HORN.COM	 S-POWER An AES and AIMCo Company 2180 SOUTH 1300 EAST, SUITE 600 SALT LAKE CITY, UT 84106 PHONE: 801-679-3500 FAX: 801-679-3501 WWW.SPOWER.COM
	SHEET NUMBER EX-1-3	KHA PROJECT 116625000 DATE 10/26/2018 SCALE AS SHOWN DESIGNED BY JRE DRAWN BY JRE CHECKED BY SMM				

SEE SHEET EX-1-5 FOR CONTINUATION



KHA PROJECT 116626000	DATE 10/26/2018	SCALE AS SHOWN	DESIGNED BY JRB	DRAWN BY JRB	CHECKED BY SMM
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SPOTSYLVANIA SOLAR
ENERGY CENTER A
PREPARED FOR
S-POWER

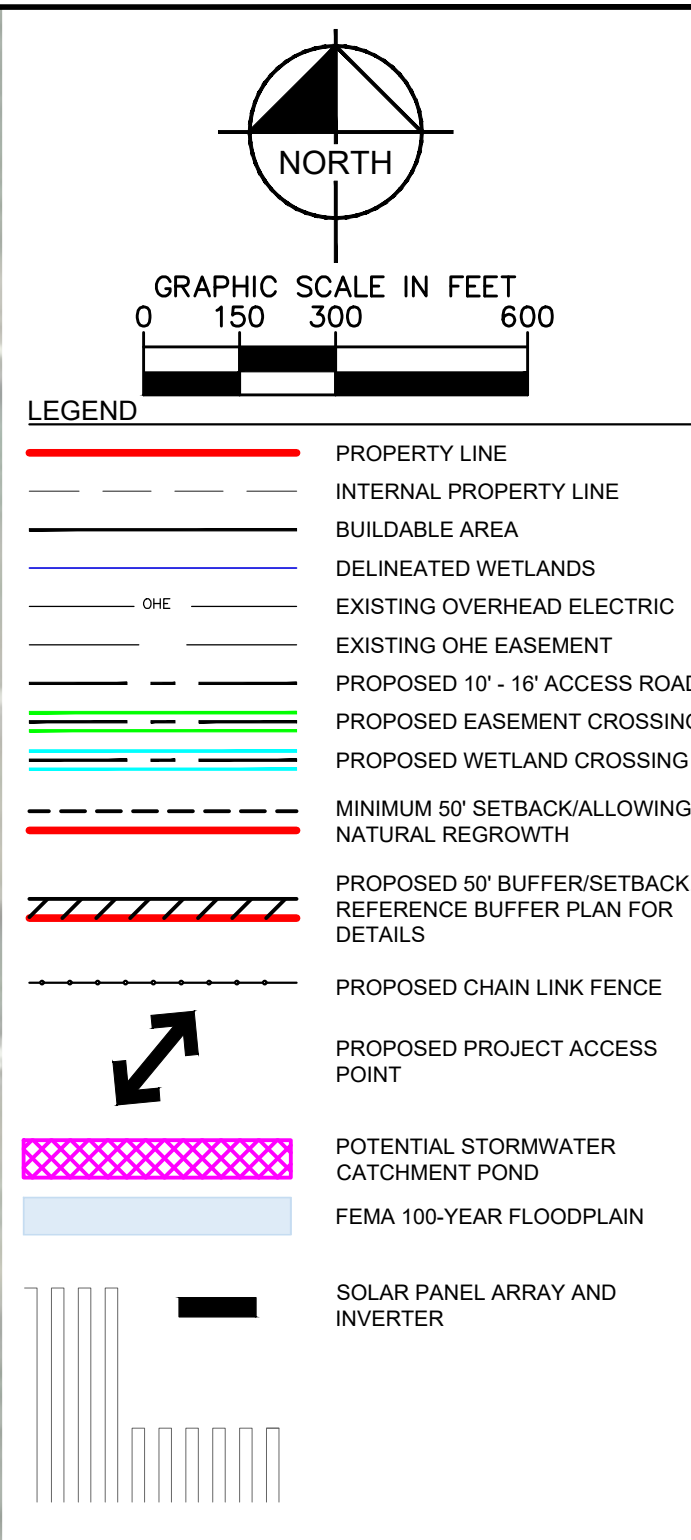SHEET NUMBER
EX-1-4


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 RESNOIS, WY 82069
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SEE SHEET EX-12 FOR CONTINUATION

SEE SHEET EX-14 FOR CONTINUATION

SEE SHEET EX-16 FOR CONTINUATION



- LEGEND**
- PROPERTY LINE
 - INTERNAL PROPERTY LINE
 - BUILDABLE AREA
 - DELINEATED WETLANDS
 - EXISTING OVERHEAD ELECTRIC
 - EXISTING OHE EASEMENT
 - PROPOSED 10' - 16' ACCESS ROAD
 - PROPOSED EASEMENT CROSSING
 - PROPOSED WETLAND CROSSING
 - MINIMUM 50' SETBACK/ALLOWING NATURAL REGROWTH
 - PROPOSED 50' BUFFER/SETBACK. REFERENCE BUFFER PLAN FOR DETAILS
 - PROPOSED CHAIN LINK FENCE
 - PROPOSED PROJECT ACCESS POINT
 - POTENTIAL STORMWATER CATCHMENT POND
 - FEMA 100-YEAR FLOODPLAIN
 - SOLAR PANEL ARRAY AND INVERTER

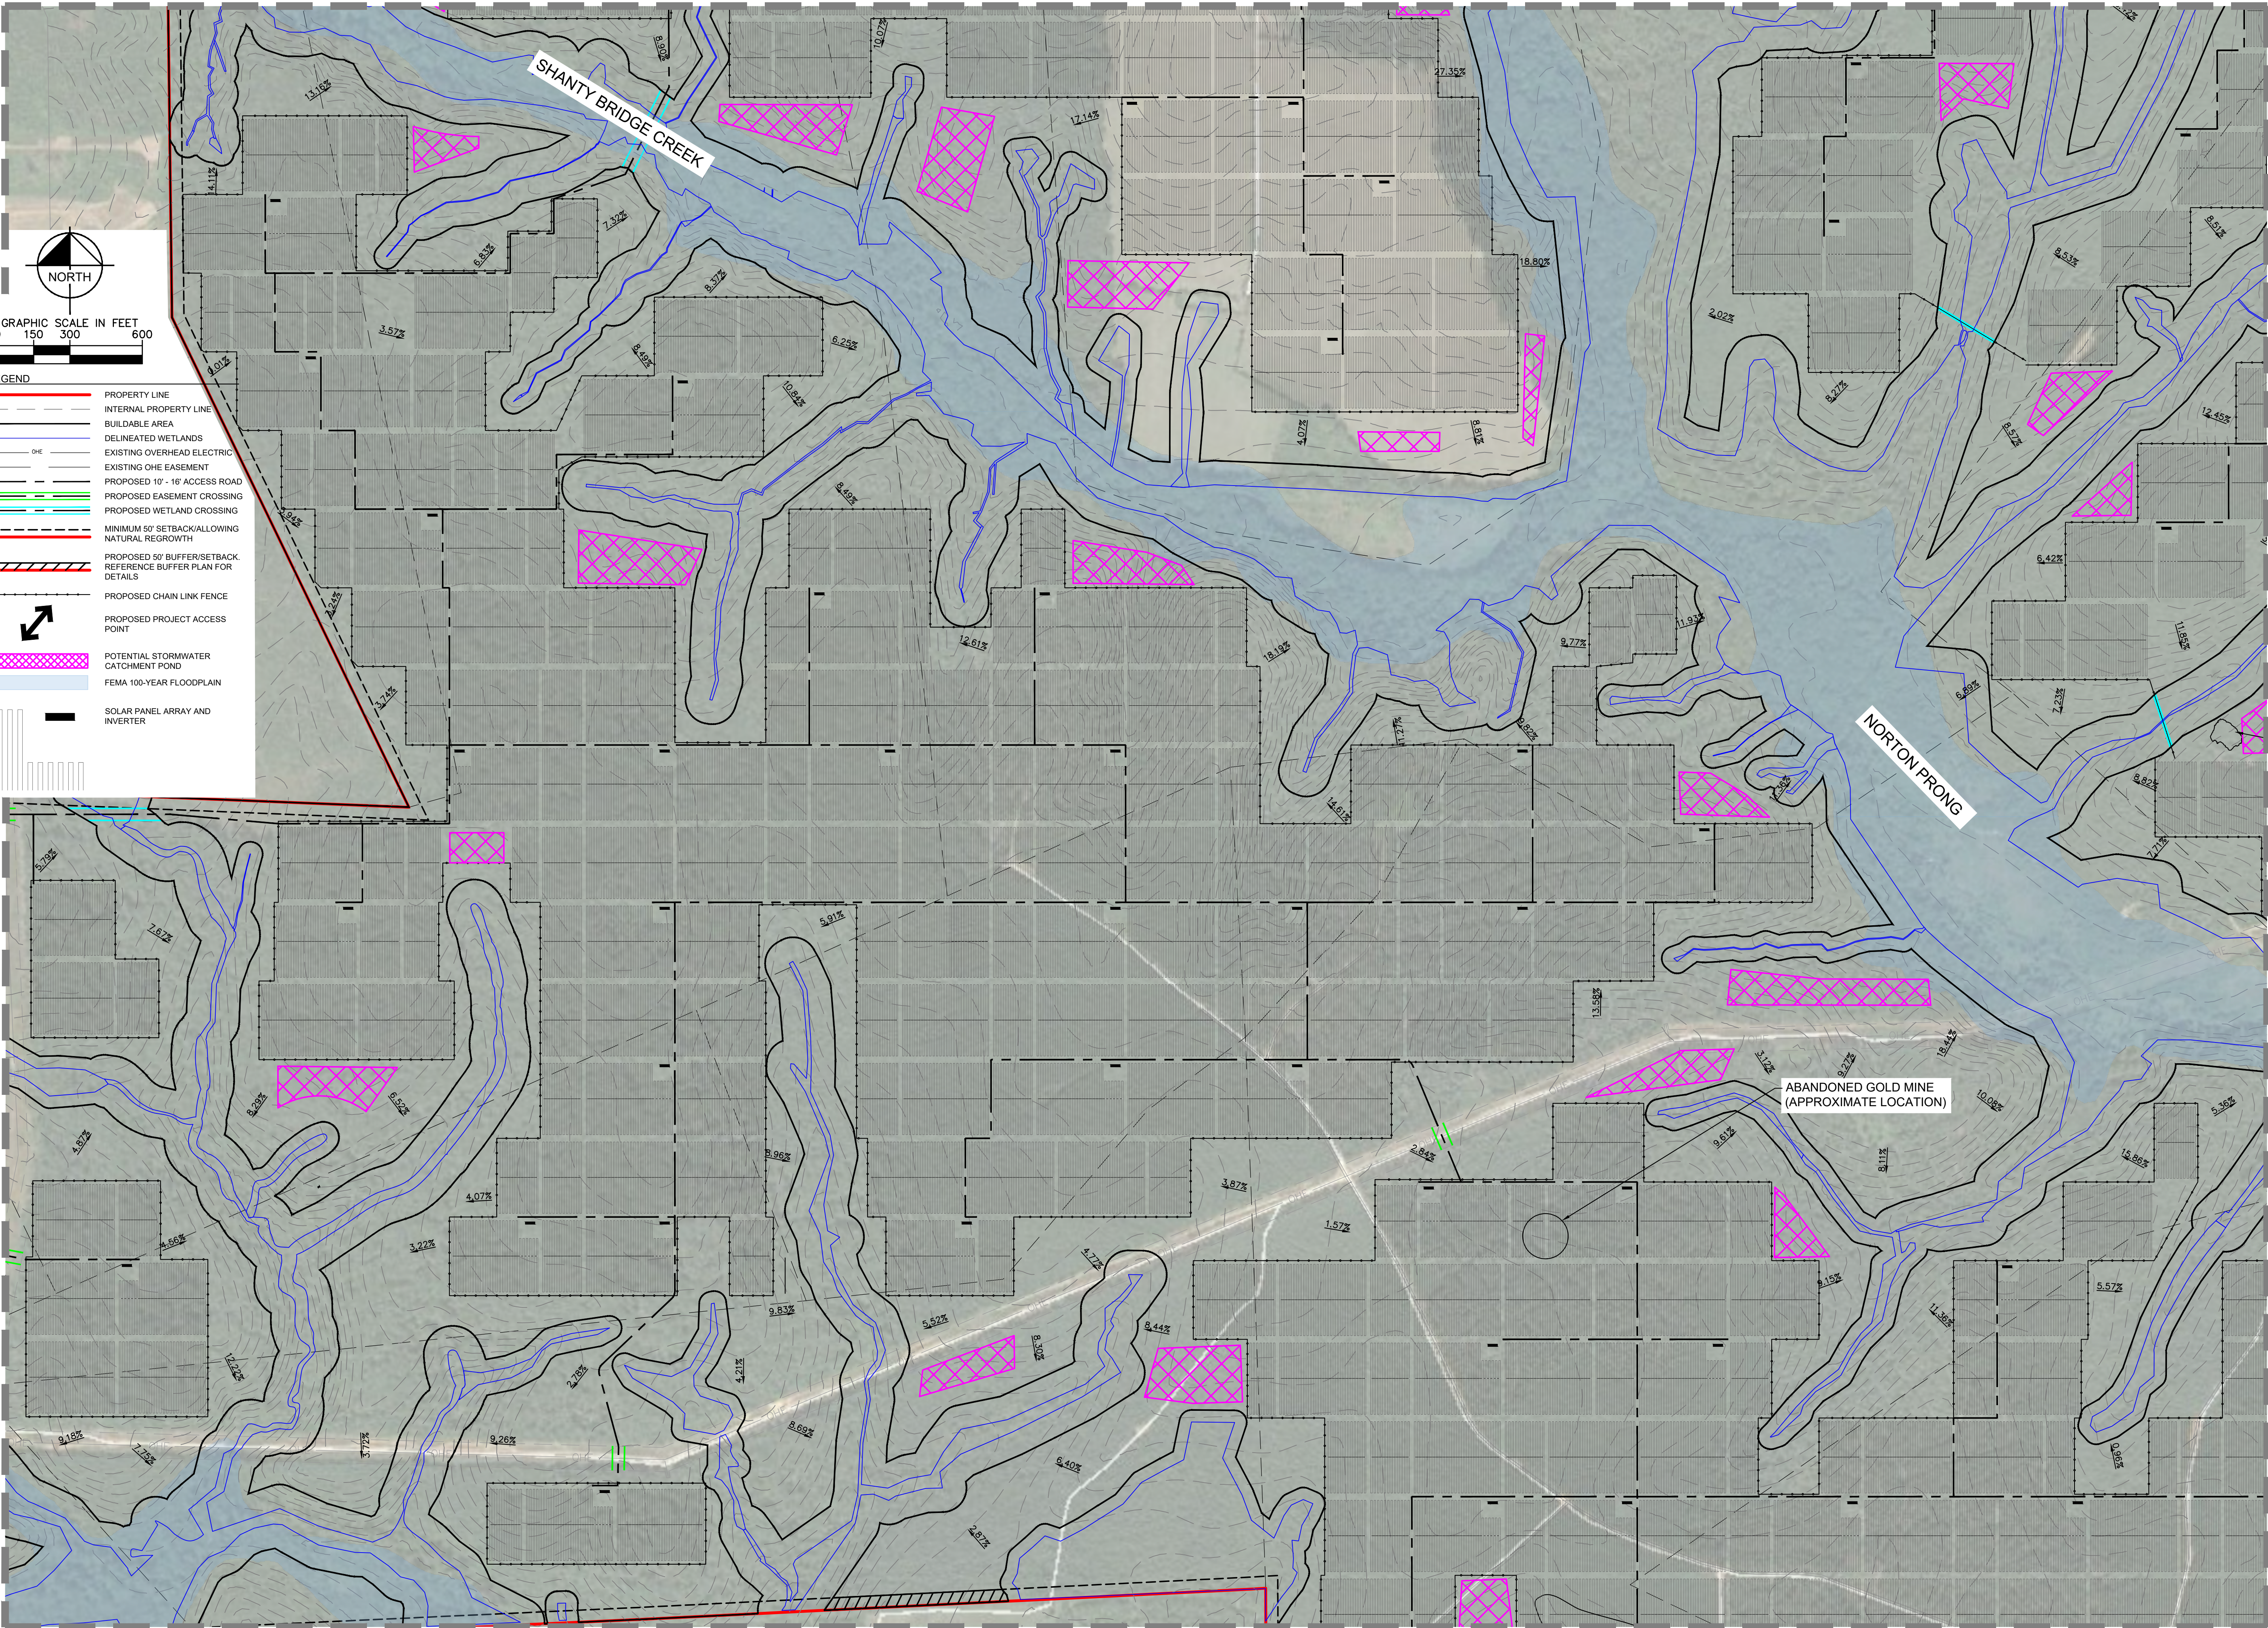SPOTSylvania SOLAR
ENERGY CENTER A
PREPARED FOR
S-POWER

SPOTSylvania COUNTY VIRGINIA

SUP 18-0001
GENERALIZED
DEVELOPMENT PLAN - 5

APPROVAL

COMMONWEALTH OF VIRGINIA
SEAN MILLOT
Lic. No. 0402052332
PROFESSIONAL ENGINEER

KHA PROJECT	DATE	SCALE	AS SHOWN	DESIGNED BY	DRAWN BY	CHECKED BY
116626000	10/26/2018	JRB	JRB	JRB	JRB	SMM

SEE SHEET EX-14 FOR CONTINUATION

SEE SHEET EX-12 FOR CONTINUATION

S-POWER
An AES and AIMCo Company

2180 SOUTH 1300 EAST, SUITE 600
SALT LAKE CITY, UT 84106
PHONE: 801-679-3500 FAX: 801-679-3501
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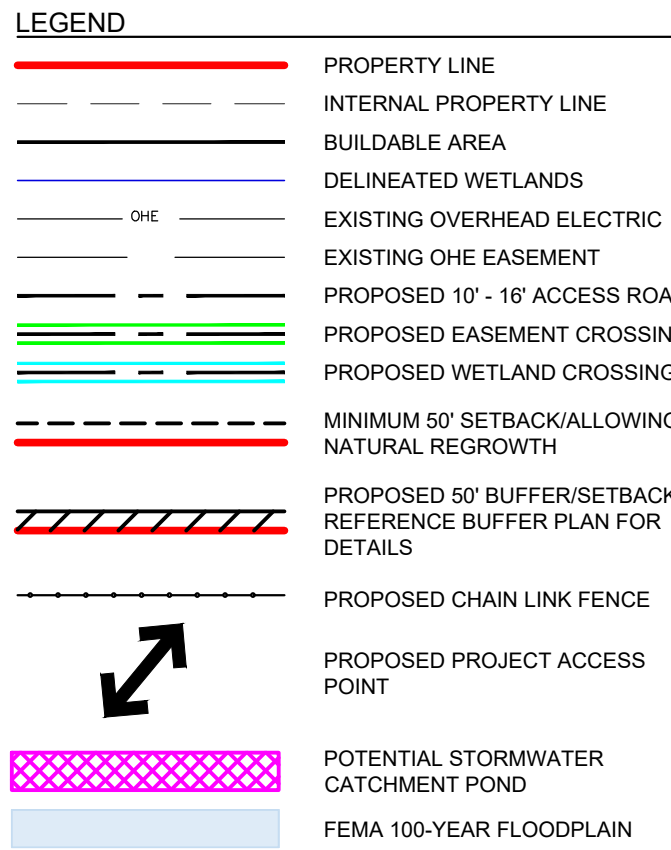
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SEE SHEET EX-1-3 FOR CONTINUATION

SEE SHEET EX-1-4 FOR CONTINUATION



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

COMMONWEALTH OF VIRGINIA
Sean MilLOT
 SEAN MILLOT
 Lic. No. 0402052332
 10/26/2018
 PROFESSIONAL ENGINEER


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ENERGY CENTER A
PREPARED FOR
S-POWER

SHEET NUMBER
EX-1-7

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SUP 18-0001 GENERALIZED DEVELOPMENT PLAN - 8			
KHA PROJECT 116626000		DATE 10/26/2018	
SCALE AS SHOWN		DESIGNED BY JRE DRAWN BY JRE	
CHECKED BY SMW			
APPROVAL 			
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LEGEND

- PROPERTY LINE
- INTERNAL PROPERTY LINE
- BUILDABLE AREA
- DELINEATED WETLANDS
- EXISTING OVERHEAD ELECTRIC
- EXISTING OHE EASEMENT
- PROPOSED 10' - 16' ACCESS ROAD
- PROPOSED EASEMENT CROSSING
- PROPOSED WETLAND CROSSING
- MINIMUM 50' SETBACK/ALLOWING NATURAL REGROWTH
- PROPOSED 50' BUFFER/SETBACK REFERENCE BUFFER PLAN FOR DETAILS
- PROPOSED CHAIN LINK FENCE
- PROPOSED PROJECT ACCESS POINT
- POTENTIAL STORMWATER CATCHMENT POND
- FEMA 100-YEAR FLOODPLAIN
- SOLAR PANEL ARRAY AND INVERTER

NORTH

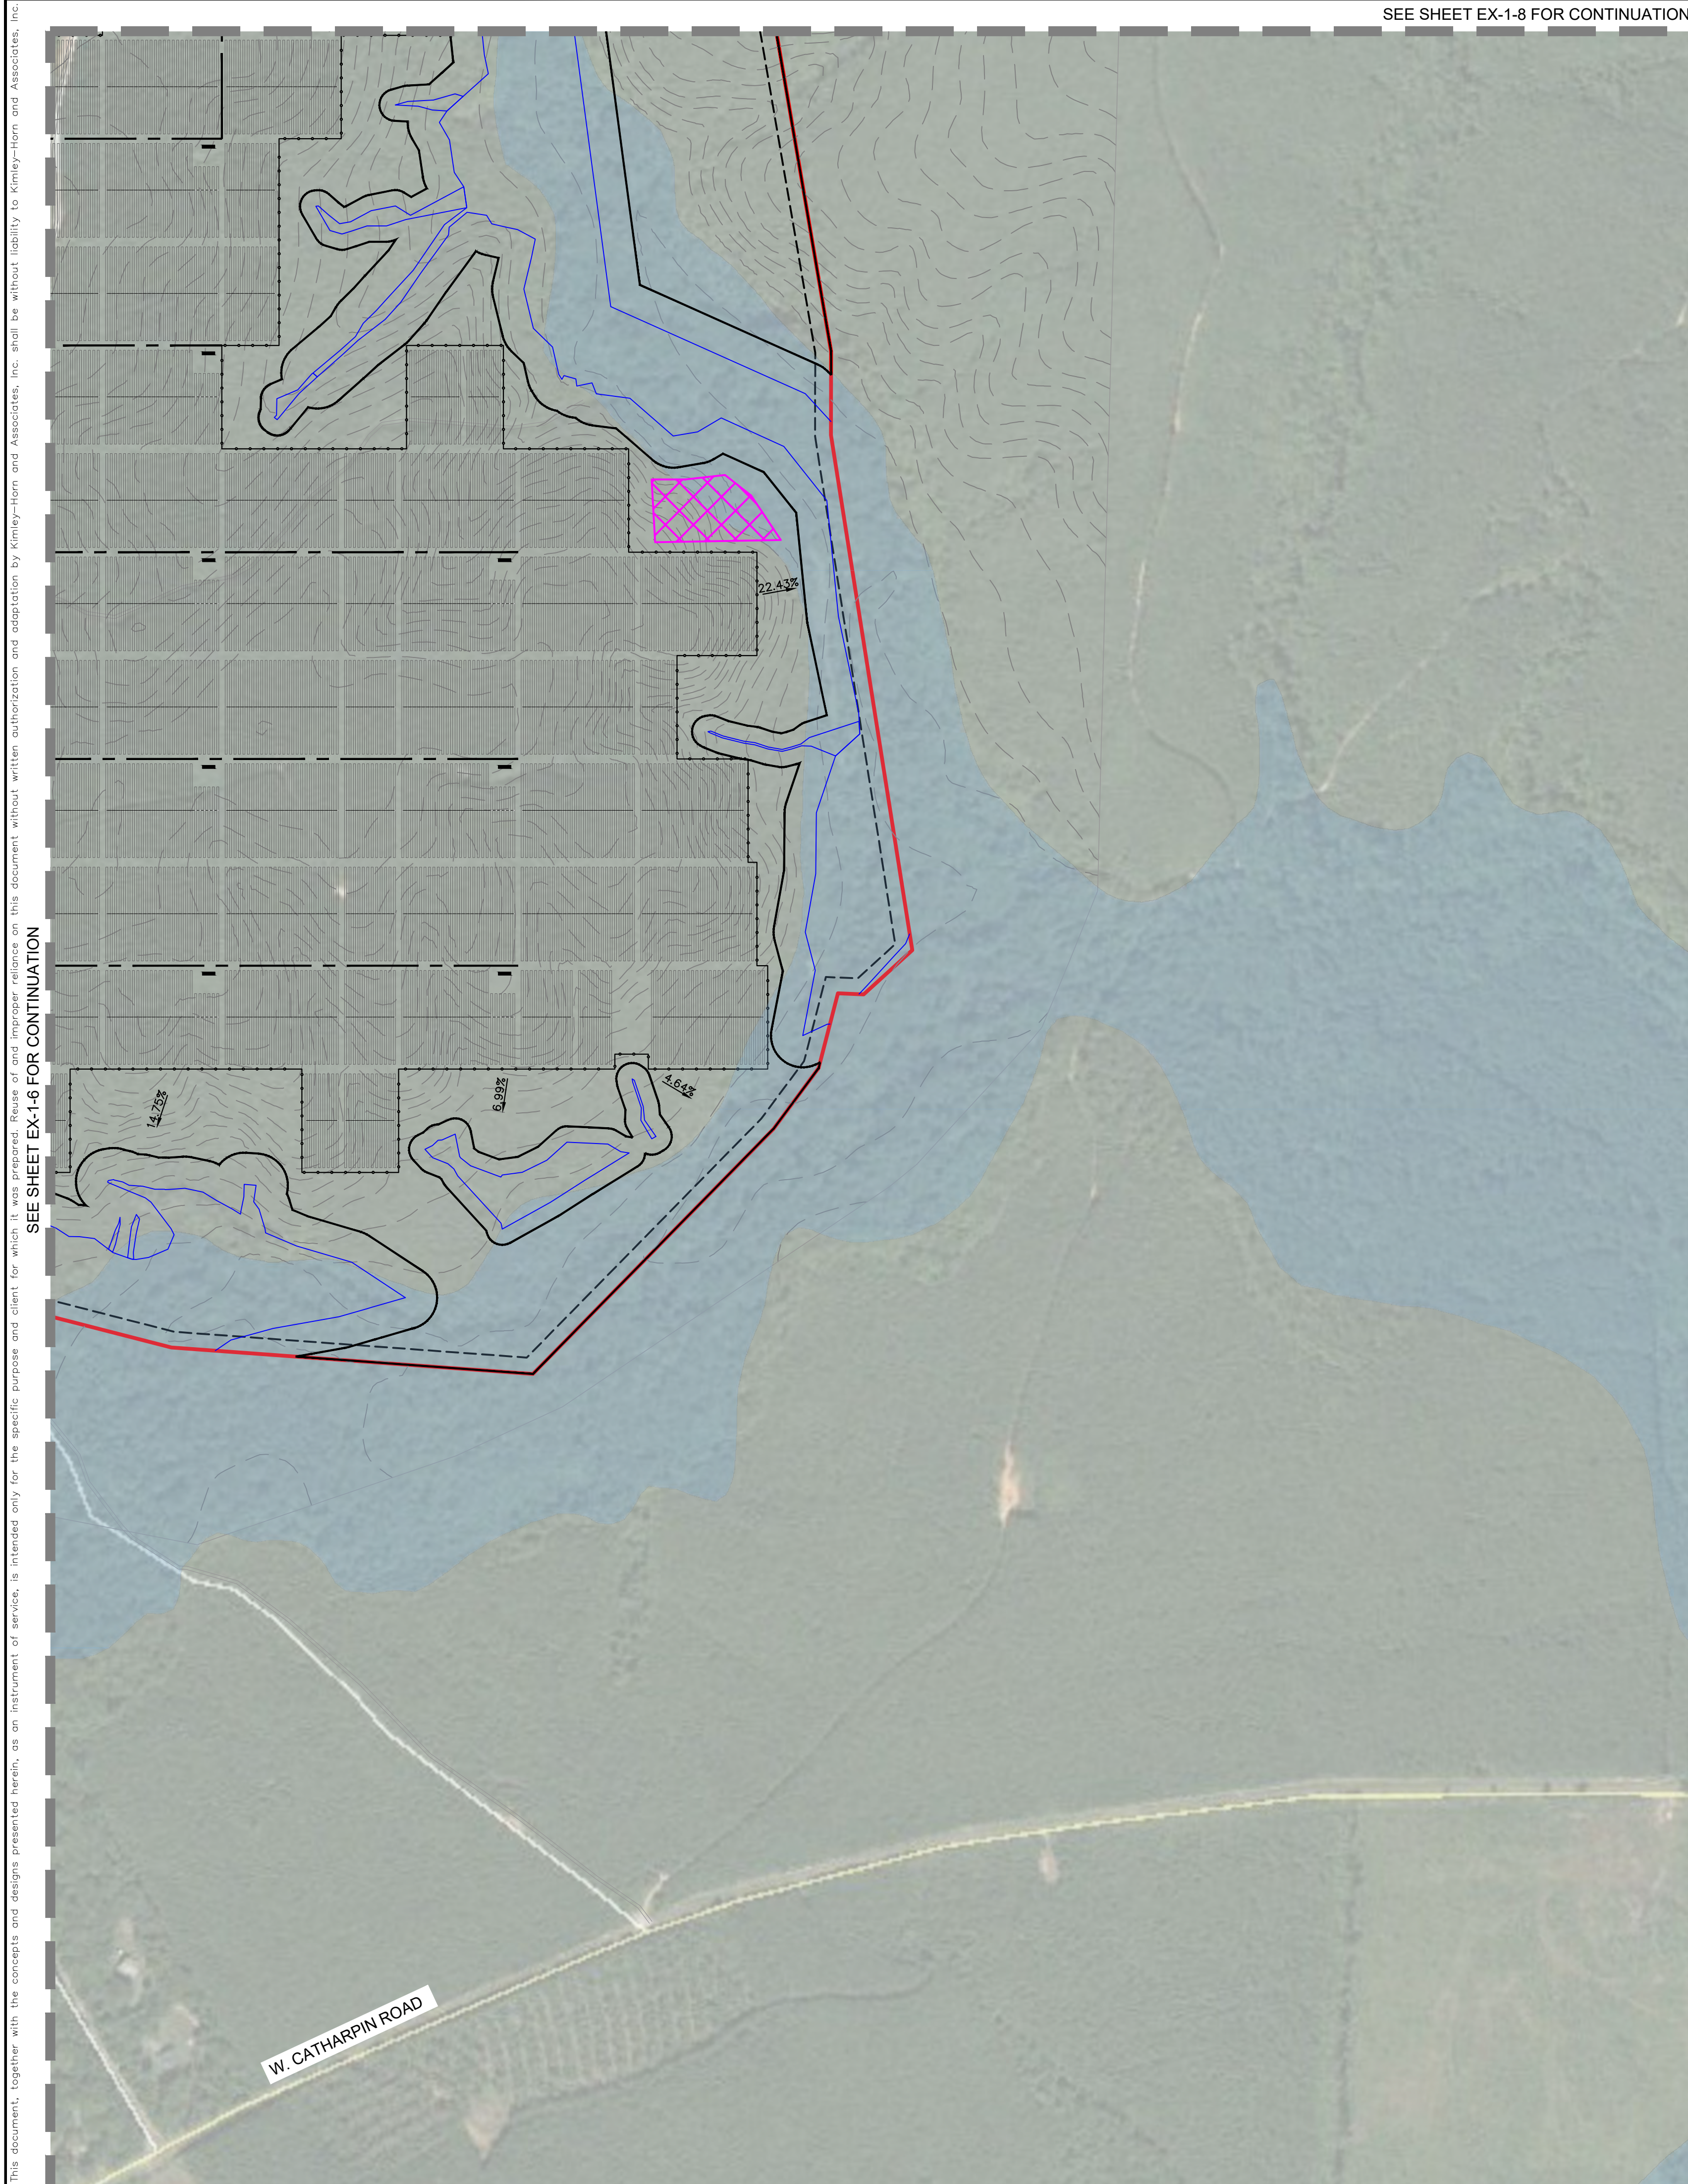GRAPHIC SCALE IN FEET

0 150 300 600

SPOTSYLVANIA SOLAR ENERGY CENTER A


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SPOTSYLVANIA COUNTY VIRGINIA

SUP 18-0001

GENERALIZED DEVELOPMENT PLAN - 9

KHA PROJECT	116626000
DATE	10/26/2018
SCALE	AS SHOWN
DESIGNED BY	JRB
DRAWN BY	JRB
CHECKED BY	SMM

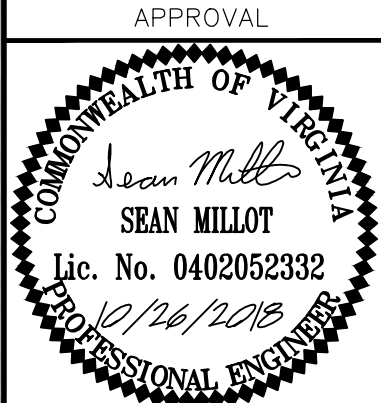

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NORTH

GRAPHIC SCALE IN FEET

04509001800

ANTICIPATED PRESERVED AREAS. FINAL PRESERVATION AREAS TO BE DETERMINED DURING FINAL SITE PLAN. VEGETATION WITHIN PRESERVATION AREAS WILL BE ALLOWED TO GROW BACK NATURALLY. SOME AREAS MAY BE RE-SEEDING WITH PRE-APPROVED SEED MIX.

PRESERVATION AREA

DO NOT DISTURB

SIGN DETAIL

N.T.S.

Old Plank Rd

ORANGE COUNTY

SPOTSYLVANIA COUNTY

LAKE MAN WAY

BUCKLAND ROAD

PARKER LANE

621

W. Catharpin Rd

POTENTIAL SMALL WHORLED POGONIA SUITABLE HABITAT (NO SMALL WHORLED POGONIA FOUND)

SPOTSYLVANIA SOLAR ENERGY CENTER A
PREPARED FOR
S-POWER

SUP 18-0001
PRESERVATION AREA
PLAN

KHA PROJECT
116626000

DATE
10/26/2018

SCALE
AS SHOWN

DESIGNED BY
JRE

DRAWN BY
JRE

CHECKED BY
SMM

APPROVAL

COMMONWEALTH OF VIRGINIA

SEAN MILLOT

Lic. No. 0402052332

10/26/2018

S-POWER


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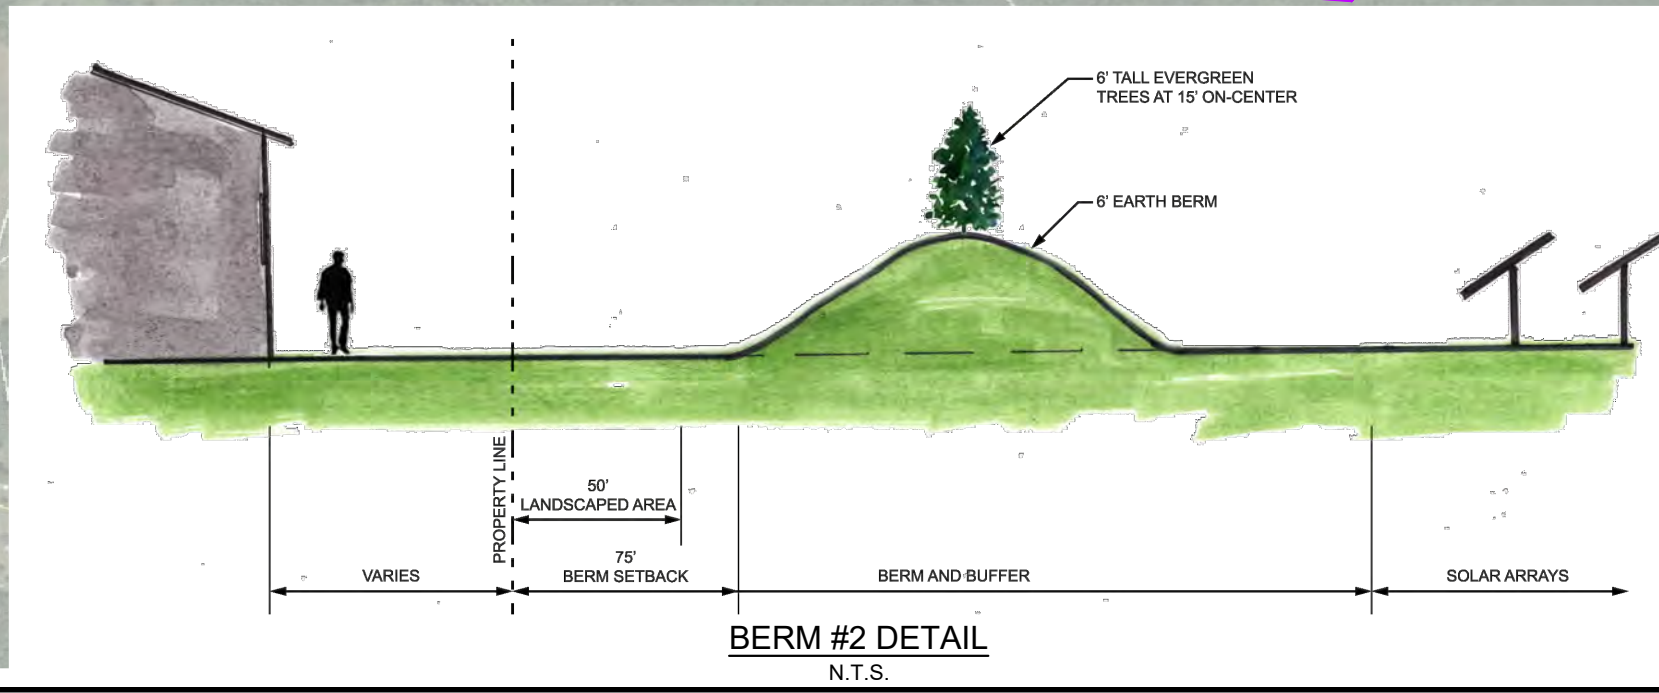
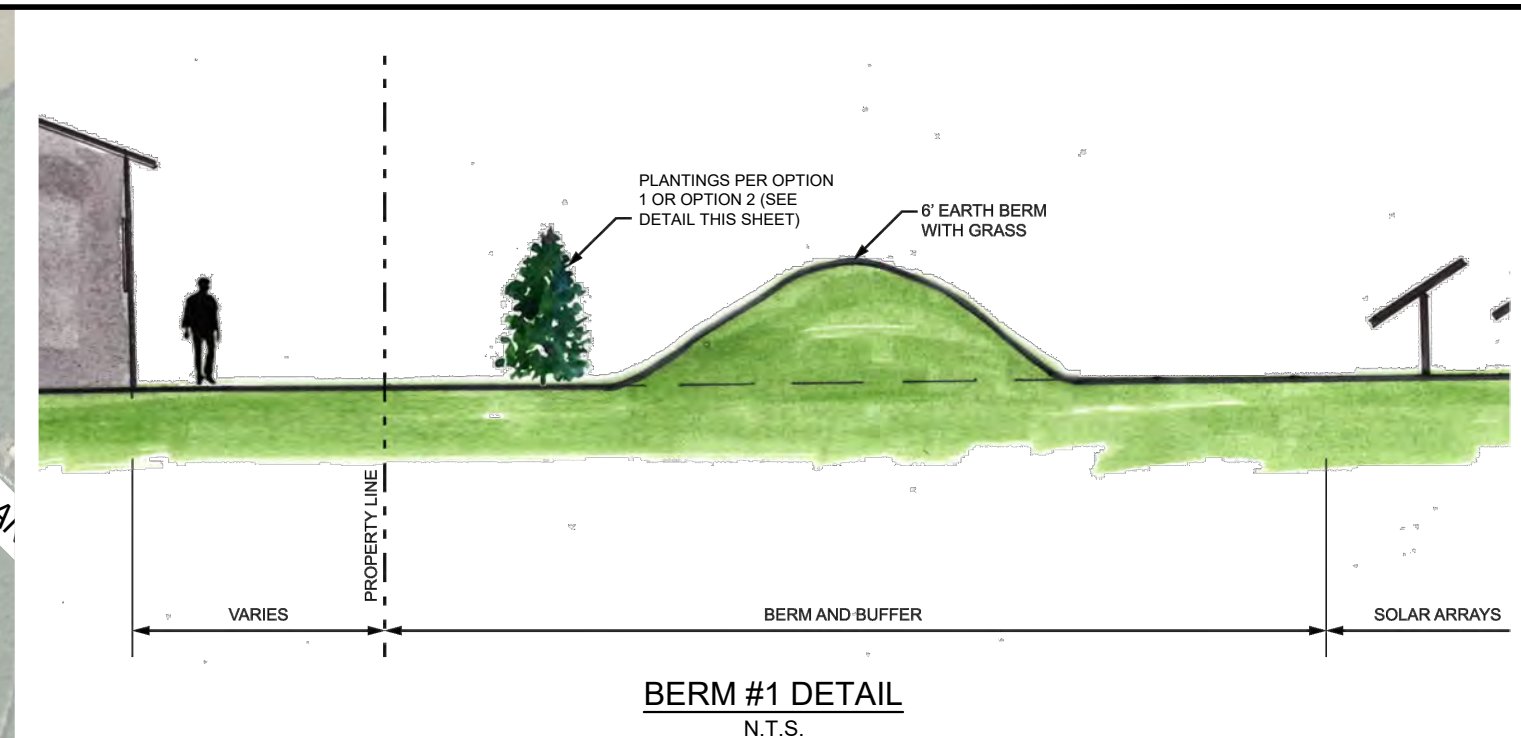
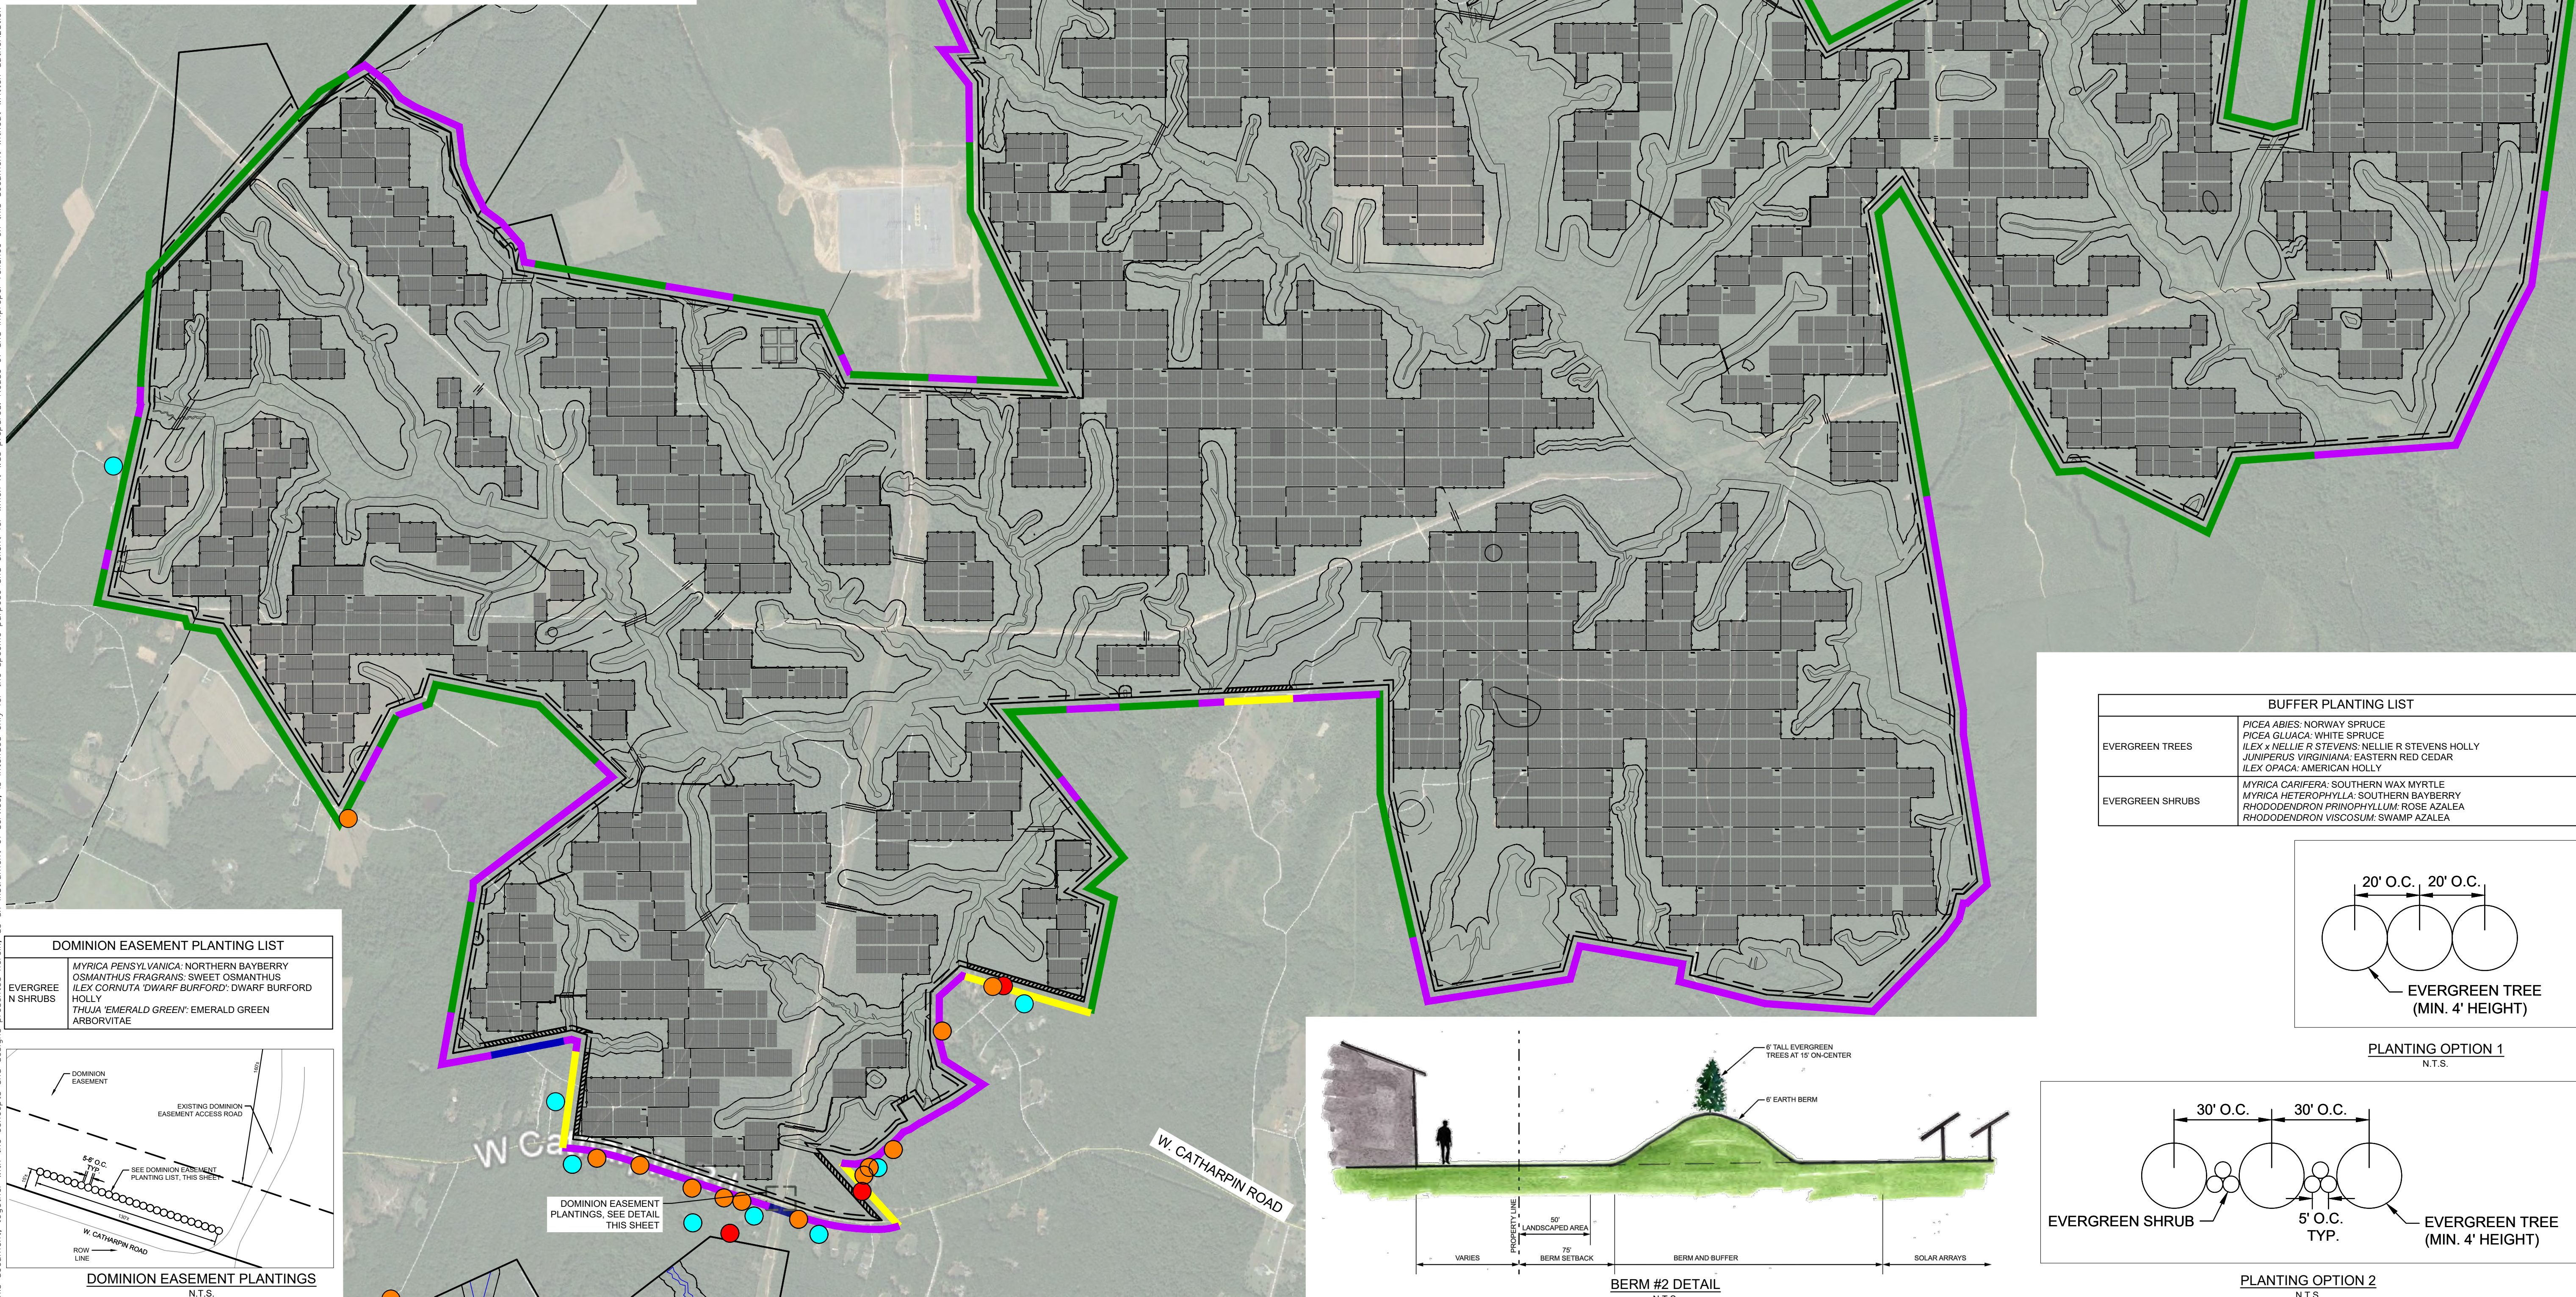
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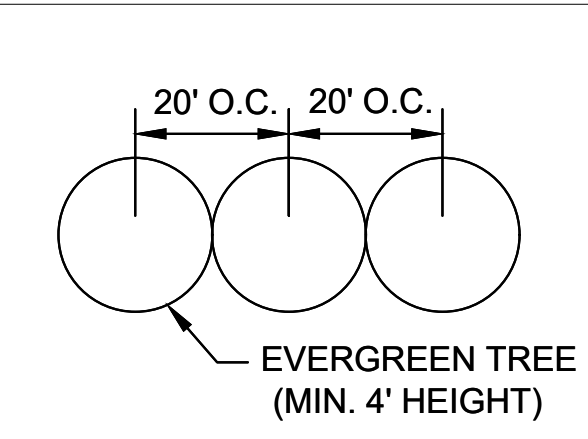


- PROPOSED BERM #1 WITH PLANTINGS PER OPTION 1 OR OPTION 2 (SEE DETAIL THIS SHEET)
- PROPOSED BERM #2 WITH SIX FOOT (6') HIGH EVERGREEN TREES PLANTED ON TOP OF BERM AT FIFTEEN FEET (15') ON-CENTER (SEE DETAIL THIS SHEET)
- PROPOSED RE-VEGETATION WITH PLANTINGS PER OPTION 1 OR OPTION 2 (SEE DETAIL THIS SHEET)
- PROPOSED RE-VEGETATION WITH SAPLINGS
- 50' MINIMUM SETBACK WITH PRESERVED VEGETATION
- 50' MINIMUM SETBACK ALLOWING VEGETATION TO GROW BACK NATURALLY
- BUILDING WITHIN 100' OF PARCEL BOUNDARY
- BUILDING WITHIN 200' OF PARCEL BOUNDARY
- BUILDING WITHIN 300' OF PARCEL BOUNDARY


- NOTES:
- BUFFER LOCATIONS SHOWN ARE APPROXIMATE AND ARE BASED ON INITIAL PANEL PROXIMITY TO ROADWAYS AND ADJACENT PROPERTIES.
 - PLANTINGS SHALL BE PER OPTION 1 AND/OR OPTION 2 DEPENDING ON PLANT AVAILABILITY AT TIME OF INSTALLATION.



BUFFER PLANTING LIST	
EVERGREEN TREES	PICEA ABIES: NORWAY SPRUCE PICEA GLAUCA: WHITE SPRUCE ILEX x NELLIE R STEVENS: NELLIE R STEVENS HOLLY JUNIPERUS VIRGINIANA: EASTERN RED CEDAR ILEX OPACA: AMERICAN HOLLY
EVERGREEN SHRUBS	MYRTICA CARIFERA: SOUTHERN WAX MYRTLE MYRTICA HETEROPHYLLA: SOUTHERN BAYBERRY RHODODENDRON PRINOPHYLLUM: ROSE AZALEA RHODODENDRON VISCOSUM: SWAMP AZALEA

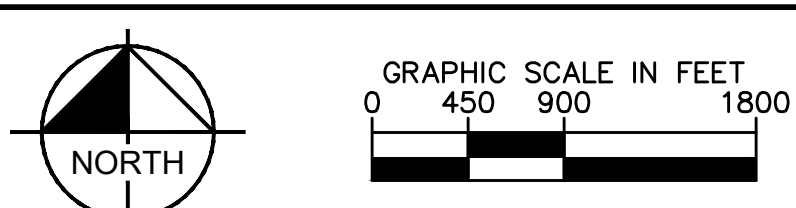


PLANTING OPTION 1
N.T.S.

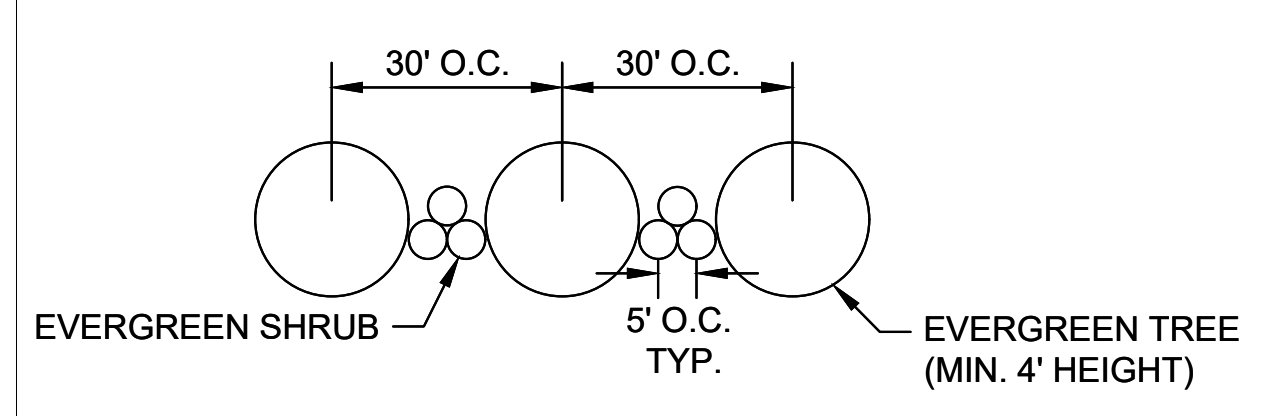

PLANTING OPTION 2
N.T.S.

DOMINION EASEMENT PLANTING LIST	
EVERGREEN TREES	MYRTICA PENNSYLVANICA: NORTHERN BAYBERRY OSMANthus FRAGRANS: SWEET OSMANthus ILEX CORNUTA: DWARF BURFORD; DWARF BURFORD HOLLY
EVERGREEN SHRUBS	THUNBERGIA: EMERALD GREEN; EMERALD GREEN ARBORVITAE

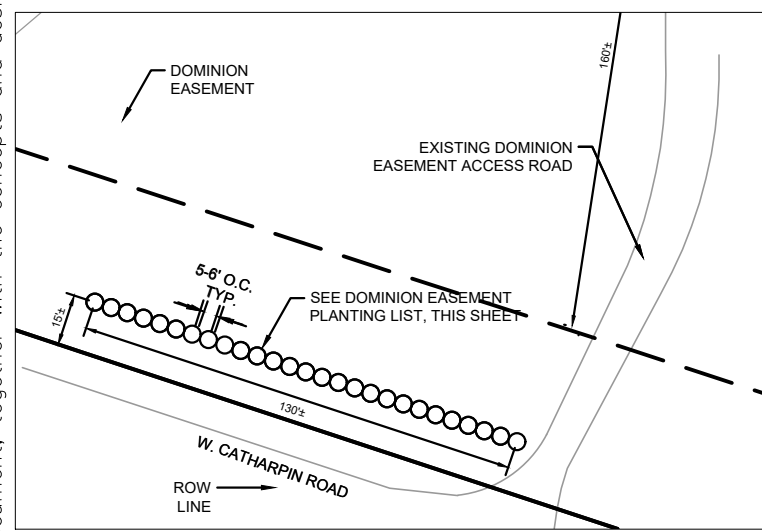

DOMINION EASEMENT PLANTINGS
N.T.S.

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SALT LAKE CITY, UT 84106
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11400 COMMERCE PARK DR., SUITE 400
RESTON, VA 20191
PHONE: 703-674-1300
WWW.KIMLEY-HORN.COM


APPROVAL

KHA PROJECT 116626000
DATE 10/26/2018
SCALE AS SHOWN
DESIGNED BY JRE
DRAWN BY JRE
CHECKED BY SWM

SUP 18-0001
LANDSCAPE AND BUFFER
AREA PLAN

SPOTSYLVANIA SOLAR
ENERGY CENTER A
PREPARED FOR
S-POWER


SHEET NUMBER
EX-2-1

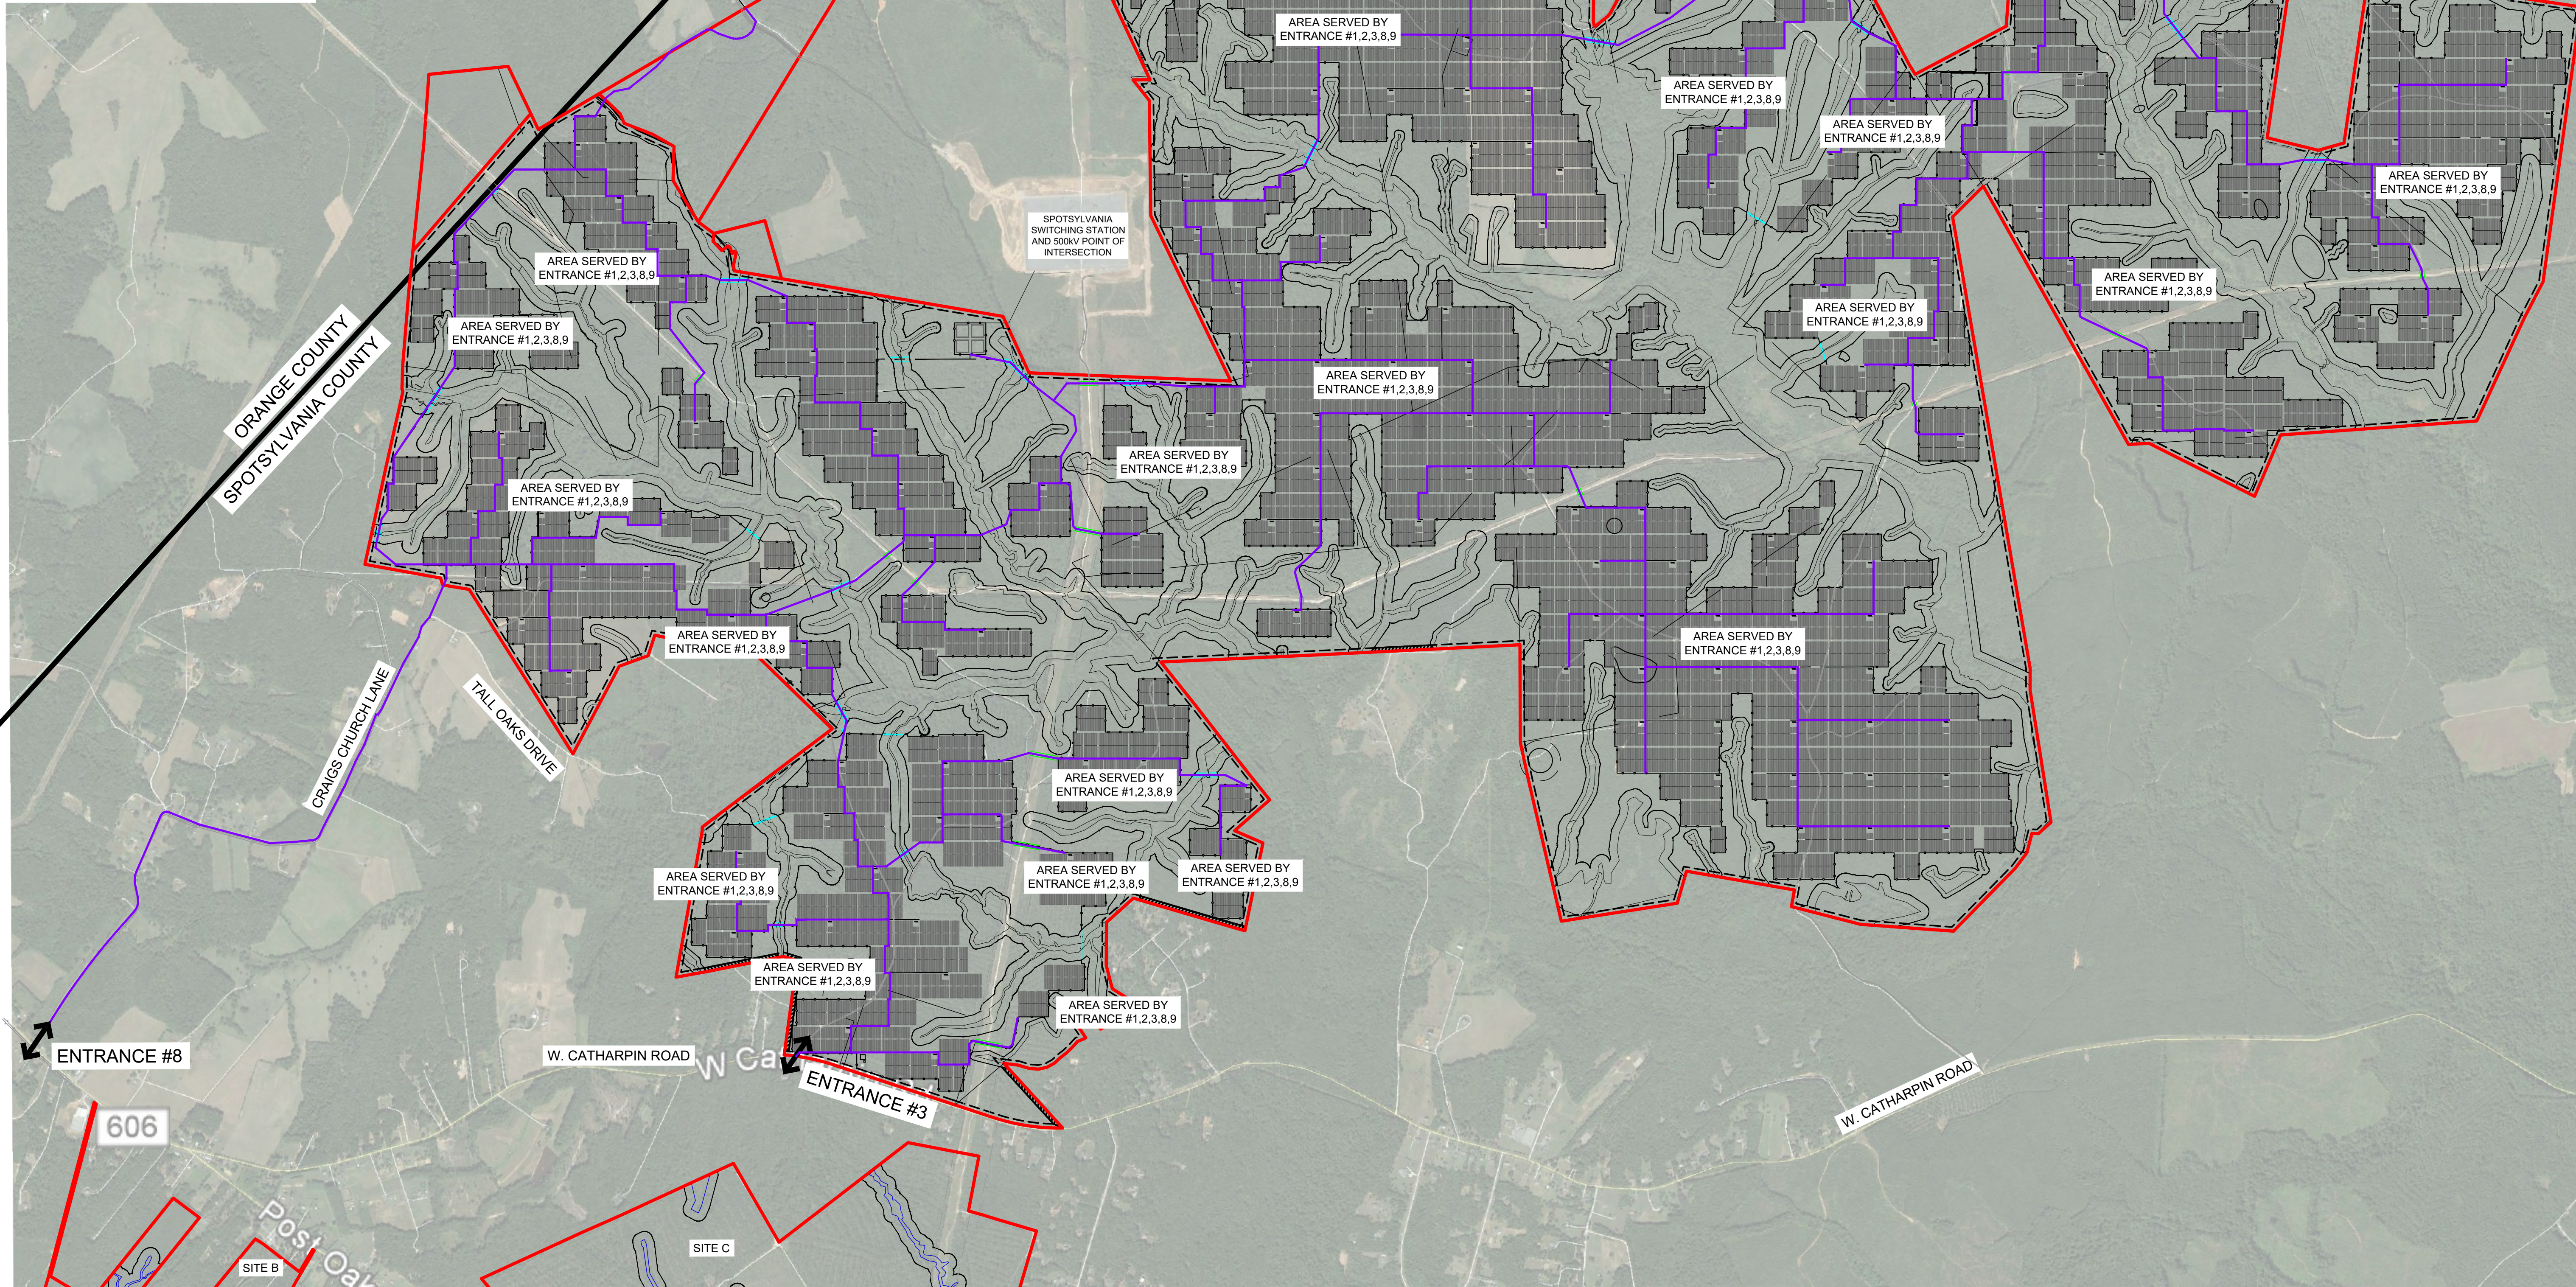

* LIMITED VEHICLE ACCESS WILL COMPLY WITH STANDARD VDOT TRUCK SIZE AND WEIGHT ALLOWANCES THAT DO NOT REQUIRE ADDITIONAL LOAD PERMITTING.

[illegible]


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
NORTH

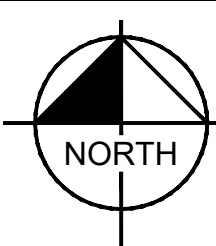GRAPHIC SCALE IN FEET


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
LAKE ANNA STATE PARK CONNECTOR TRAIL



PO RIVER TRAIL




TODD'S TAVERN SPUR



VIRGINIA CENTRAL RAILROAD

NOTES:


- TRAILS SHOWN ARE BASED ON THE SPOTSYLVANIA "TRAILWAYS MASTER PLAN" APPROVED IN 2011.
- ALL TRAILS ARE OUTSIDE THE PANEL LAYOUT AREAS, AND THEREFORE, WILL NOT COMPROMISE THE IMPLEMENTATION OF THE TRAILWAYS MASTER PLAN.

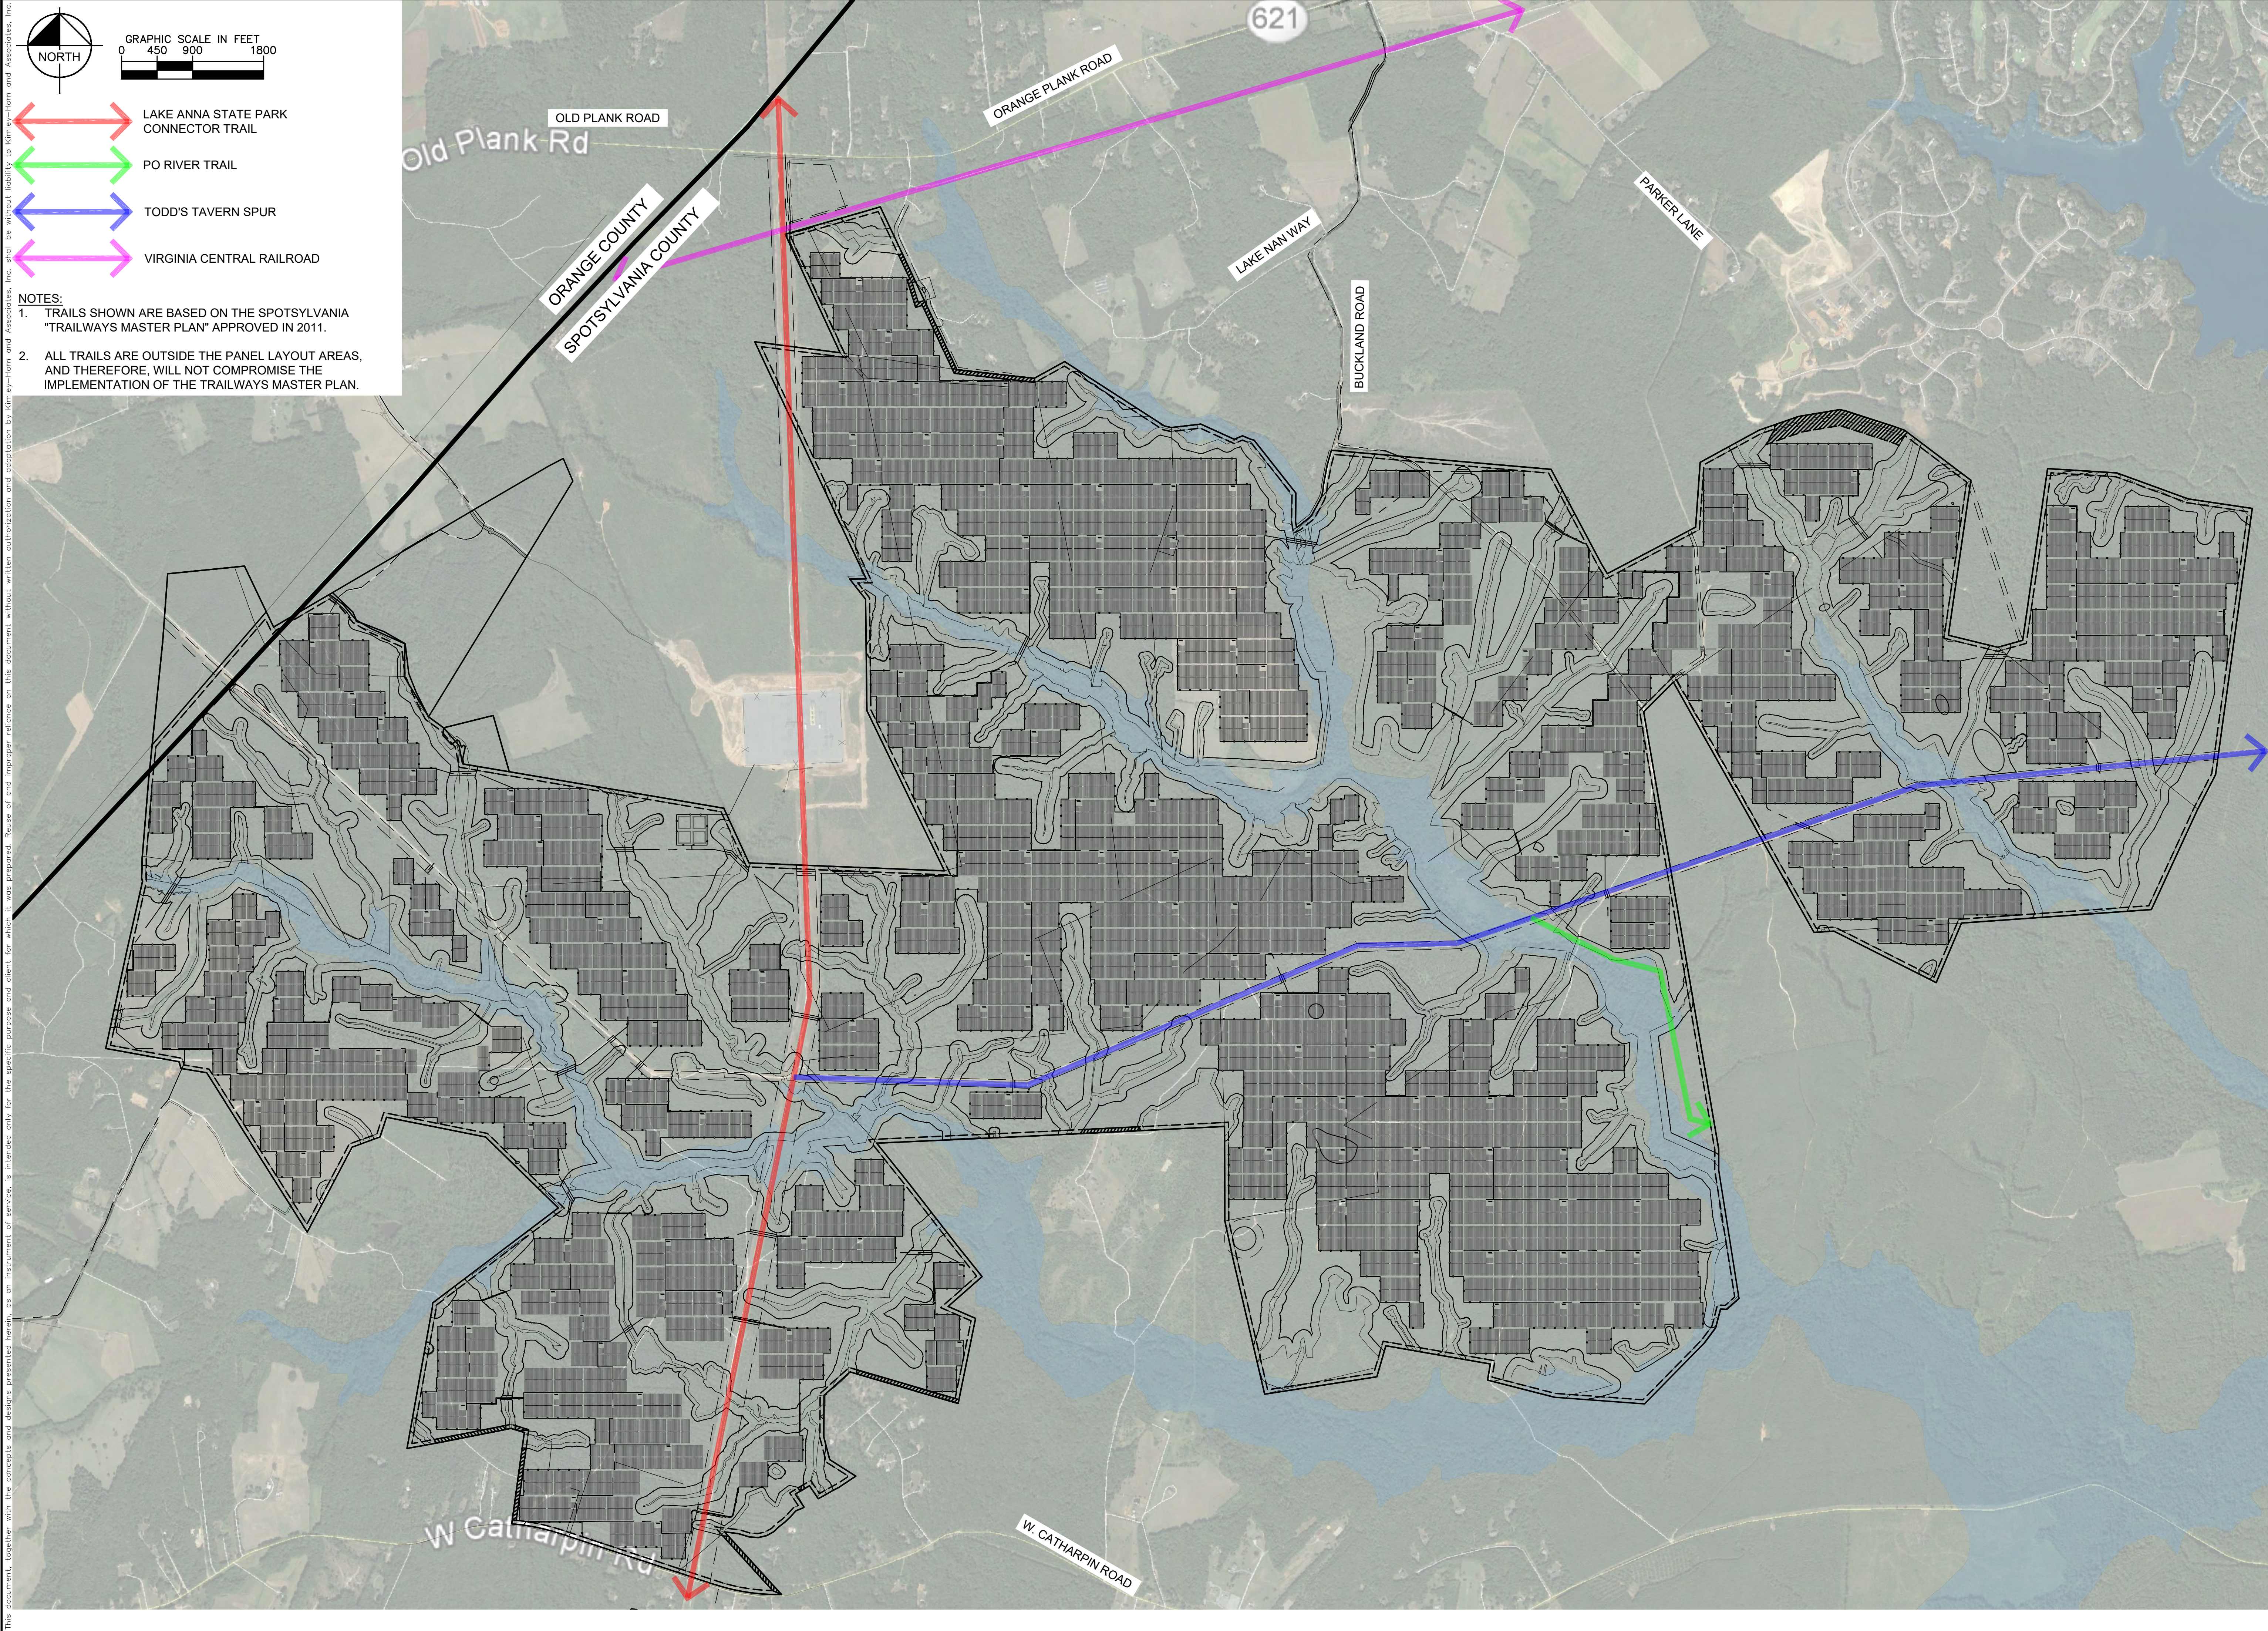

SPOTSYLVANIA SOLAR ENERGY CENTER A
PREPARED FOR
S-POWER

SUP 18-0001
COUNTY TRAIL OVERLAY
MAP

KHA PROJECT
116626000
DATE
10/26/2018
SCALE AS SHOWN
DESIGNED BY JRE
DRAWN BY JRE
CHECKED BY SWM

APPROVAL


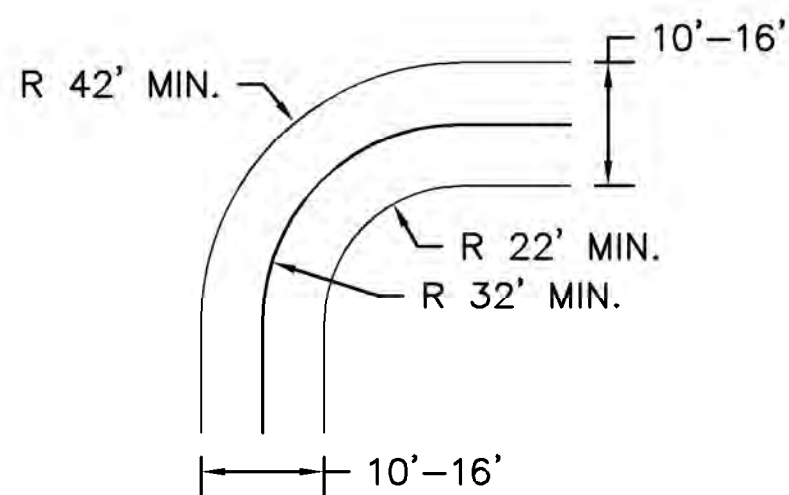
SEAN MILLOT
Lic. No. 0402052332
10/26/2018
PROFESSIONAL ENGINEER

Kimley»Horn
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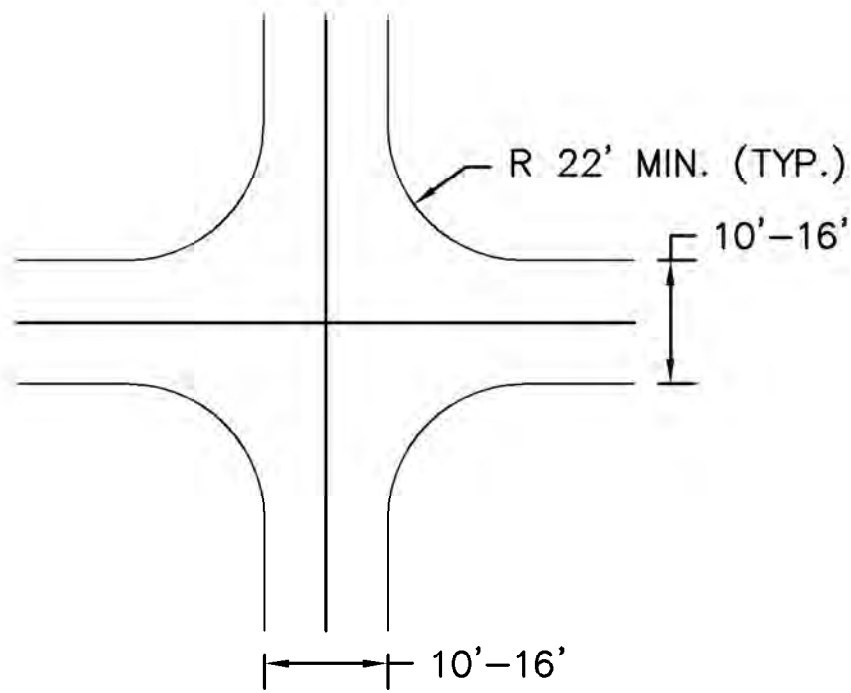
S-POWER
An AES and AIMCo Company
2180 SOUTH 1300 EAST, SUITE 600
SALT LAKE CITY, UT 84106
PHONE: 801-679-3500 FAX: 801-679-3501
WWW.SPOWER.COM

SHEET NUMBER
EX-2-3


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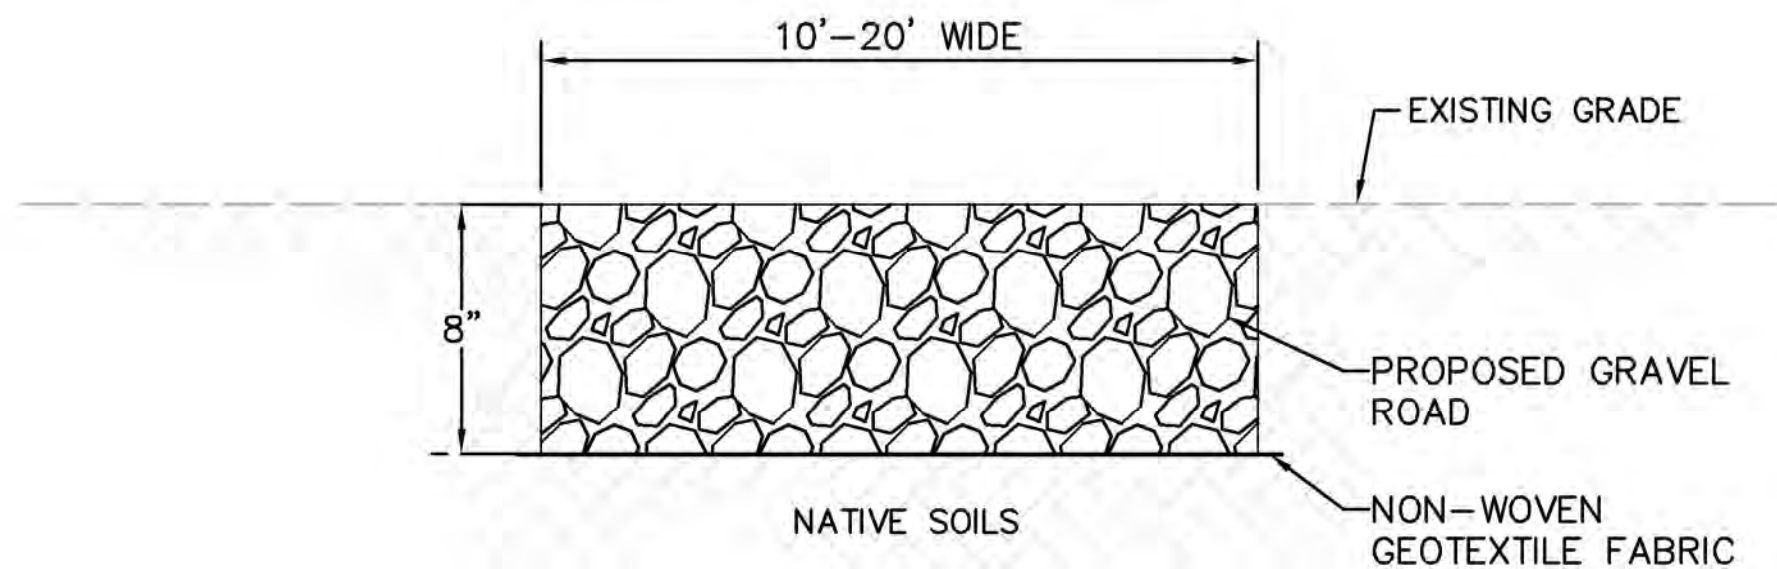
TYPICAL SITE ACCESS ROAD 90° TURN
N.T.S.



TYPICAL SITE ACCESS ROAD 4-WAY INTERSECTION
N.T.S.




TYPICAL SITE ACCESS ROAD "T" - INTERSECTION
N.T.S.

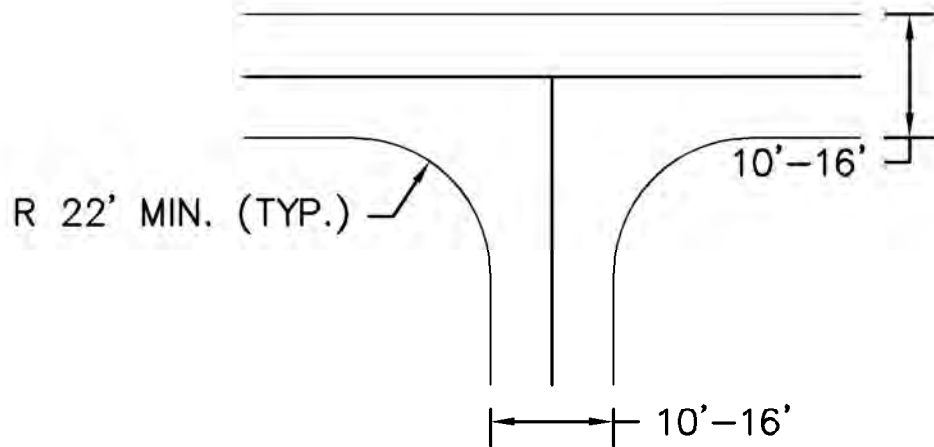


- NOTES:
1. REMOVE ALL GRASSES AND ORGANICS WITHIN ACCESS ROAD AREA.
 2. SCARIFY, MOISTURE CONDITION, AND RE-COMPACT EXISTING NATIVE SOILS TO 90% OF THE MATERIAL'S ASTM D-1557 MAXIMUM DRY DENSITY.
 3. COMPACTION SHALL BE VERIFIED BY TESTING BY THE GEOTECHNICAL CONSULTANT.


TYPICAL SITE ACCESS ROAD - GRAVEL ROAD SECTION
N.T.S.

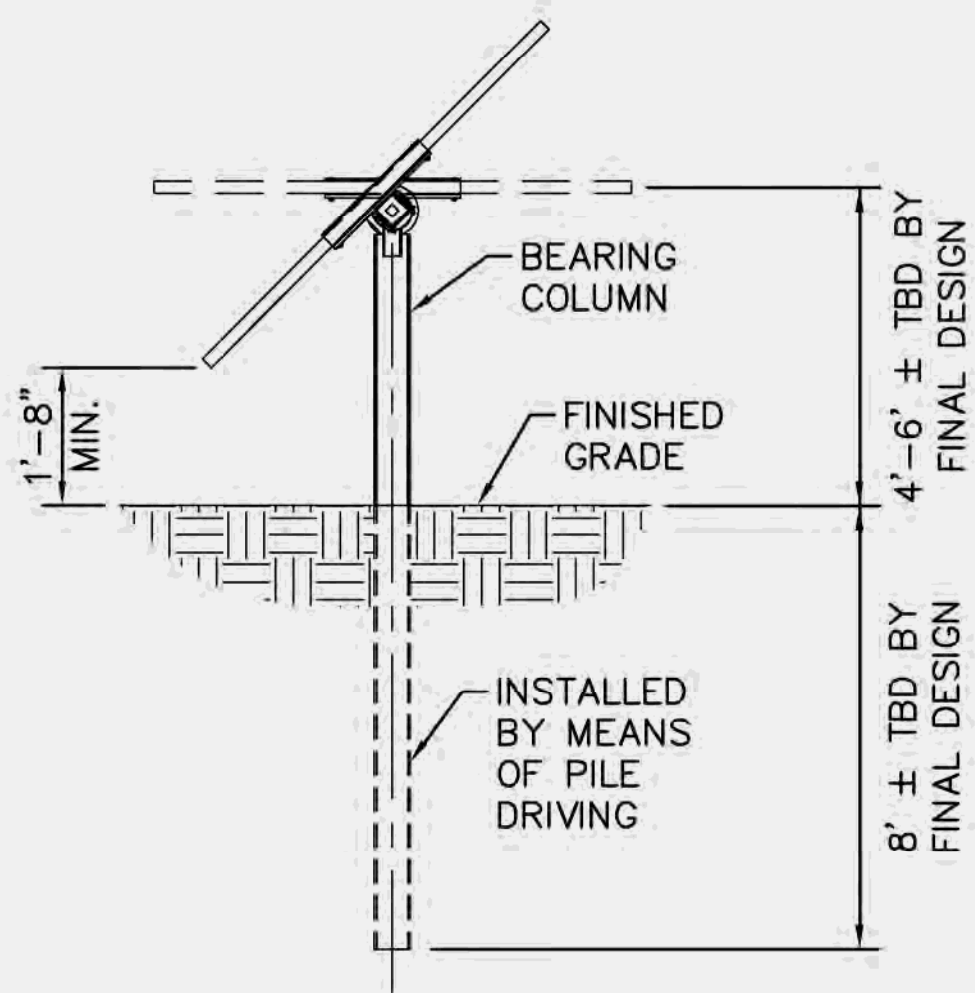


TRACKER RACK AND FOUNDATION DETAIL
N.T.S.
NOTE: ACTUAL CONSTRUCTION DETAIL OF TRACKER RACK AND FOUNDATION MAY VARY FROM THIS DETAIL.

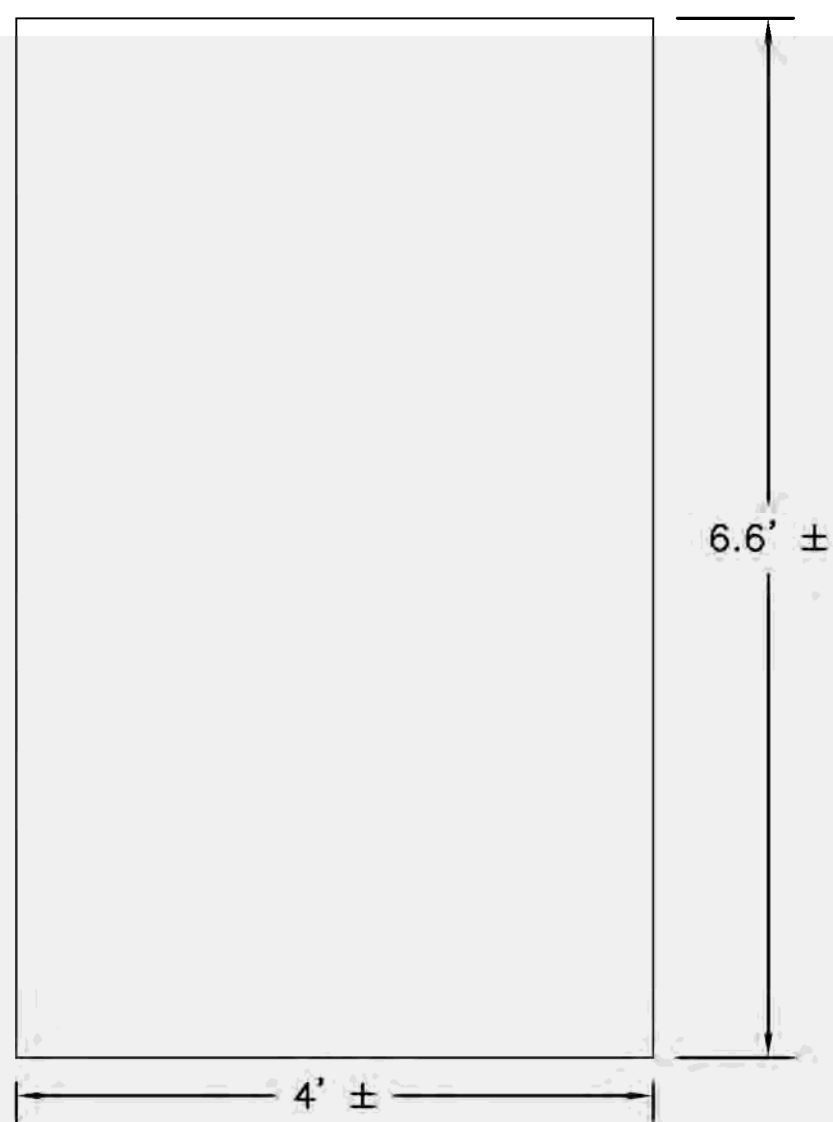


MODULE DETAIL
N.T.S.
NOTE: ACTUAL CONSTRUCTION DETAIL OF MODULE MAY VARY FROM THIS DETAIL.

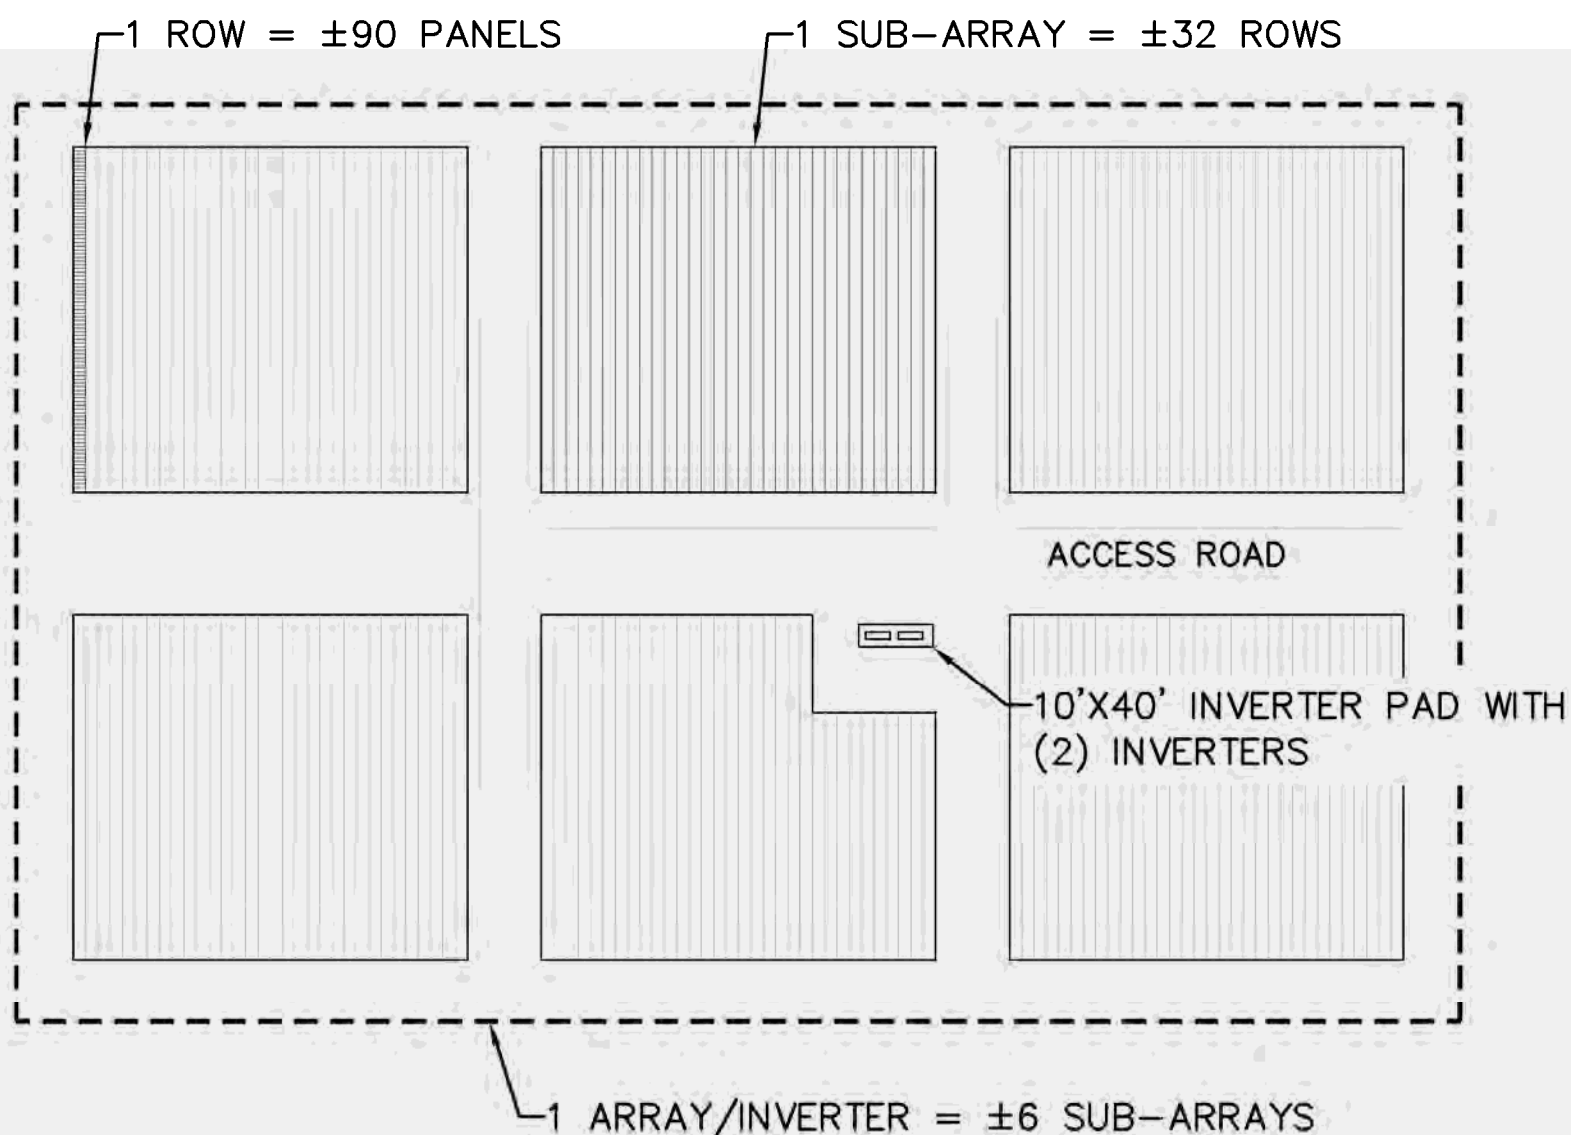


INVERTER BLOCK EXAMPLE
N.T.S.
NOTE: INVERTER PAD APPROXIMATELY 10'x40' WITH (2) 9'Lx5.5'Wx7.5'H INVERTERS SUBJECT TO FINAL ENGINEERING.

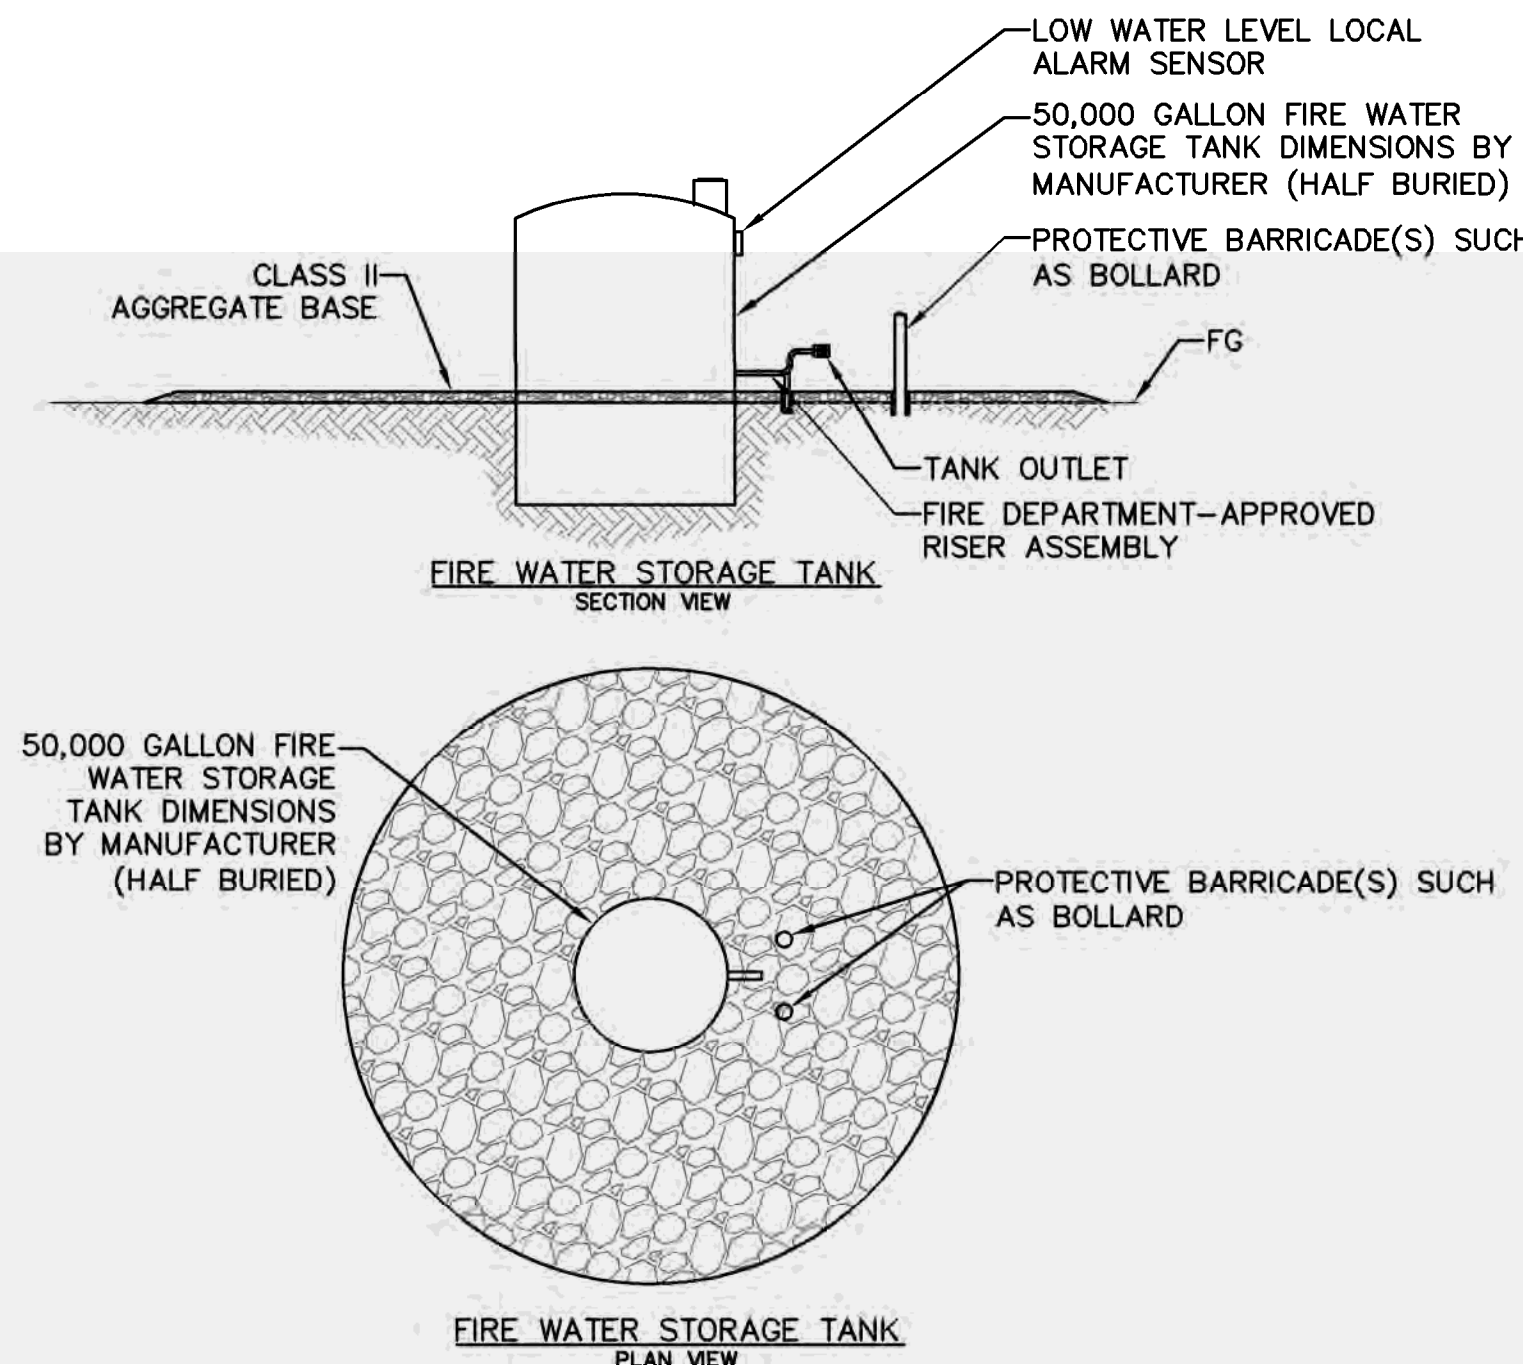


WATER TANK DETAIL
N.T.S.
NOTE: ACTUAL CONSTRUCTION DETAIL OF WATER TANK MAY VARY FROM THIS DETAIL.

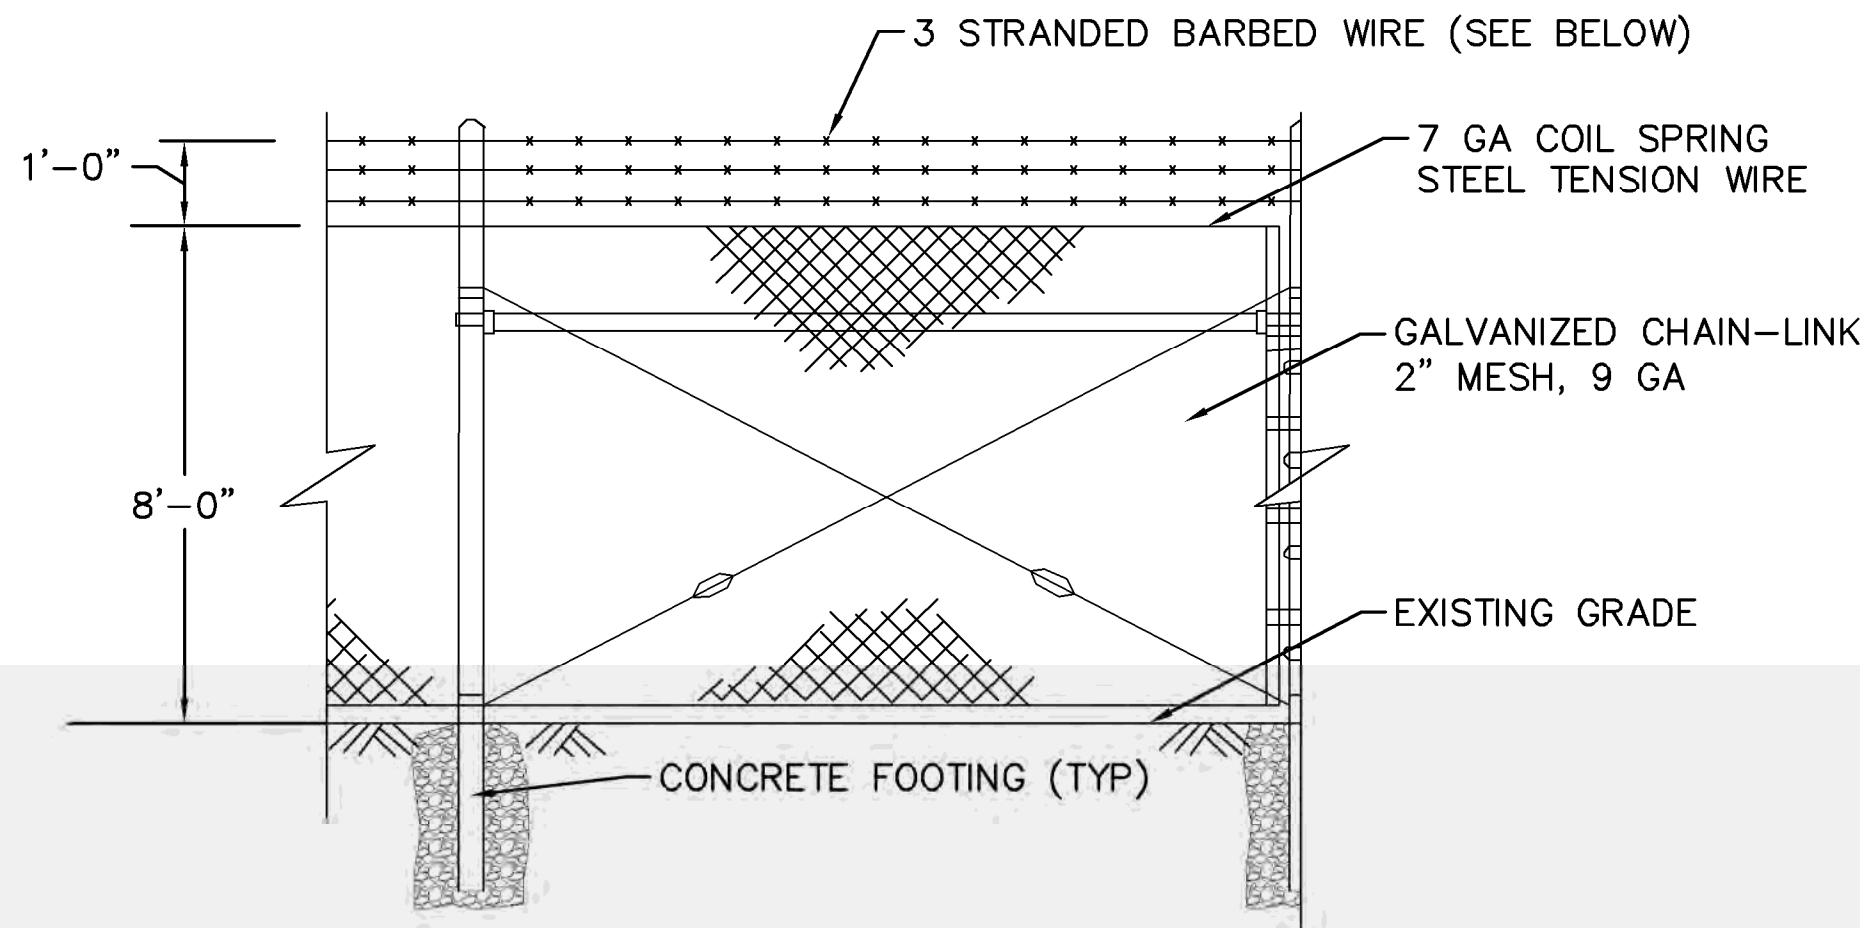

CHAIN LINK SECURITY FENCE
N.T.S.
NOTE: BARBED WIRE AT TOP OF FENCE TO ONLY BE USED AT SUBSTATION. REMAINDER OF PROJECT FENCING WILL NOT HAVE BARBED WIRE.

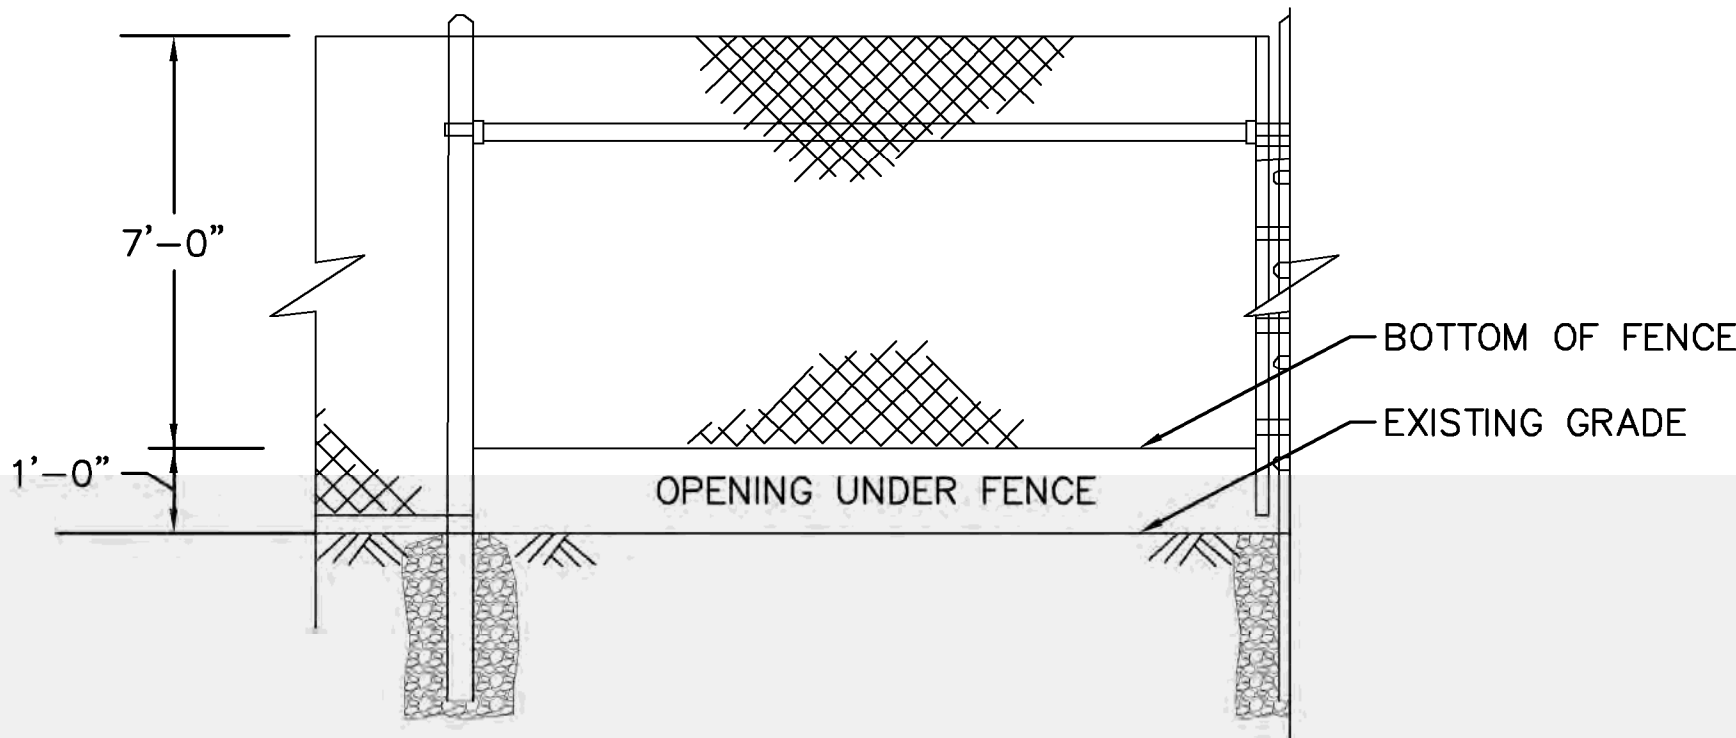

WILDLIFE FENCE
N.T.S.
NOTE: WILDLIFE FENCE WILL SPACED EVERY 2000 FEET ALONG FENCE LINE SUBJECT TO ENGINEERING AND SITE DESIGN.

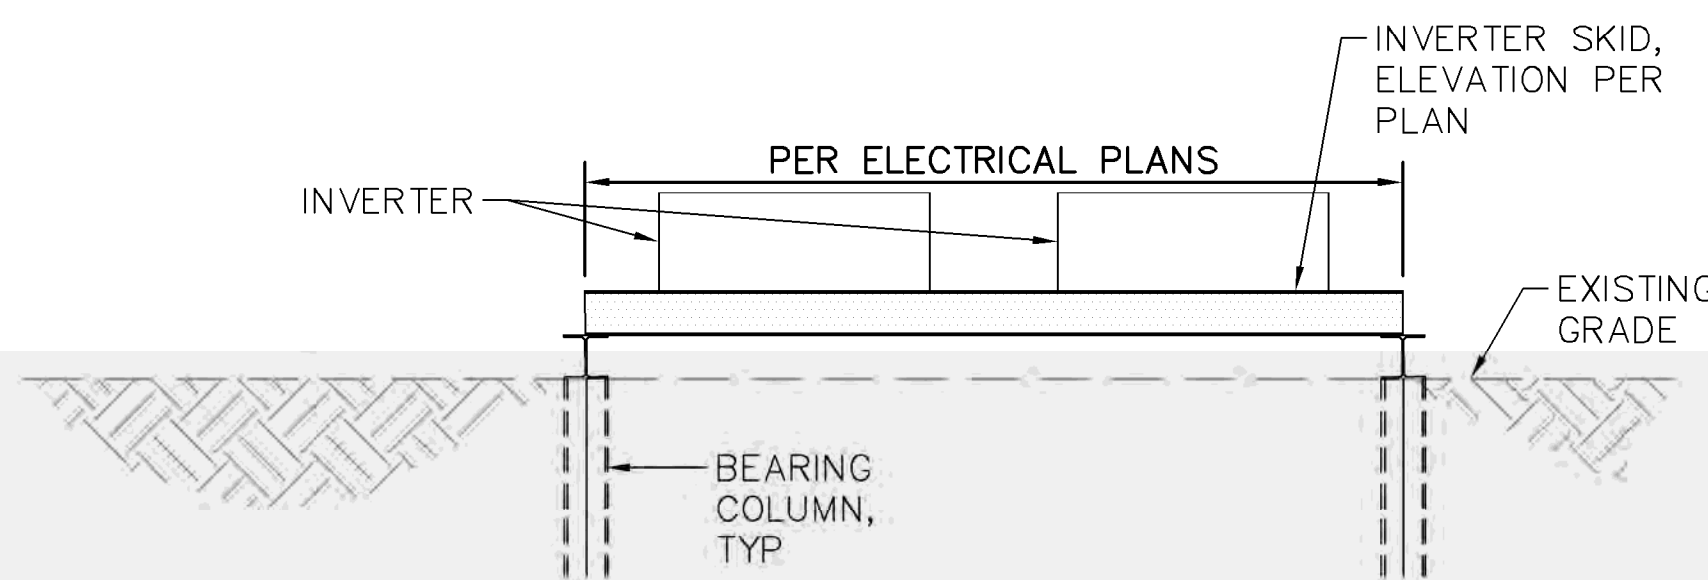

INVERTER DETAIL
N.T.S.
NOTE: INVERTER PAD APPROXIMATELY 10'x40' WITH (2) 9'Lx5.5'Wx7.5'H INVERTERS SUBJECT TO FINAL ENGINEERING.