

2000'

GRAPHIC SCALE 1"=2000'

4000'

# GENERALIZED DEVELOPMENT PLAN FOR VIRGINIA RAILWAY EXPRESS TAX MAP 37-A-41APOTOMAC & RAPPAHANNOCK TRANSPORTATION DISTRICT COMMISSION 38 & THE NORTHERN VIRGINIA TRANSPORTATION DISTRICT COMMISSION & TAX MAP 37-A-41E BERKELEY VOTING DISTRICT SPOTSYLVANIA COUNTY, VIRGINIA

# SITE DATA SUMMARY

PARCEL#

PARCEL#

TAX MAP 37-A-41E

TAX MAP 37-A-41A, PART

## RECORD OWNER

CROSSROADS ASSOCIATES LLC C/O LESTER DEVELOPMENT CORP. P.O. BOX 4991 MARTINSVILLE, VA. 24115 (276)656 - 3250

## RECORD OWNER

POTOMAC & RAPPAHANNOCK TRANSPORTATION DISTRICT COMMISSION & THE NORTHERN VIRGINIA TRANSPORTATION DISTRICT COMMISSION 2300 WILISON BLVD., ARLINGTON VA. 22201

# <u>AREA</u>

AREA

± 10.770 ACRES

± 99.1308 ACRES DEVELOPMENTAL AREA 19.514 ACRES

I-1, MU-5 EXISTING USE (VACANT) OR HISTORIC DISTRICTS NO KNOWN PLACES OF BURIAL

# CURRENT ZONING

EXISTING USE (DEVELOPED) OR HISTORIC DISTRICTS. NO KNOWN PLACES OF BURIAL. CP #91-17

- 1. THE PROPERTY LINES & PHYSICAL IMPROVEMENTS SHOWN HEREON ARE BASED ON A FIELD-RUN SURVEY PERFORMED BY JOHNSON, MIRMIRAN & THOMPSON (JMT) ON APRIL 1-4, 2016 AND REFLECT SITE CONDITIONS AS OF THAT DATE
- 2. BEARINGS & COORDINATES AS SHOWN HEREON ARE REFERENCED IN FEET TO THE NORTH AMERICAN DATUM OF 1983 (NAD 83/96) VIRGINIA NORTH (ZONE 4501) AS DETERMINED BY GPS RTK (SMARTNET) OBSERVATIONS ON JUNE 24, 2011 AND CONVERTED TO VDOT PROJECT COORDINATES
- 3. THIS SURVEY HAS BEEN PREPARED WITHOUT THE BENEFIT OF A TITLE COMMITMENT AND MAY NOT SHOW ALL ENCUMBRANCES TO THE SUBJECT PARCEL.
- 5. NO REPRESENTATIONS ARE MADE BY THE UNDERSIGNED SURVEYOR AS TO THE EXISTENCE OR LOCATION OF ANY EASEMENT OR ANY OTHER ENCUMBRANCES BEYOND THOSE SHOWN HEREON.
- 6. THE ADJOINER INFORMATION IS TAKEN FROM PUBLIC RECORDS OF THE SPOTSYLVANIA COUNTY TAX ASSESSMENT WEB SERVICE AND MAY NOT BE CURRENT OR CORRECT.
- 7. OWNER: PARCEL 37-A-41A, CROSSROADS ASSOCIATES LLC (INST.# 201300028402). PARCEL 37-A-41E, POTOMAC & RAPPAHANNOCK TRANSPORTATION DISTRICT COMMISSION & THE NORTHERN VIRGINIA TRANSPORTATION DISTRICT COMMISSION (DB 970 PG 111).
- 8. BY GRAPHICAL MEANS NO PORTION OF THE LAND HEREON IS LOCATED IN THE F.I.R.M. 100-YEAR SPECIAL FLOOD AREA ZONE "A", AS INDICATED ON FEMA FLOOD HAZARD MAPS FOR SPOTSYLVANIA COUNTY, COMMUNITY PANEL #5103080225C, WITH AN EFFECTIVE DATE OF FEBRUARY 18TH, 1998. HOWEVER THIS PROPERTY APPEARS TO FALL WITHIN ZONE "X" (AREAS OUTSIDE OF THE 500-YEAR FLOODPLAIN).
- 9. PARCEL 37-A-41A IS ZONED I-1, MU-5. PARCEL 37-A-41E IS ZONED I-1.
- 10. THERE ARE NO USGS PERENNIAL STREAMS, FLOODPLAINS, WATERBODIES, OR RPA'S CURRENTLY IDENTIFIED ON THE SITE.
- 11. SUBJECT PROPERTY AND ADJACENT PARCELS ARE WITHIN THE AIRPORT OVERLAY DISTRICT FAA TOWER ZONE ASSOCIATED WITH SHANNON AIRPORT. THERE ARE NO HEIGHT RESTRICTIONS THAT APPLY WITHIN THE TOWER ZONE AT THIS LOCATION.
- 12. SUBJECT PROPERTY IS WITHIN THE RAPPAHANNOCK RIVER/MASSAPONAX CREEK WATERSHED.
- 13. TO THE BEST OF OUR KNOWLEDGE, THERE ARE NO HISTORIC BUILDINGS, FEATURES OR PLACES OF BURIAL ON THE SUBJECT PROPERTY.

ATCH

# CURRENT ZONING

## **ADDRESS**

9442 CROSSROADS PKWY

FREDERICKSBURG, VA. 22408

PROPOSED USE (MAINTENANCE FACILITY) NO HISTORIC BUILDINGS, ARCHAEOLOGICAL FEATURES

**ADDRESS** 

PROPOSED USE (MAINTENANCE FACILITY) NO HISTORIC BUILDINGS, ARCHAEOLOGICAL FEATURES,

9400 CROSSROADS PKWY FREDERICKSBURG, VA. 22408

# DEVELOPER/APPLICANT

VIRGINIA RAILWAY EXPRESS 1500 KING STREET, SUITE 202 ALEXANDRIA, VIRGINIA 22314

CONTACT: OSCAR J. GONZALEZ ogonzalez@VRE.ORG (571) 221-7900

APPROXIMATE DISTANCE TO MAJOR	INTERSECTIONS
MAJOR INTERSECTIONS	DISTANCE (FT)
JIM MORRIS ROAD & ROUTE 17	2,200±
CROSSROADS PARKWAY	1393±

SHEET NO.

13

14


15

16

20

21

22

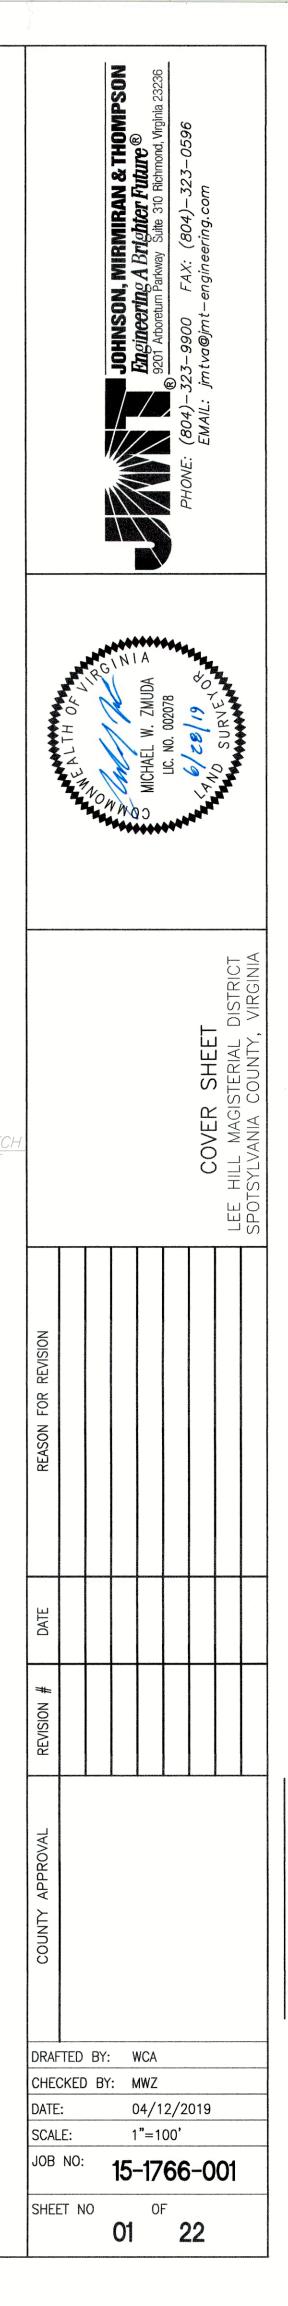

# SHEET INDEX

SITE PLA	NS:							
C-003 SITI	SURVEY &	CUP	BC	UNDARY				
C-101 EXIS	TING CONDIT	IONS a	80	DEMOLITION	PLAN	1	OF	4
C-102 EXIS	TING CONDIT	IONS	ð:	DEMOLITION	PLAN	2	OF	4
C-103 EXIS	TING CONDIT	IONS	<b>&amp;</b>	DEMOLITION	PLAN	3	OF	4
C-104 EXIS	TING CONDIT	IONS	&	DEMOLITION	PLAN	4	OF	
C-201 SITE	PLAN 1 OF	2						
C-202 SITE	PLAN 2 OF	2						
C-203 OV	RALL SITE	PLAN						
C-204 PR	OPOSED EAS	EMENTS	S	PLAN				
C-305 STO	RMWATER MA	NAGEN	AEI	NT PLAN				
C-501 UTIL	ITY PLAN 1	OF 2						
C-502 UTI	LITY PLAN 2	OF 2						
C-705 SIT	E DETAILS							
A-201 EA	ING ELEVATIO ST ELEVATIO ST ELEVATIO	N PAR	Т	A				

A-202 EAST ELEVATION PART B A-203 WEST ELEVATION PART A A-204 WEST ELEVATION PART B A-205 SOUTH ELEVATION A-206 NORTH ELEVATION A-301 BUILDING SECTION EXISTING ZONING AND LAND USE

## EXISTING STORM DRAIN STRUCTURES DATA TABLE

## YDI #2 RIM=174.40

INV OUT TO 4 15" RCP=167.14 SDMH #4 RIM=182.13 CENTERLINE INVERT=167.03 INV IN FROM UNK 6" PVC=175.91 INV IN FROM 2 15" RCP=OBSCURED VIEW INV OUT TO 5 15" RCP=167.12

### SDMH #5 RIM=182.48

CENTERLINE INVERT=162.89 INV IN FROM 4 15" RCP=OBSCURED VIEW INV IN FROM 7 24" RCP=162.90 INV IN FROM CLEAN OUT 6" PVC=178.59 INV OUT TO 39 24" RCP=162.77

## YDI #6 RIM=184.45

INV OUT TO 7 15" RCP=182.70 YDI #7 RIM=185.86

INV IN FROM ROOF DRAIN BLD C3 6" PVC=176.16 INV IN FROM 12 24" RCP=171.31 INV IN FROM 6 15" RCP=181.76 INV IN FROM 11 15" RCP=181.81

INV OUT TO 5 24" RCP=166.02 YDI #14 RIM=197.22

INV IN FROM UNK 12" PVC=192.42 INV IN FROM UNK 6" CPP=191.72 INV IN FROM UNK 6" PVC=191.87 INV OUT TO 10 15" RCP=189.82

## YDI #9 RIM=188.88 INV IN FROM UNK 6" PVC=185.34 INV OUT TO 10 15" RCP=185.35

SDMH #10 RIM=192.36 INV IN FROM 9 15" RCP=184.57 INV IN FROM CLEAN OUT 10" PVC=187.67 INV IN FROM 14 15" RCP=187.28 INV OUT TO 11 18" PVC=184.51 STRUCTURE HOLDING WATER SUPPORTS INVERT NOT FLOWING IN THE INTENDED DIRECTION YDI #11 RIM=191.66 INV IN FROM 10 18" PVC=185.56 INV OUT TO 7 15" RCP=185.51 YDI #12 RIM=194.71 INV IN FROM UNK 6" PVC=190.18 INV IN FROM UNK VAULT 8" PVC=185.71 INV IN FROM UNK VAULT 8" PVC=190.05

INV IN FROM 37 18" RCP=182.06 INV IN FROM 13 15" RCP=188.09 INV OUT TO 7 24" RCP=179.43 YDI #13 RIM=195.65

INV OUT TO 12 =15" RCP=190.01

### YDI #19 RIM=197.42

INV IN FROM UNK 6" PVE=190.52 INV IN FROM UNK 6" PVC=191.56 INV IN FROM 18 15" RCP=185.89 (TOP GRAVEL) INV OUT TO 25 =15" RCP=186.07 (TOP GRAVEL)

### SDMH #20 RIM=197.83

INV IN FROM UNK 6" PVC=187.87 INV IN FROM UNK 6" PVC=187.88 INV IN FROM UNK 6" CPP=194.38 INV IN FROM UNK 6" CPP=194.46 INV IN FROM 21 15" RCP=191.03 INV OUT TO 22 15" RCP=186.03 STRUCTURE HOLDING WATER SUPPORTS INVERT NOT FLOWING IN THE INTENDED DIRECTION

## YDI #21 RIM=195.60

INV OUT TO 20 15" RCP=190.95 YDI #22

## RIM=197.59 INV IN FROM UNK VAULT 6" PVC=193.24

INV IN FROM 20 15" RCP=186.14 (TOP GRAVEL) INV OUT TO 38 15" RCP=186.09 (TOP GRAVEL) YDI #23 RIM=197.81

INV IN FROM UNK VAULT 6" PVC=190.96 INV IN FROM UNK 6" PVC=192.71 INV IN FROM UNK 6" PVC=192.81 INV IN FROM 24 15" RCP=190.21 INV OUT TO 38 15" RCP=189.36

YDI #24 RIM=198.32 INV IN FROM UNK 6" PVC=192.72 INV IN FROM UNK 6" PVC=193.12 INV OUT TO 23 15" RCP=191.39

## YDI #25 RIM=197.45

INV IN FROM UNK 6" PVC=192.15 INV IN FROM UNK 6" PVC=191.42 INV IN FROM 19 15" RCP=185.64 INV OUT TO 26 15" RCP=185.94 YDI #26 RIM=197.68


INV IN FROM UNK 6" PVC=192.03 INV IN FROM UNK 6" PVC=191.73 INV IN FROM 25 15" RCP=185.16 INV OUT TO 37 15" RCP=185.16

## YDI #27 RIM=197.87

INV IN FROM UNK 6" PVC=190.97 INV IN FROM UNK 6" PVC=191.27 INV OUT TO 37 15" RCP=188.46

## YDI #37 RIM=196.68

INV IN FROM 38 21" RCP=185.63 INV IN FROM 26 12" RCP=184.63 INV IN FROM UNK 6" PVC=189.13 INV IN FROM 27 15" RCP=187.11 INV OUT TO 12 18" RCP=184.02

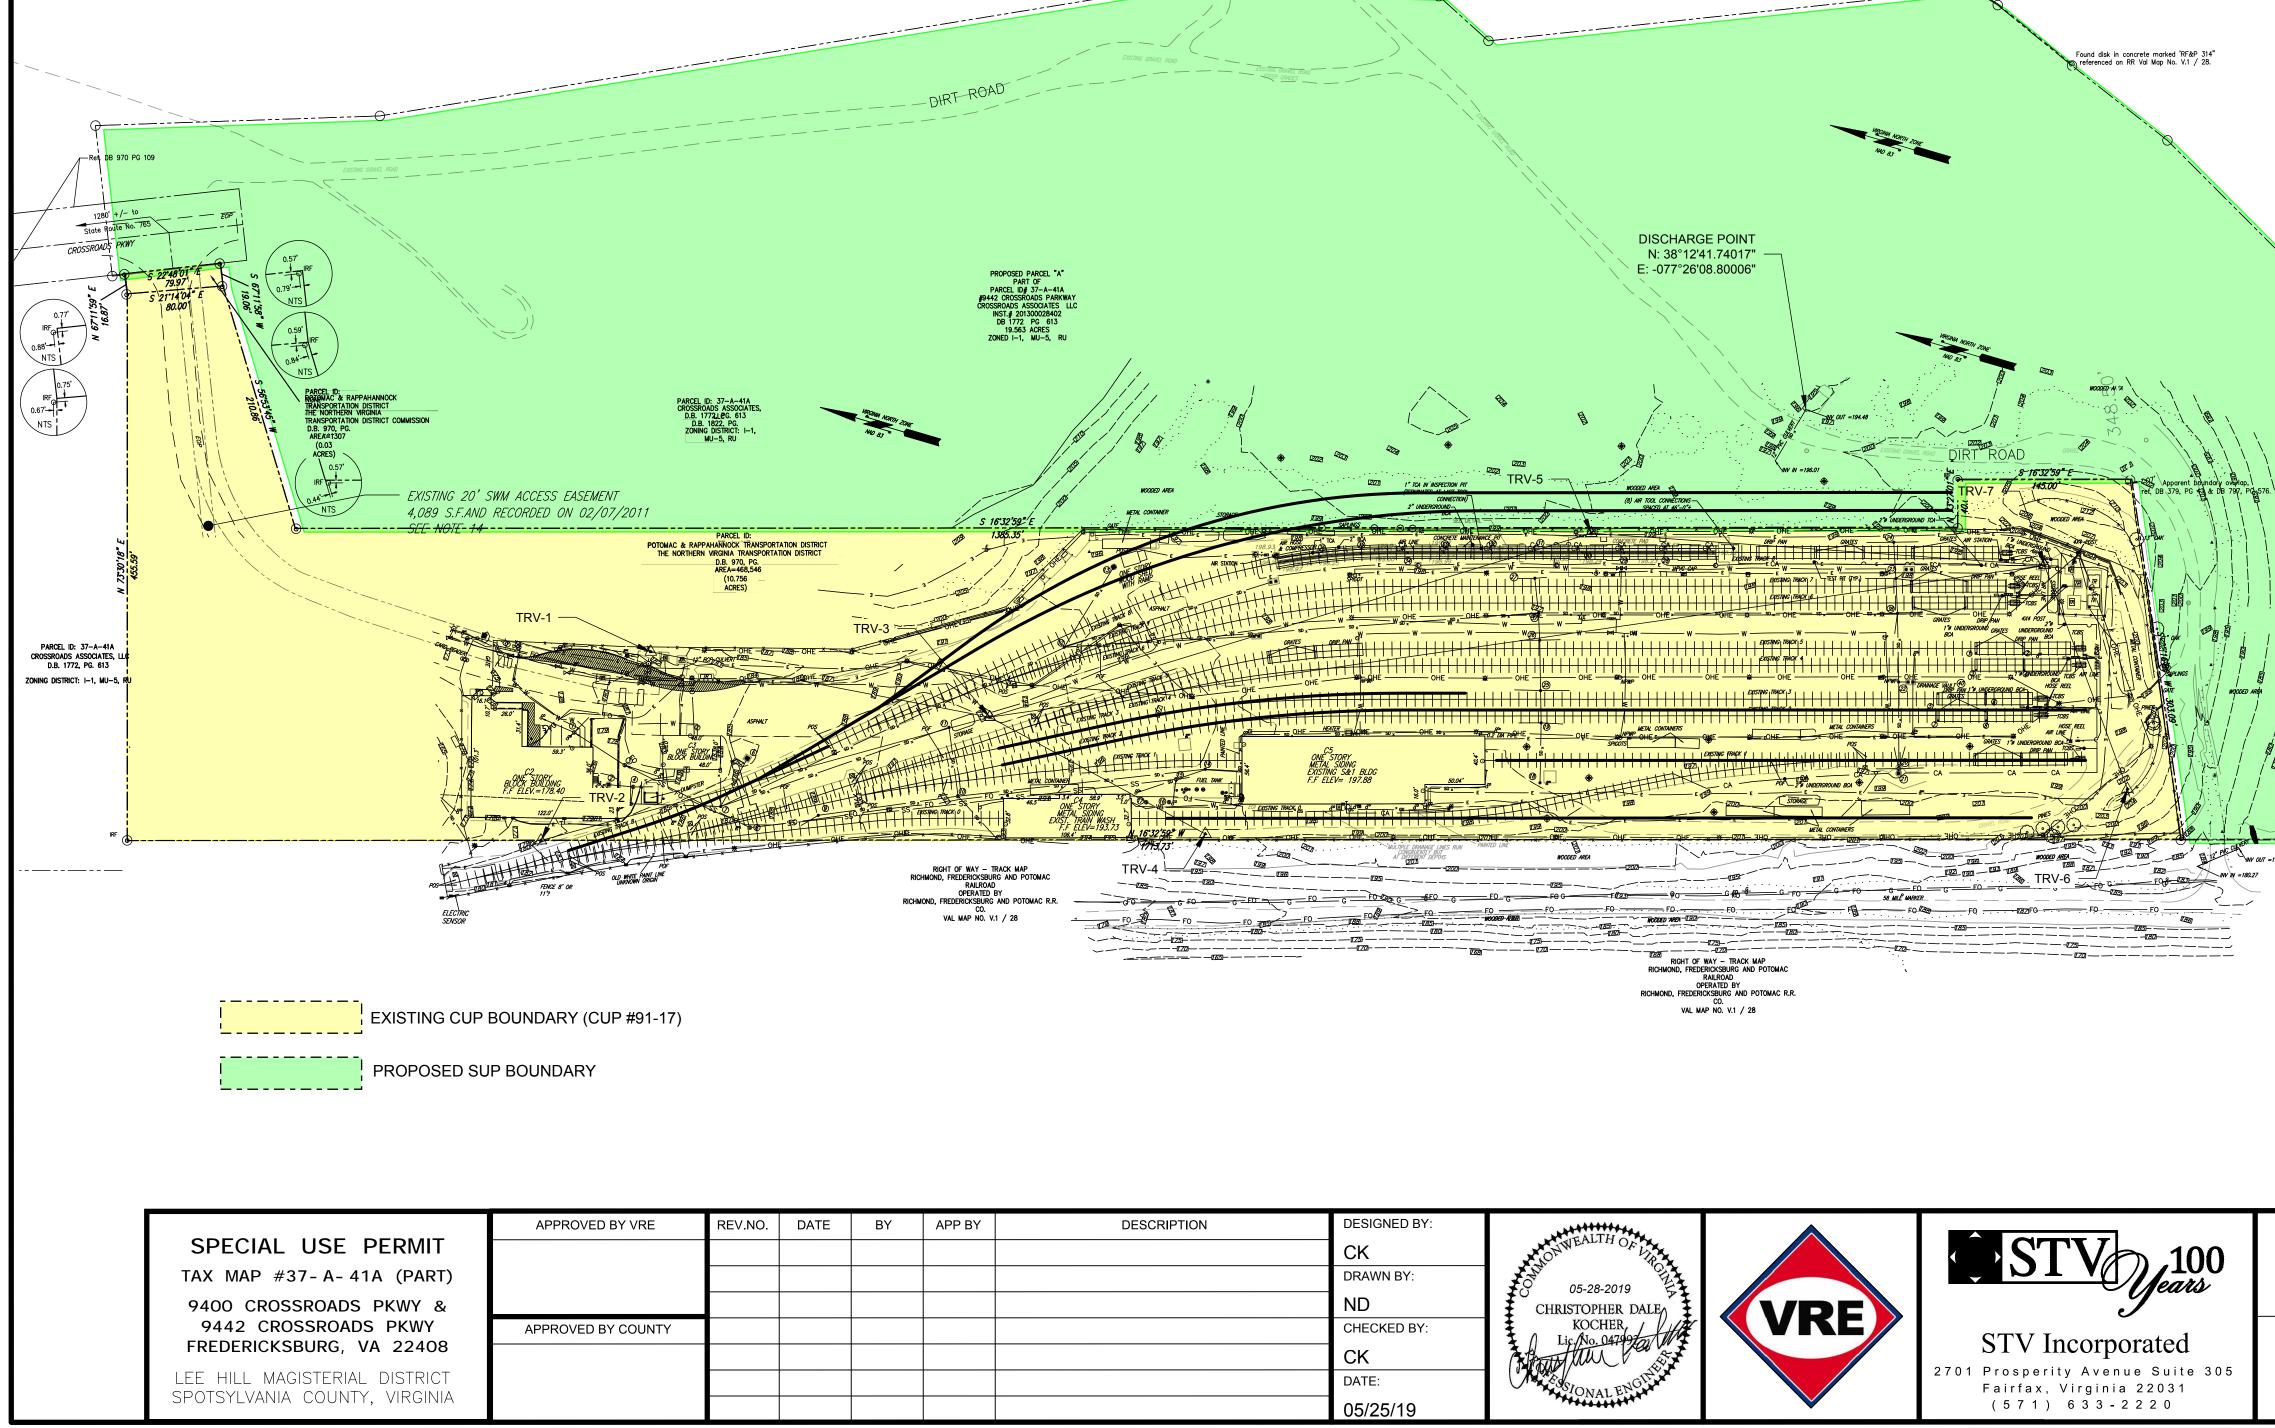

YDI #38 RIM=196.75

INV IN FROM 23 15" RCP=188.10 INV IN FROM UNK=186.73 INV IN FROM UNK 6"PVC=194.15 INV IN FROM 22 15" RCP=185.85 INV IN FROM UNK 6" PVC=186.36 INV IN FROM UNK 6" PVC=194.06 INV OUT TO 37 21" RCP=185.85

## YDI #39 RIM=162.88

INV IN FROM UNK 15" RCP=156.58 INV IN FROM 5 24" RCP=156.80 INV IN FROM UNK 15" RCP=153.03 INV IN FROM CLEAN OUT 6" PVC=159.43 INV OUT TO UNK 24" RCP=148.04

## **EXISTING SANITARY** STRUCTURE DATA TABLE

SMH #1 RIM=178.30 INV IN FROM UNK 6" PVC (DROP PIPE)=169.64 RIM="187.51 INV IN FROM CLEAN OUT 4" PVC=173.25 INV IN FROM 3 8" PVC=168.90 INV OUT TO CLEAN OUT 8" PVC=168.72

## SMH #3 RIM=181.19


INV IN FROM CLEAN OUT 6" PVC=171.60 INV IN FROM 8 8" PVC=178.09 INV OUT TO 1 8" PVC=171.50


SMH #8 INV IN FROM 15 8" PVC=183.83 INV OUT TO 3 8" PVC=182.96

SMH #15 RIM=197.40 INV IN FROM UNK 6" PVC=188.12 INV IN FROM UNK 6" PVC=189.27 INV OUT TO 8 8" PVC=187.95

EXISTING INACCESS		EXISTING INACCESSIBLE SANITARY STRUCTURE DATA TABLE
YDI #18 RIM=197.89 FULL OF DEBRIS YDI #28 RIM=193.64 INV TO BOTTOM OF STRUCTURE=191.32 YDI #29 RIM=193.63 INV TO BOTTOM OF STRUCTURE=190.98 YDI #30 RIM=193.64 INV TO BOTTOM OF STRUCTURE=190.64 YDI #31 RIM=193.65 INV TO BOTTOM OF STRUCTURE=190.08	YDI #32         RIM=193.66         INV TO BOTTOM OF STRUCTURE=189.81         YDI #33         RIM=193.68         INV TO BOTTOM OF STRUCTURE=189.33         YDI #34         RIM=193.70         INV TO BOTTOM OF STRUCTURE=189.20         YDI #35         RIM=193.68         INV TO BOTTOM OF STRUCTURE=188.93         YDI #36         RIM=193.66         INV TO BOTTOM OF STRUCTURE=188.51	SMH #16 RIM=197.38 FULL OF WATER SMH #17 RIM=196.76 FULL OF WATER ELEVATION TO BOTTOM OF DRAINAGE STRUCTURE $\widehat{O} = 194.96$ $\widehat{O} = 194.82$ $\widehat{O} = 194.84$ $\widehat{O} = 194.84$ $\widehat{O} = 194.79$ $\widehat{O} = 194.48$ $\widehat{O} = 194.82$
		CONTROL POINT TABLE

	CONTRO	OL POINT TABLE	
NO.	NORTHING	EASTING	ELEV.
TRV-1	6762748.15	11788221.41	183.02
TRV-2	6762791.27	11788044.68	179.44
TRV-3	6762461.96	11788249.50	193.28
TRV-4	6762262.03	11788207.28	198.03
TRV-5	6762024.83	11788538.97	199.02
TRV-6	6761535.92	11788461.54	205.04
TRV-7	6761655.13	11788620.64	198.49

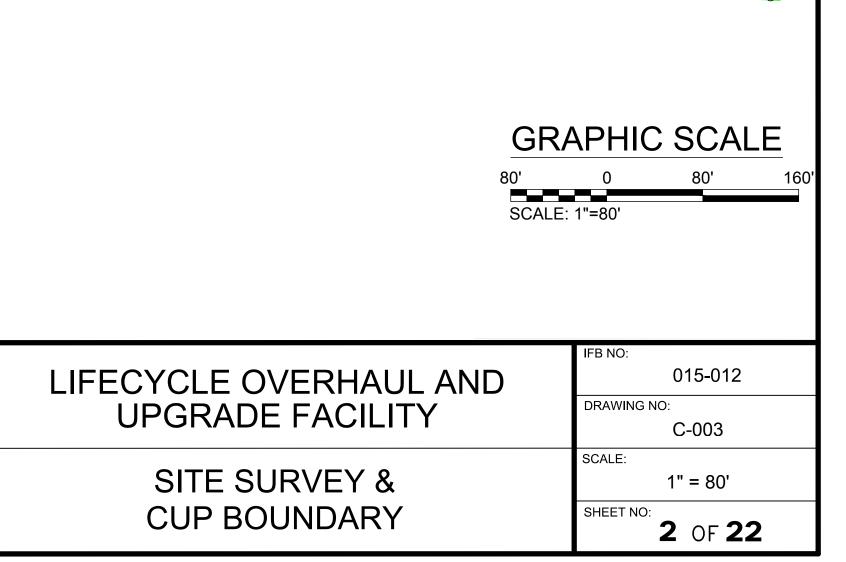


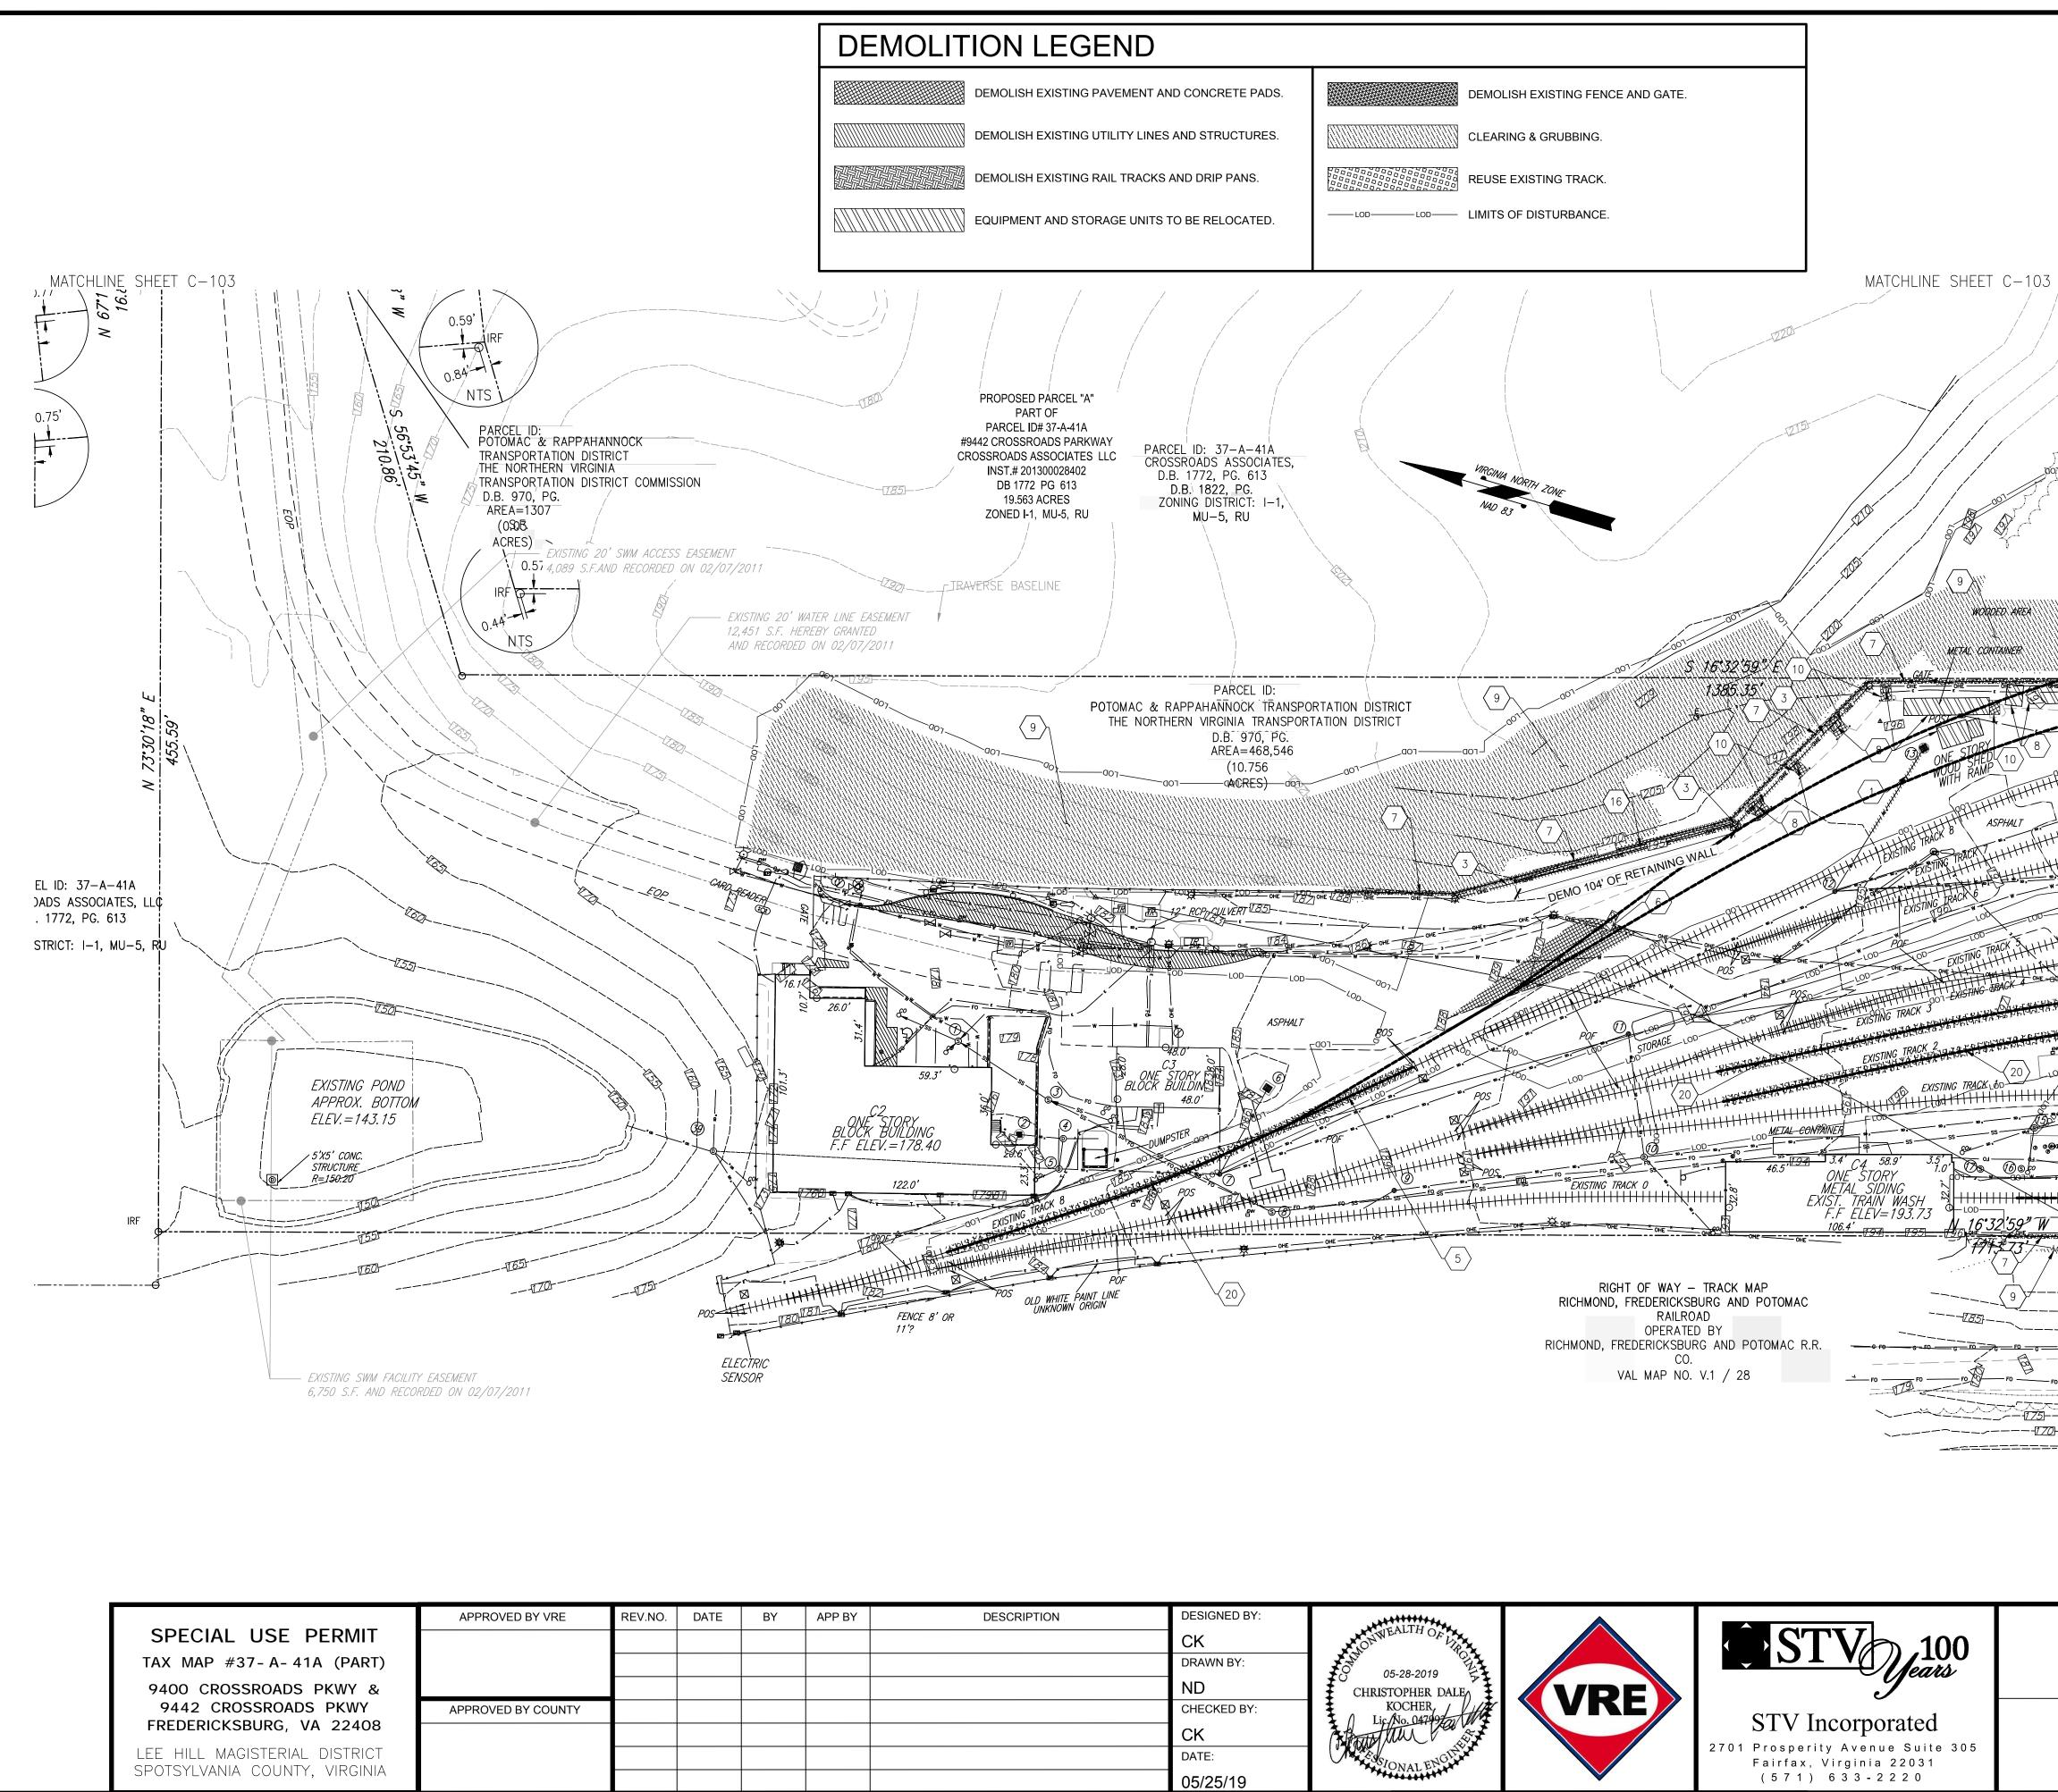

DESCRIPTION	DESIGNED BY:	MANAGE ALTER OF			
	СК	NONWEALINOFUR		$\square$ STV $\square$ .100	
	DRAWN BY:	05-28-2019		Means	
	ND	CHRISTOPHER DALE		9	
	CHECKED BY:	KOCHER, Lic.No. 04799777	VNC	STV Incorporated	
	CK	3 Auto Mill 1 23		_	
	DATE:	MARSONAL ENGLIST		2701 Prosperity Avenue Suite 305 Fairfax, Virginia 22031	
	05/25/19	Presented and the second	×	(571) 633-2220	

DEMOLITION NOTES	
<ol> <li>THE CONTRACTOR SHALL COORDINATE WITH VRE PRIOR TO D ITEMS THAT ARE TO BE SALVAGED TO VRE. ALL SALVAGEABLE LOCATIONS DIRECTED BY VRE. ALL NON-SALVAGED ITEMS ARE SHALL BE DISPOSED OFF-SITE BY THE CONTRACTOR.</li> <li>CONTRACTOR SHALL PROVIDE NECESSARY MEANS TO PROTEC TO THE SITE THROUGHOUT CONSTRUCTION.</li> <li>THE CONTRACTOR SHALL CONTACT ALL UTILITY COMPANIES PI SITE, TO VERIFY UTILITIES WHICH ARE IN SERVICE AND ABANDO WITH VRE PRIOR TO DEMOLITION PLAN LIMITS NOT SHOWN S WITH VRE PRIOR TO DEMOLITION.</li> <li>UPON COMPLETION OF PROJECT WORK, THE CONTRACTOR SH EQUIPMENT, TOOLS, AND MATERIALS NOT RETAINED IN ACCOR REGULATIONS.</li> <li>THE CONTRACTOR SHALL CONTACT "MISS UTILITY" AT 1-800-555 EXISTING UNDERGROUND UTILITIES (i.e. WATER, SEWER, GAS, AT LEAST 72 HOURS PRIOR TO ANY EXCAVATION OR CONSTRUCT</li> </ol>	ITEMS SHALL BE DELIVERED TO THE PROPERTY OF THE CONTRACTOR AND CT THE PUBLIC AND TO PROHIBIT ACCESS ROVIDING SERVICES FOR THE SUBJECT ONED BEFORE DEMOLITION. SHALL BE IDENTIFIED AND COORDINATED ALL PROPERLY DISPOSE OF ALL WASTE, DANCE WITH ALL APPLICABLE RULES AND 2-7001 FOR MARKING THE LOCATIONS OF TELEPHONE, ELECTRIC, AND CABLE TV)
AT LEAST 72 HOURS PRIOR TO ANY EXCAVATION OR CONSTRUCT TO IDENTIFY AND PROTECT ALL OTHER UTILITY LINES FOUND IN OTHER OWNERS THAT ARE NOT MEMBERS OF "MISS UTILITY".	
	S
	STRUCTURES AS SHOWN.
1 DEMOLISH AND REMOVE EXISTING STORM DRAIN LINE AND 2 NOT USED. 3 DEMOLISH OVERHEAD ELECTRICAL LINES AND LITULITY POL	
	ES. SEE ELECTRICAL PLANS FOR DETAILS.
4   NOT USED.	
5       DEMOLISH AND REMOVE EXISTING RAIL TRACKS 2, 3 AND 8         AND SWITCHES.	. REMOVE AND REUSE EXISTING RAIL, TIES
6 DEMOLISH AND REMOVE EXISTING PAVEMENT.	
$\left\langle \begin{array}{c} 7 \end{array} \right\rangle$ DEMOLISH AND REMOVE EXISTING FENCE AND GATE.	
	EQUIPMENT. CONTRACTOR TO DEMOLISH
CLEARING AND GRUBBING.	
$\begin{pmatrix} 10 \\ 10 \end{pmatrix}$ DEMOLISH EXISTING CONCRETE PAD. $\langle 11 \rangle$ NOT USED.	
$\sqrt{12}$ NOT USED.	
(13) NOT USED.	
$\begin{array}{c} 13 \\ \hline 14 \\ \hline 14$	
$\sim$ $\langle 15 \rangle$ NOT USED.	
	L.
17 NOT USED.	
$\frac{18}{18}$ NOT USED.	
19 NOT USED.	
20 REUSE EXISTING TRACK.	
KEY	MAP
C-103	C-104
E	C-102
Z	
G 40'	RAPHIC SCALE
	0 40' 80
SC.	ALE: 1"=40'
	IFB NO:
LIFECYCLE OVERHAUL AND	015-012
UPGRADE FACILITY	DRAWING NO: C-101
	SCALE:
EXISTING CONDITIONS &	1" = 40' SHEET NO:
DEMOLITION PLAN 1 OF 4	<b>3</b> OF <b>22</b>

MATCHLINE SHEET C-104 PROPOSED PARCEL "A" PART OF PARCEL ID# 37-A-41A #9442 CROSSROADS PARKWAY CROSSROADS ASSOCIATES LLC INST.# 201300028402 ۵ DB 1772 PG 613 19.563 ACRES ZONED I-1, MU-5, RU Ã BOR:B13  $\langle Q_{3} \rangle$ 202 BOR:B 203 202 WOODED AREAN !!! //EXEXXXEEXXXXXX// V&X /AXP / XOOK / KOMMEET XONS / +++ 1,217,WWQEXRGXROUMQ+1 11114584784784 1000 - <u>815 1 - 2815 - -</u> 1<u>799</u> 861 CONCRETE MAINTENANCE <u>AIR LINE</u> \_\_\_\_\_\_ ca \_\_\_\_\_ ca \_\_\_\_ ca \_\_\_\_\_ ca \_\_\_\_ c COMPRESSOR CO CA CA CA AIR STATION 
 Image: е \_\_\_\_\_е <u>с</u> е \_\_\_\_\_е w \_\_\_\_\_е w \_\_\_\_\_е SPIGOT DRIP PAN -**〈**12〉 ┊╫╪╪╪╪╪┲┯┥ if the second se - OHE OOT OHE  $\mathbb{Z}^2$ \_\_\_\_\_ SD \_\_\_\_ WIETHAL CONTAINTERISE F BOR:B2 EXISTING S&1 BLDG F.F ELEV= 197.88 œ œ BOR:B4 -200-HURRAN HILLING, BOR: B.3 WARDORD WARES 197 FO G FO RICHMOND, FREDERICKSBURG AND POTOMAC R.R. APP BY APPROVED BY VRE REV.NO. DATE BY SPECIAL USE PERMIT TAX MAP #37-A-41A (PART) 9400 CROSSROADS PKWY & 9442 CROSSROADS PKWY APPROVED BY COUNTY FREDERICKSBURG, VA 22408 LEE HILL MAGISTERIAL DISTRICT SPOTSYLVANIA COUNTY, VIRGINIA

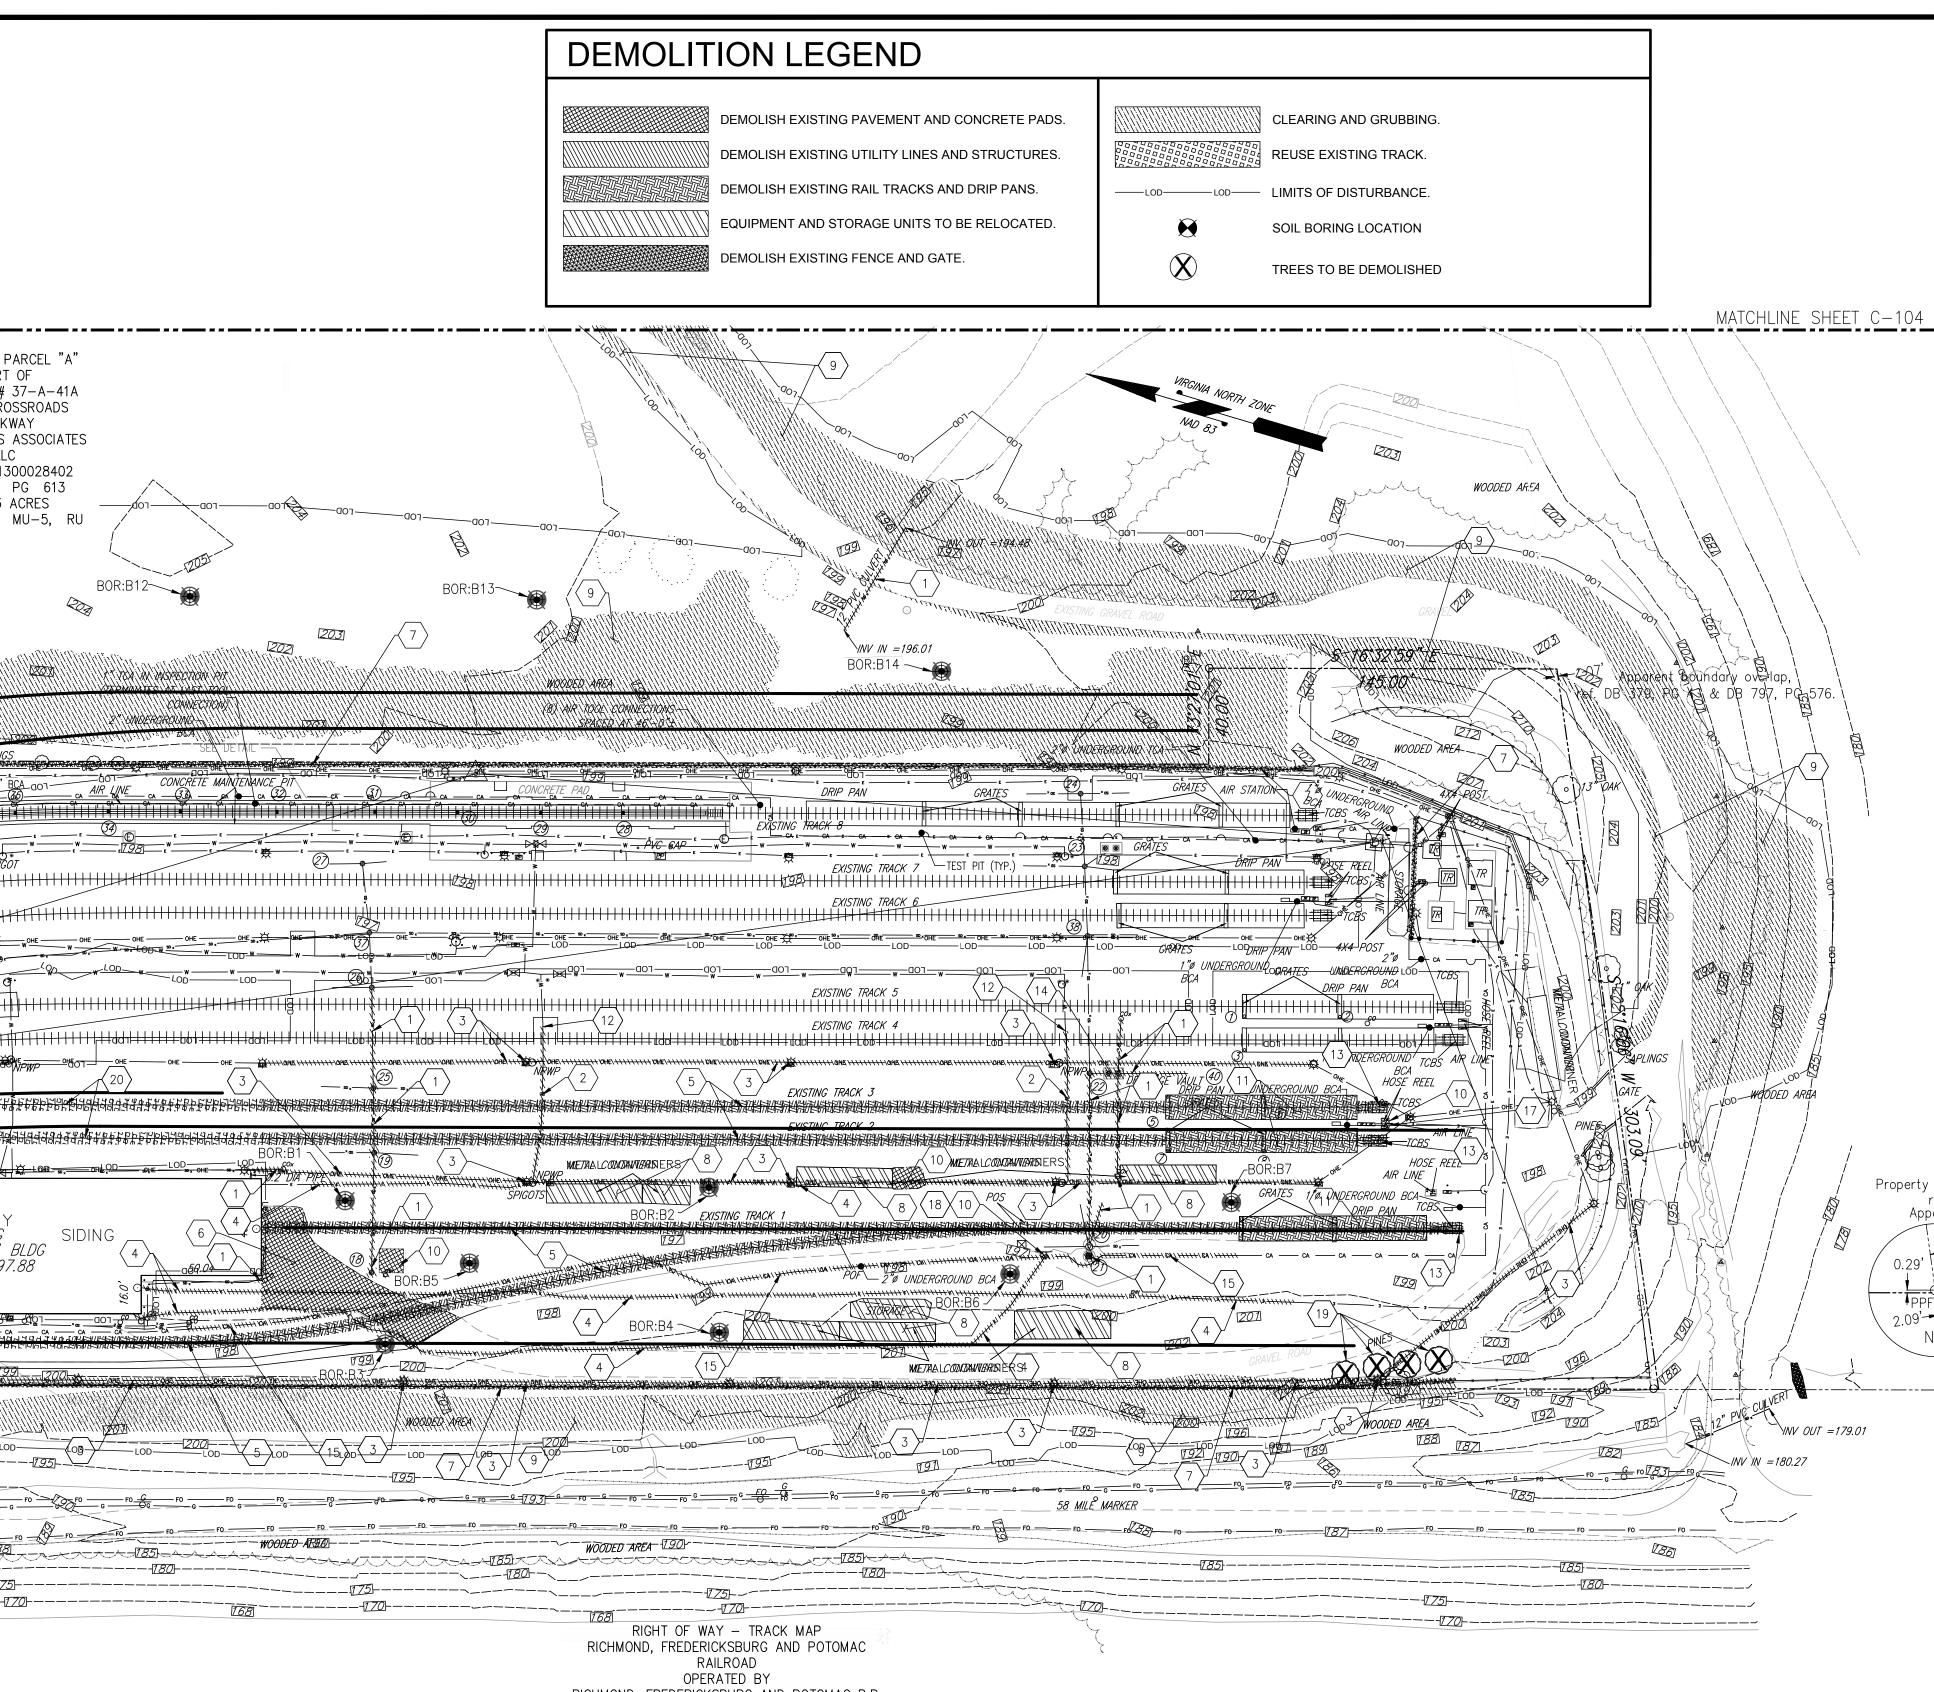


DESCRIPTION	DESIGNED BY: CK DRAWN BY: ND	05-28-2019 CHRISTOPHER DALE		STV 100	
	CHECKED BY: CK DATE: 05/25/19	CHRISTOPHER DALE KOCHER Lic.No.04799700	VRE	STV Incorporated 2701 Prosperity Avenue Suite 305 Fairfax, Virginia 22031 (571) 633-2220	


F		
	DEMOLITION NOTES	
ľ	1. THE CONTRACTOR SHALL COORDINATE WITH VRE PRIOR TO DEMOLI ITEMS THAT ARE TO BE SALVAGED TO VRE. ALL SALVAGEABLE ITEMS LOCATIONS DIRECTED BY VRE. ALL NON-SALVAGED ITEMS ARE PROP	SHALL BE DELIVERED TO THE
	<ol> <li>SHALL BE DISPOSED OFF-SITE BY THE CONTRACTOR.</li> <li>CONTRACTOR SHALL PROVIDE NECESSARY MEANS TO PROTECT THE TO THE SITE THROUGHOUT CONSTRUCTION</li> </ol>	PUBLIC AND TO PROHIBIT ACCESS
	<ol> <li>TO THE SITE THROUGHOUT CONSTRUCTION.</li> <li>THE CONTRACTOR SHALL CONTACT ALL UTILITY COMPANIES PROVID SITE TO VERIEV LITH ITIES WHICH ARE IN SERVICE AND ABANDONED.</li> </ol>	
	<ul> <li>SITE, TO VERIFY UTILITIES WHICH ARE IN SERVICE AND ABANDONED</li> <li>ALL ITEMS LOCATED IN DEMOLITION PLAN LIMITS NOT SHOWN SHALL WITH VRE PRIOR TO DEMOLITION.</li> <li>LIDON COMPLETION OF PROJECT WORK, THE CONTRACTOR SHALL PLAN</li> </ul>	BE IDENTIFIED AND COORDINATED
	<ol> <li>UPON COMPLETION OF PROJECT WORK, THE CONTRACTOR SHALL PF EQUIPMENT, TOOLS, AND MATERIALS NOT RETAINED IN ACCORDANCE REGULATIONS.</li> </ol>	
-	<ol> <li>THE CONTRACTOR SHALL CONTACT "MISS UTILITY" AT 1-800-552-7001 EXISTING UNDERGROUND UTILITIES (i.e. WATER, SEWER, GAS, TELEP AT LEAST 72 HOURS PRIOR TO ANY EXCAVATION OR CONSTRUCTION TO IDENTIFY AND PROTECT ALL OTHER UTILITY LINES FOUND IN THE OTHER OWNERS THAT ARE NOT MEMBERS OF "MISS UTILITY".</li> </ol>	HONE, ELECTRIC, AND CABLE TV) . THE CONTRACTOR IS REQUIRED
- г		
Ļ	$\langle \rangle$ SHEET KEYNOTES	
	(1) DEMOLISH AND REMOVE EXISTING STORM DRAIN LINE AND STRUC	TURES AS SHOWN.
	2 DEMOLISH AND REMOVE EXISTING WATER LINE AND APPURTENAN	CES.
	3     DEMOLISH OVERHEAD ELECTRICAL LINES AND UTILITY POLES. SEE	E ELECTRICAL PLANS FOR DETAILS.
	4 DEMOLISH UNDERGROUND ELECTRICAL LINES AND APPURTENANC	CES. SEE ELECTRICAL PLANS FOR
	<ul> <li>5 DEMOLISH AND REMOVE EXISTING RAIL TRACKS 0,1, 2 AND 3 WHER EXISTING RAIL, TIES AND SWITCHES WHERE POSSIBLE.</li> <li>6 DEMOLISH AND REMOVE EXISTING PAVEMENT.</li> </ul>	E REQUIRED. REMOVE AND REUSE
	$\sqrt{7}$ DEMOLISH AND REMOVE EXISTING FENCE AND GATE.	
	<ul> <li>VRE TO RELOCATE EXISTING STORAGE CONTAINERS AND EQUIPM ANY UNDERGROUND ELECTRICAL POWER CONNECTIONS.</li> </ul>	ENT. CONTRACTOR TO DEMOLISH
	9 CLEARING AND GRUBBING.	
	10 DEMOLISH EXISTING CONCRETE PAD.	
	11 DEMOLISH AND REMOVE EXISTING DRIP PANS.	
	$\left< 12 \right>$ PLUG AND CAP EXISTING WATER LINE.	
	$\langle 13 \rangle$ Demolish existing train car bumper stops.	
	$\langle 14 \rangle$ DEMOLISH AND REMOVE EXISTING OIL WATER SEPARATOR.	
	$\langle 15 \rangle$ EXISTING UNDERGROUND COMPRESSED AIR LINE SEGMENT.	
	$\left< 16 \right>$ NOT USED.	
	$\langle 17 \rangle$ DEMOLISH OR REUSE EXISTING WAYSIDE POWER AND COMPRESS STATIONS. $\langle 18 \rangle$ REMOVE AND RELOCATE EXISTING SPEED INDICATOR POST. SEE	
line a ref. DE	$\langle 19 \rangle$ TREES TO BE DEMOLISHED.	
arent	$\langle 20 \rangle$ REUSE EXISTING TRACK.	
L	KEY M	
	C-103 C-1	
ITS		
	C-101 C-1	02/////////////////////////////////////
		APHIC SCALE
	40'	0 40' 80
	SCALE:	1~=40
		IFB NO:
LIFE	ECYCLE OVERHAUL AND	015-012
	UPGRADE FACILITY	DRAWING NO: C-102
EX	<b>KISTING CONDITIONS &amp;</b>	SCALE: 1" = 40'

DEMOLITION PLAN 2 OF 4

SHEET NO:	4	OF	22

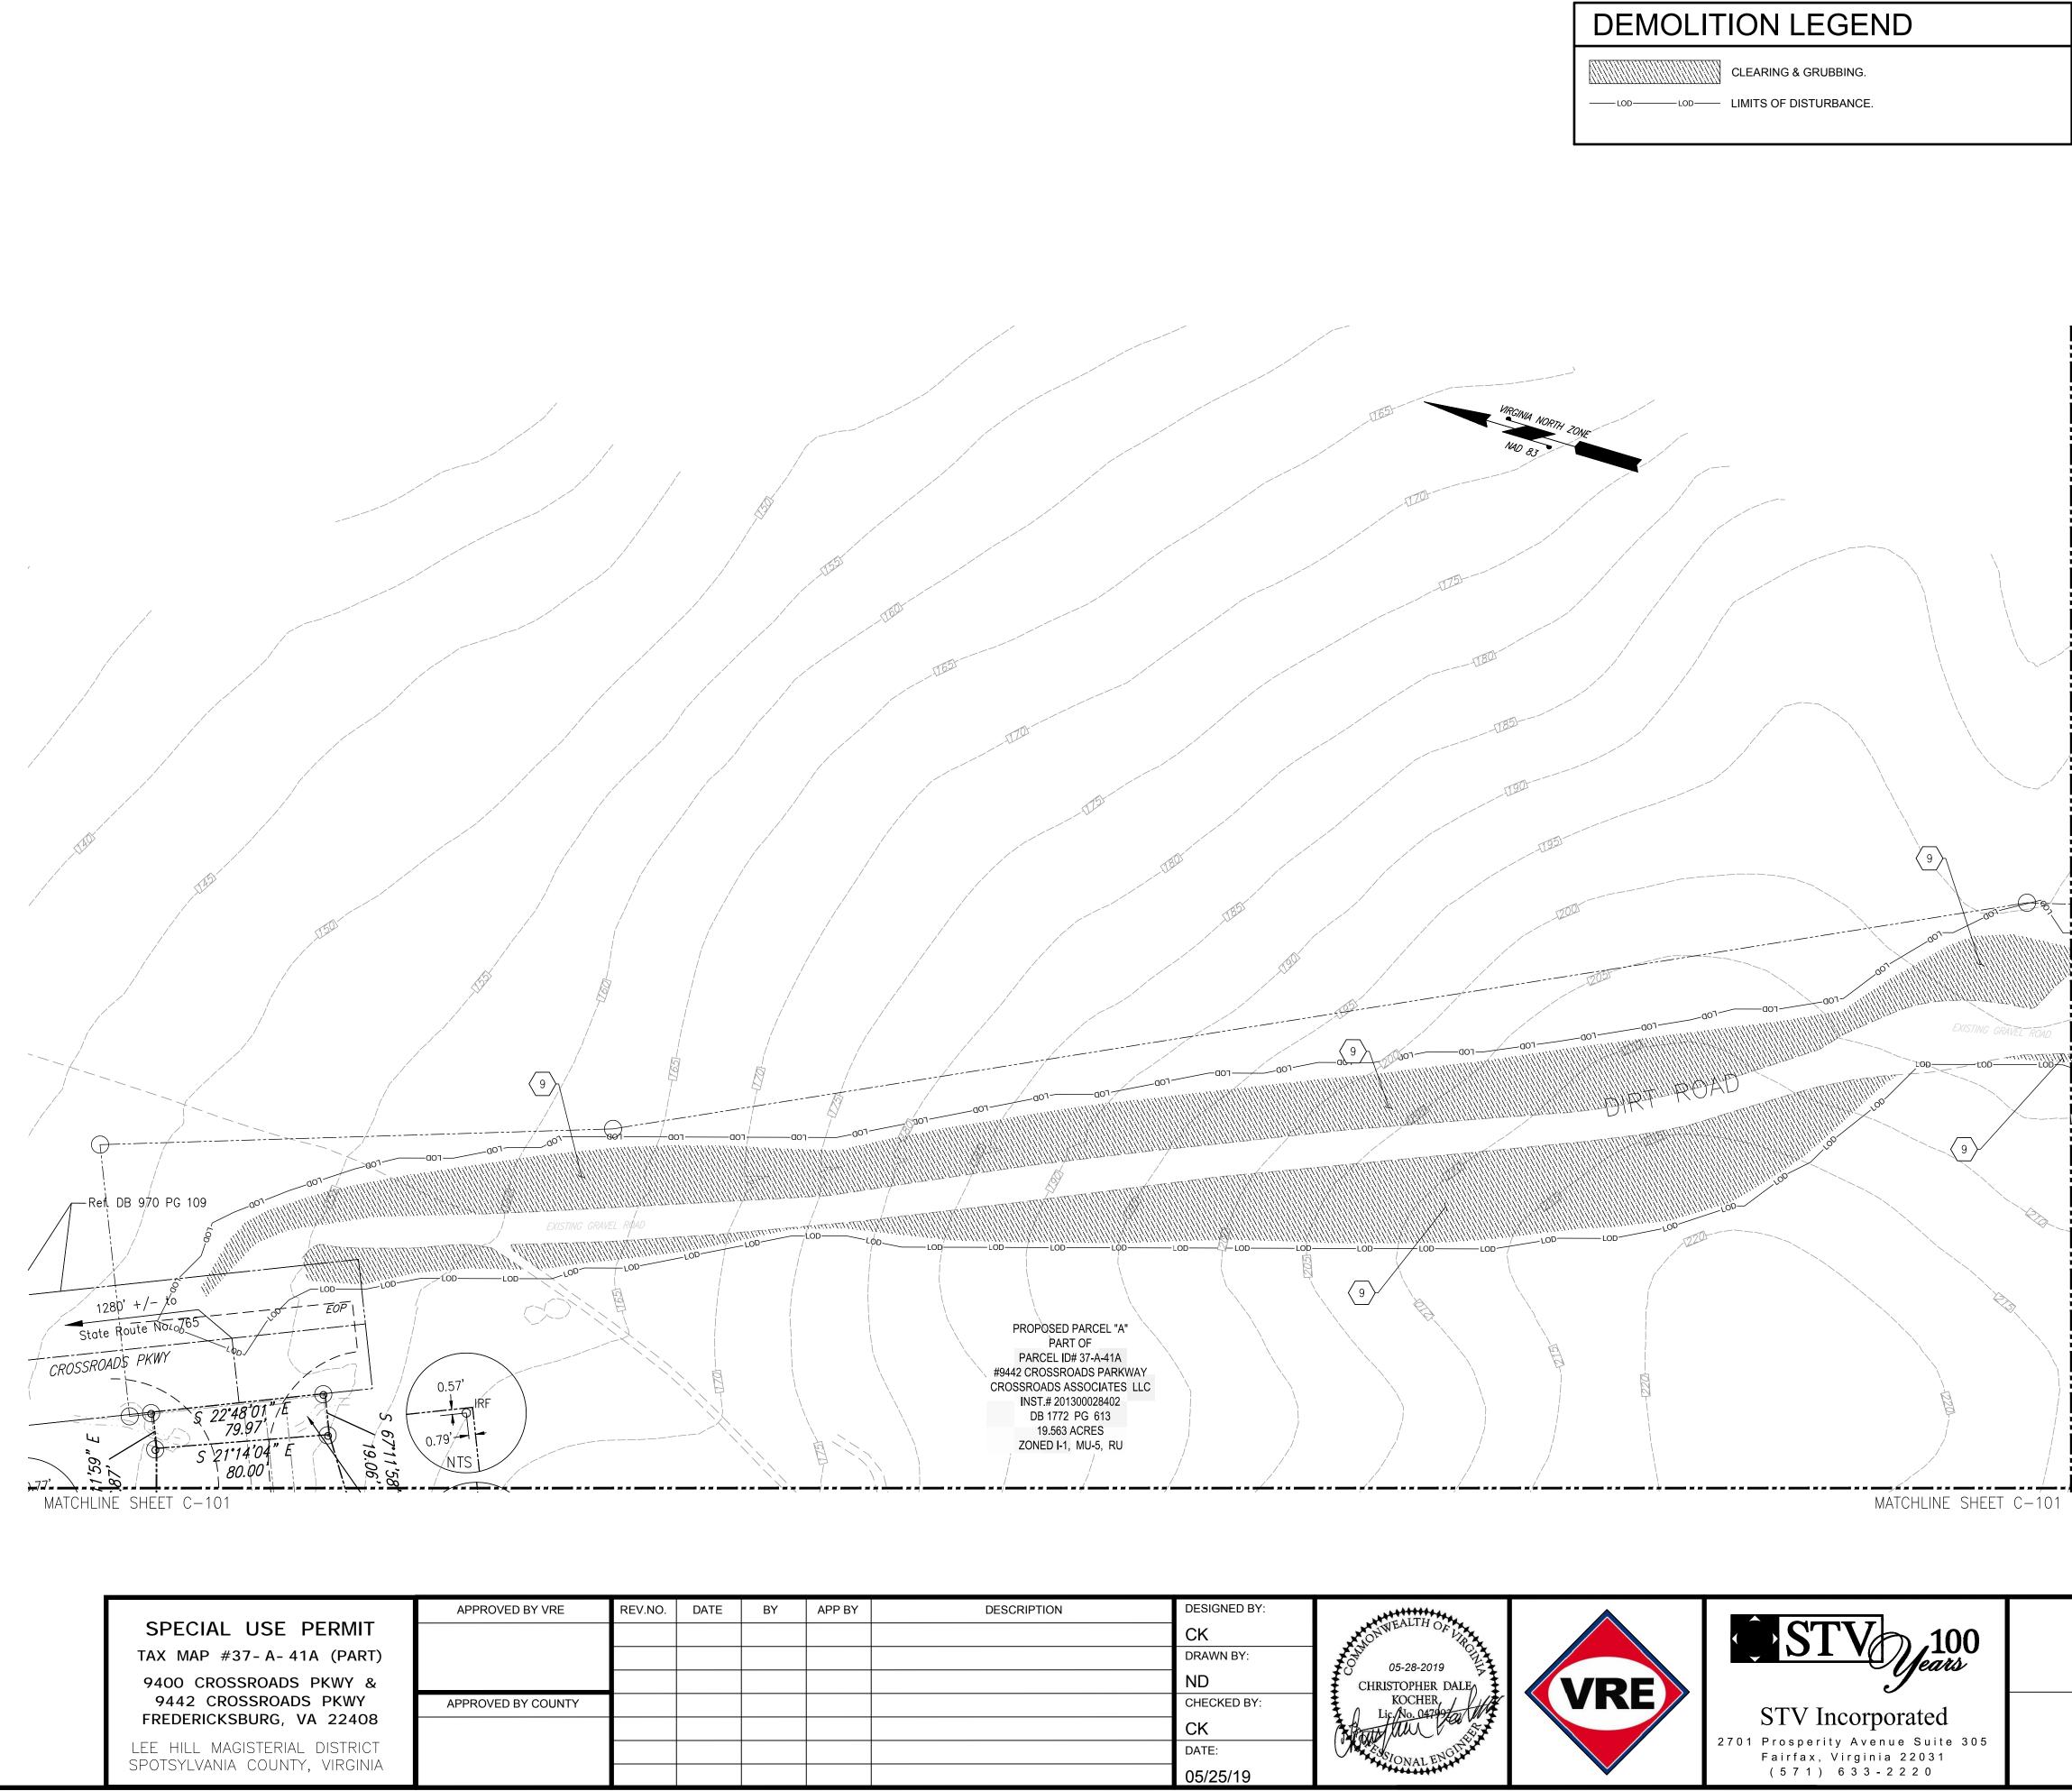

	DEMOLITION NOTES
2-104	<ol> <li>THE CONTRACTOR SHALL COORDINATE WITH VRE PRIOR TO DEMOLITION, DETERMINE DEMOLITION ITEMS THAT ARE TO BE SALVAGED TO VRE. ALL SALVAGEABLE ITEMS SHALL BE DELIVERED TO THE LOCATIONS DIRECTED BY VRE. ALL NON-SALVAGED ITEMS ARE PROPERTY OF THE CONTRACTOR AND SHALL BE DISPOSED OFF-SITE BY THE CONTRACTOR.</li> <li>CONTRACTOR SHALL PROVIDE NECESSARY MEANS TO PROTECT THE PUBLIC AND TO PROHIBIT ACCESS TO THE SITE THROUGHOUT CONSTRUCTION.</li> <li>THE CONTRACTOR SHALL CONTACT ALL UTILITY COMPANIES PROVIDING SERVICES FOR THE SUBJECT SITE, TO VERIFY UTILITIES WHICH ARE IN SERVICE AND ABANDONED BEFORE DEMOLITION.</li> <li>ALL ITEMS LOCATED IN DEMOLITION PLAN LIMITS NOT SHOWN SHALL BE IDENTIFIED AND COORDINATED WITH VRE PRIOR TO DEMOLITION.</li> <li>UPON COMPLETION OF PROJECT WORK, THE CONTRACTOR SHALL PROPERLY DISPOSE OF ALL WASTE, EQUIPMENT, TOOLS, AND MATERIALS NOT RETAINED IN ACCORDANCE WITH ALL APPLICABLE RULES AND REGULATIONS.</li> <li>THE CONTRACTOR SHALL CONTACT "MISS UTILITY" AT 1-800-552-7001 FOR MARKING THE LOCATIONS OF EXISTING UNDERGROUND UTILITIES (i.e. WATER, SEWER, GAS, TELEPHONE, ELECTRIC, AND CABLE TV) AT LEAST 72 HOURS PRIOR TO ANY EXCAVATION OR CONSTRUCTION. THE CONTRACTOR IS REQUIRED TO IDENTIFY AND PROTECT ALL OTHER UTILITY LINES FOUND IN THE WORK SITE AREA BELONGING TO OTHER OWNERS THAT ARE NOT MEMBERS OF "MISS UTILITY".</li> </ol>
C EI	
MATCHLINE SHE	1       NOT USED.         2       NOT USED.         3       NOT USED.         4       NOT USED.         5       NOT USED.         6       NOT USED.         7       NOT USED.         8       NOT USED.         9       CLEARING AND GRUBBING.         10       NOT USED.         11       NOT USED.         12       NOT USED.         13       NOT USED.         14       NOT USED.         15       NOT USED.         16       NOT USED.         17       NOT USED.         18       NOT USED.         19       NOT USED.         200       NOT USED.
	KEY MAP
MATCHLINE SHEET C-104	C-101 C-101 C-101 C-102 GRAPHIC SCALE 40' 0 40' 80' SCALE: 1"=40'
LIF	ECYCLE OVERHAUL AND UPGRADE FACILITY C-103
	XISTING CONDITIONS &       SCALE:         1" = 40'         SHEET NO:         5 OF 22

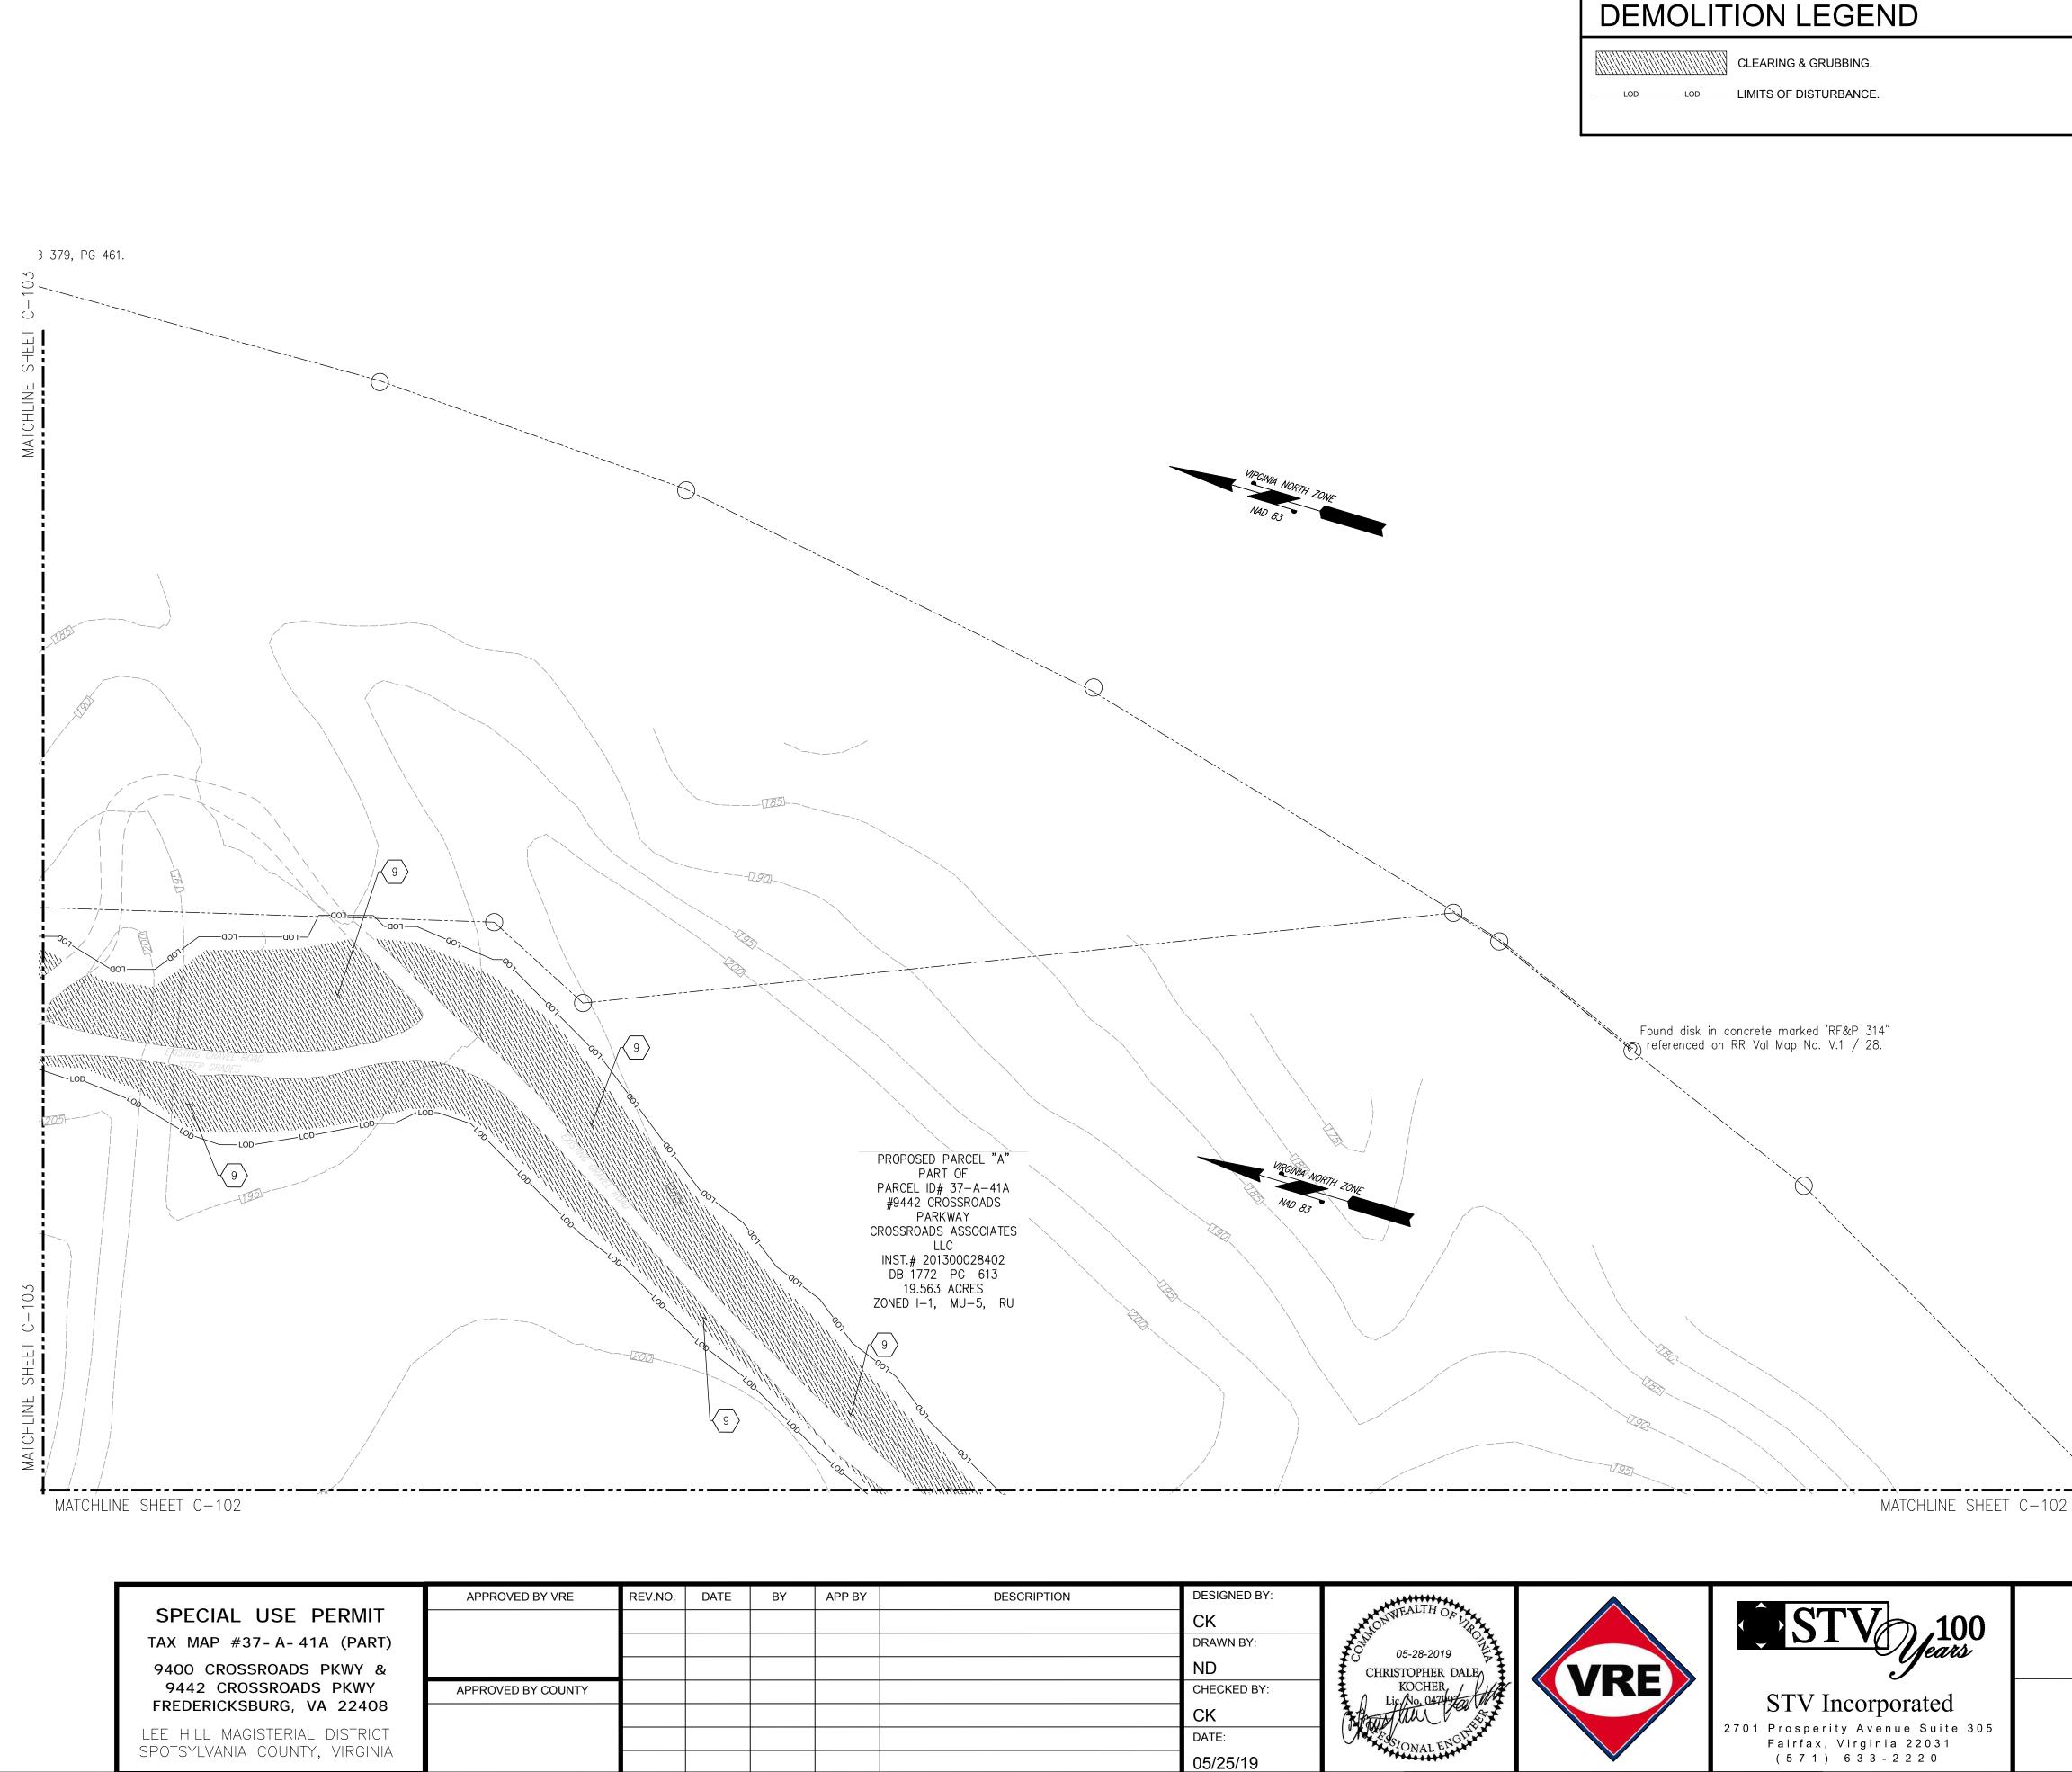

# DEMOLITION LEGEND

	TO IDENTIFY AND PROTECT ALL OTHER UTILITY LINES FOUND IN THE WORK SITE AREA BELONGING TO OTHER OWNERS THAT ARE NOT MEMBERS OF "MISS UTILITY".
	○ SHEET KEYNOTES
	1 NOT USED.
	2 NOT USED.
	$\sqrt{3}$ NOT USED.
	4 NOT USED.
	5 NOT USED.
	6 NOT USED.
	7 NOT USED.
	8 NOT USED.
	9 CLEARING AND GRUBBING.
	10 NOT USED.
	11 NOT USED.
	12 NOT USED.
	$\langle 13 \rangle$ NOT USED.
	14 NOT USED.
	15 NOT USED.
	16 NOT USED.
	17 NOT USED.
	18 NOT USED.
	19 NOT USED.
	$\langle 20 \rangle$ NOT USED.
l	KEY MAP
	C-103 C-104
	C-101 C-102
	HIMM
	GRAPHIC SCALE
	40' 0 40'
<b>`</b> .	SCALE: 1"=40'
	IFB NO:
F	ECYCLE OVERHAUL AND 015-012
-	UPGRADE FACILITY DRAWING NO: C-104
	SCALE:
E	XISTING CONDITIONS &       1" = 40'         EMOLITION PLAN 4 OF 4       SHEET NO:         6 OF 22

# **DEMOLITION NOTES**

TO THE SITE THROUGHOUT CONSTRUCTION.

WITH VRE PRIOR TO DEMOLITION.

REGULATIONS.

THE CONTRACTOR SHALL COORDINATE WITH VRE PRIOR TO DEMOLITION, DETERMINE DEMOLITION ITEMS THAT ARE TO BE SALVAGED TO VRE. ALL SALVAGEABLE ITEMS SHALL BE DELIVERED TO THE LOCATIONS DIRECTED BY VRE. ALL NON-SALVAGED ITEMS ARE PROPERTY OF THE CONTRACTOR AND SHALL BE DISPOSED OFF-SITE BY THE CONTRACTOR.

CONTRACTOR SHALL PROVIDE NECESSARY MEANS TO PROTECT THE PUBLIC AND TO PROHIBIT ACCESS


THE CONTRACTOR SHALL CONTACT ALL UTILITY COMPANIES PROVIDING SERVICES FOR THE SUBJECT

ALL ITEMS LOCATED IN DEMOLITION PLAN LIMITS NOT SHOWN SHALL BE IDENTIFIED AND COORDINATED

UPON COMPLETION OF PROJECT WORK, THE CONTRACTOR SHALL PROPERLY DISPOSE OF ALL WASTE, EQUIPMENT, TOOLS, AND MATERIALS NOT RETAINED IN ACCORDANCE WITH ALL APPLICABLE RULES AND

THE CONTRACTOR SHALL CONTACT "MISS UTILITY" AT 1-800-552-7001 FOR MARKING THE LOCATIONS OF EXISTING UNDERGROUND UTILITIES (i.e. WATER, SEWER, GAS, TELEPHONE, ELECTRIC, AND CABLE TV)


SITE, TO VERIFY UTILITIES WHICH ARE IN SERVICE AND ABANDONED BEFORE DEMOLITION.

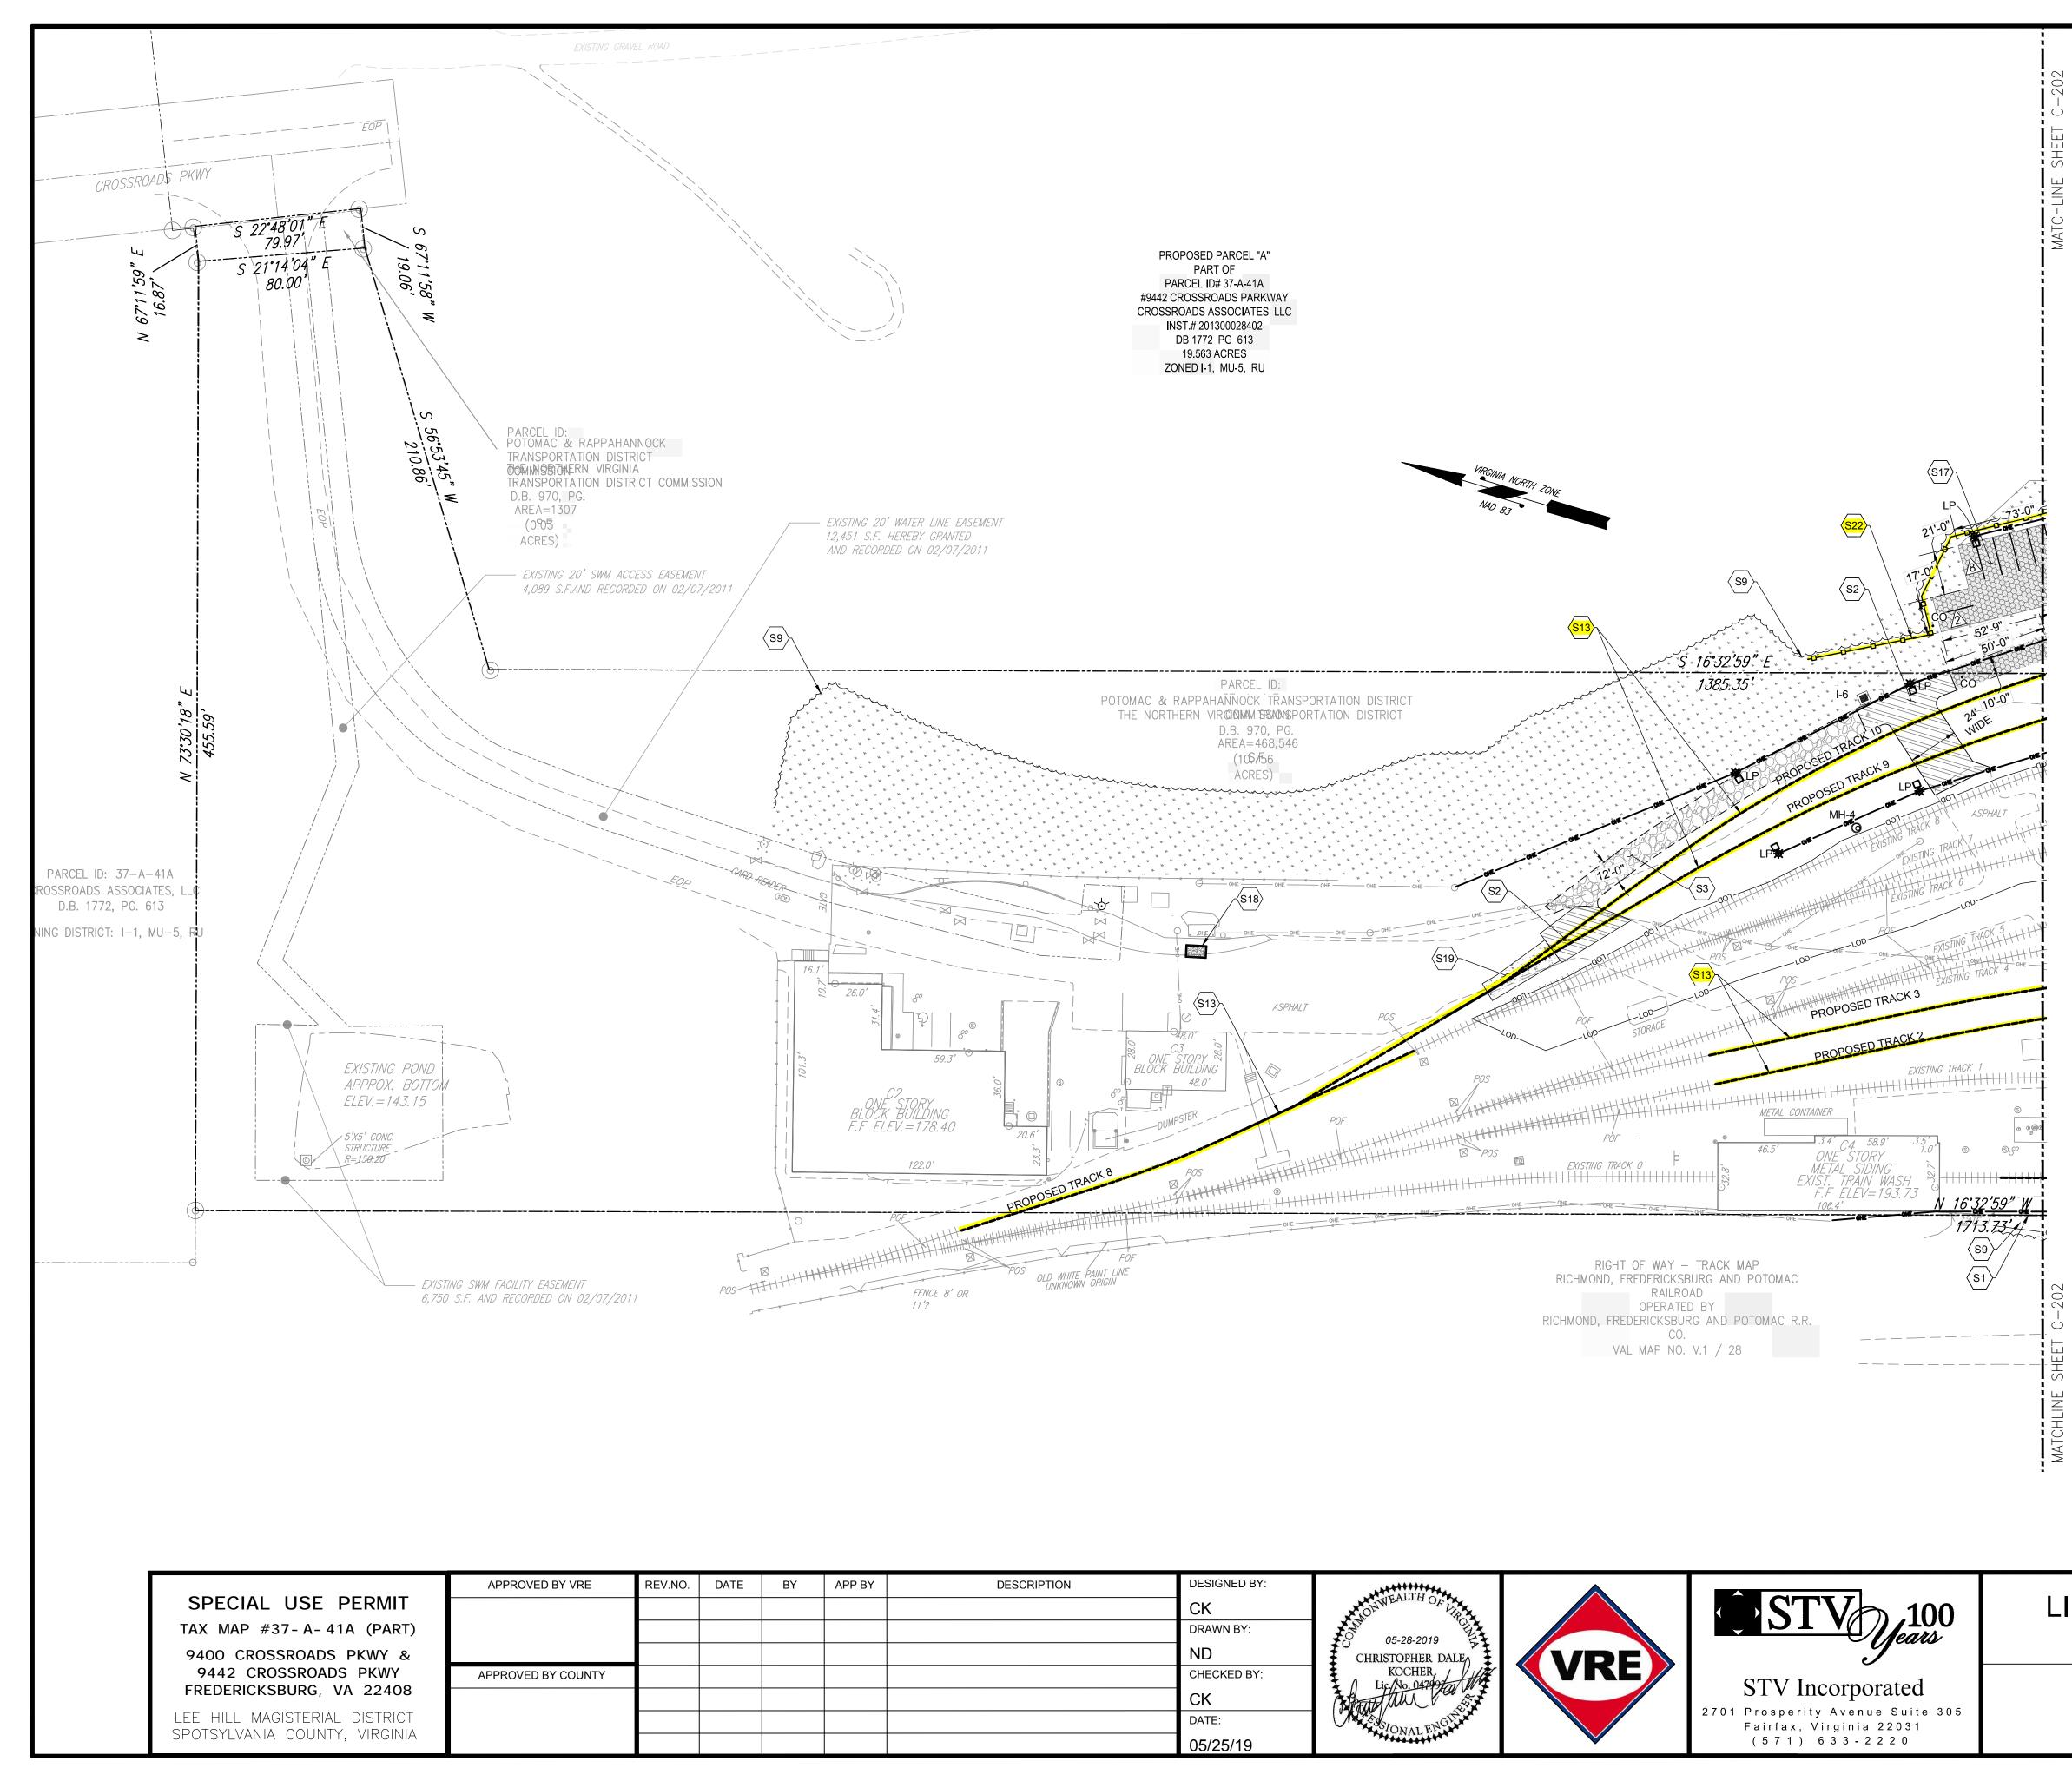


	$\rangle$ SHEET KEYNOTES
$\langle S1 \rangle$	PROPOSED CHAIN LINK FENCE.
$\langle S2 \rangle$	PROPOSED ASPHALT PAVEMENT/ AT GRADE CROSSING.
$\langle S3 \rangle$	PROPOSED GRAVEL ACCESS ROAD.
$\langle S4 \rangle$	NOT USED.
<b>S5</b>	NOT USED.
$\langle S6 \rangle$	NOT USED.
<b>S7</b>	NOT USED.
$\langle S8 \rangle$	NOT USED.
$\langle S9 \rangle$	PROPOSED TREE LINE.
S10	NOT USED.
(S11)	NOT USED.
S12	NOT USED.
<mark>S13</mark>	CENTER LINE OF PROPOSED RAIL TRACKS, SEE TRACK PLANS FOR DETAILS.
S14	NOT USED.
S15	NOT USED.
S16	NOT USED.
(S17)	PROPOSED PERMEABLE PAVEMENT FOR PARKING LOT.
\ /	PROPOSED DOUBLE CHECK VALVE ASSEMBLY VAULT. SEE DETAIL 7 ON SHEET C-705.
	PROPOSED CONCRETE PANEL AT GRADE SURFACE, FOR DETAIL SEE TRACKS PLANS.
<b>S20</b>	NOT USED.
(S21)	NOT USED.
<mark>(S22</mark> )	PROPOSED TIMBER SOUND BARRIER FENCE. SEE DETAIL 6 ON SHEET C-705.

# SITE PLAN LEGEND


	PROPOSED ASPHALT PAVEMENT
<sup>4</sup> <sup>4</sup> <sup>4</sup> <sup>4</sup> <sup>4</sup> <sup>4</sup> <sup>4</sup> <sup>4</sup> <sup>4</sup> <sup>4</sup> <sup>4</sup> <sup>4</sup> <sup>4</sup> <sup>4</sup> <sup>4</sup> <sup>4</sup>	PROPOSED GREEN SPACE
	PROPOSED PERMEABLE PAVEMENT
	PROPOSED CONCRETE PAVEMENT
	PROPOSED GRAVEL ACCESS ROAD
LODLOD	LIMIT OF DISTURBANCE.
- <u>ooo</u> o	PROPOSED TIMBER SOUND BARRIER FENCE.
•CO	PROPOSED STORM DRAIN CLEANOUT.
●S/CO-1	PROPOSED SANITARY CLEANOUT.
<b>■</b> <sup>I-1</sup>	PROPOSED GRATE INLET
⊚ <sup>MH-1</sup>	PROPOSED STORM DRAIN MANHOLE
	NUMBER OF PROPOSED PARKING SPACES

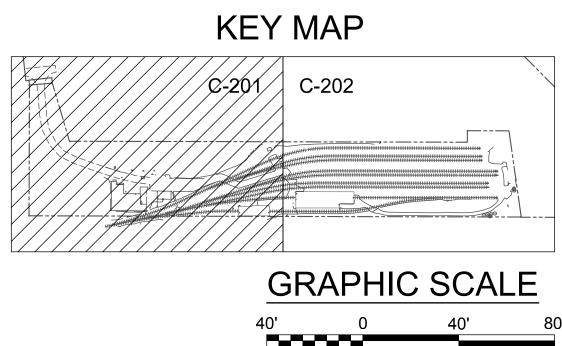

40' ■■■■■■ SCALE:	0 40' 80' 1"=40'
LIFECYCLE OVERHAUL AND UPGRADE FACILITY	IFB NO: 015-012 DRAWING NO: C-201
SITE PLAN 1 OF 2	SCALE: 1" = 40' SHEET NO: <b>7</b> OF <b>22</b>

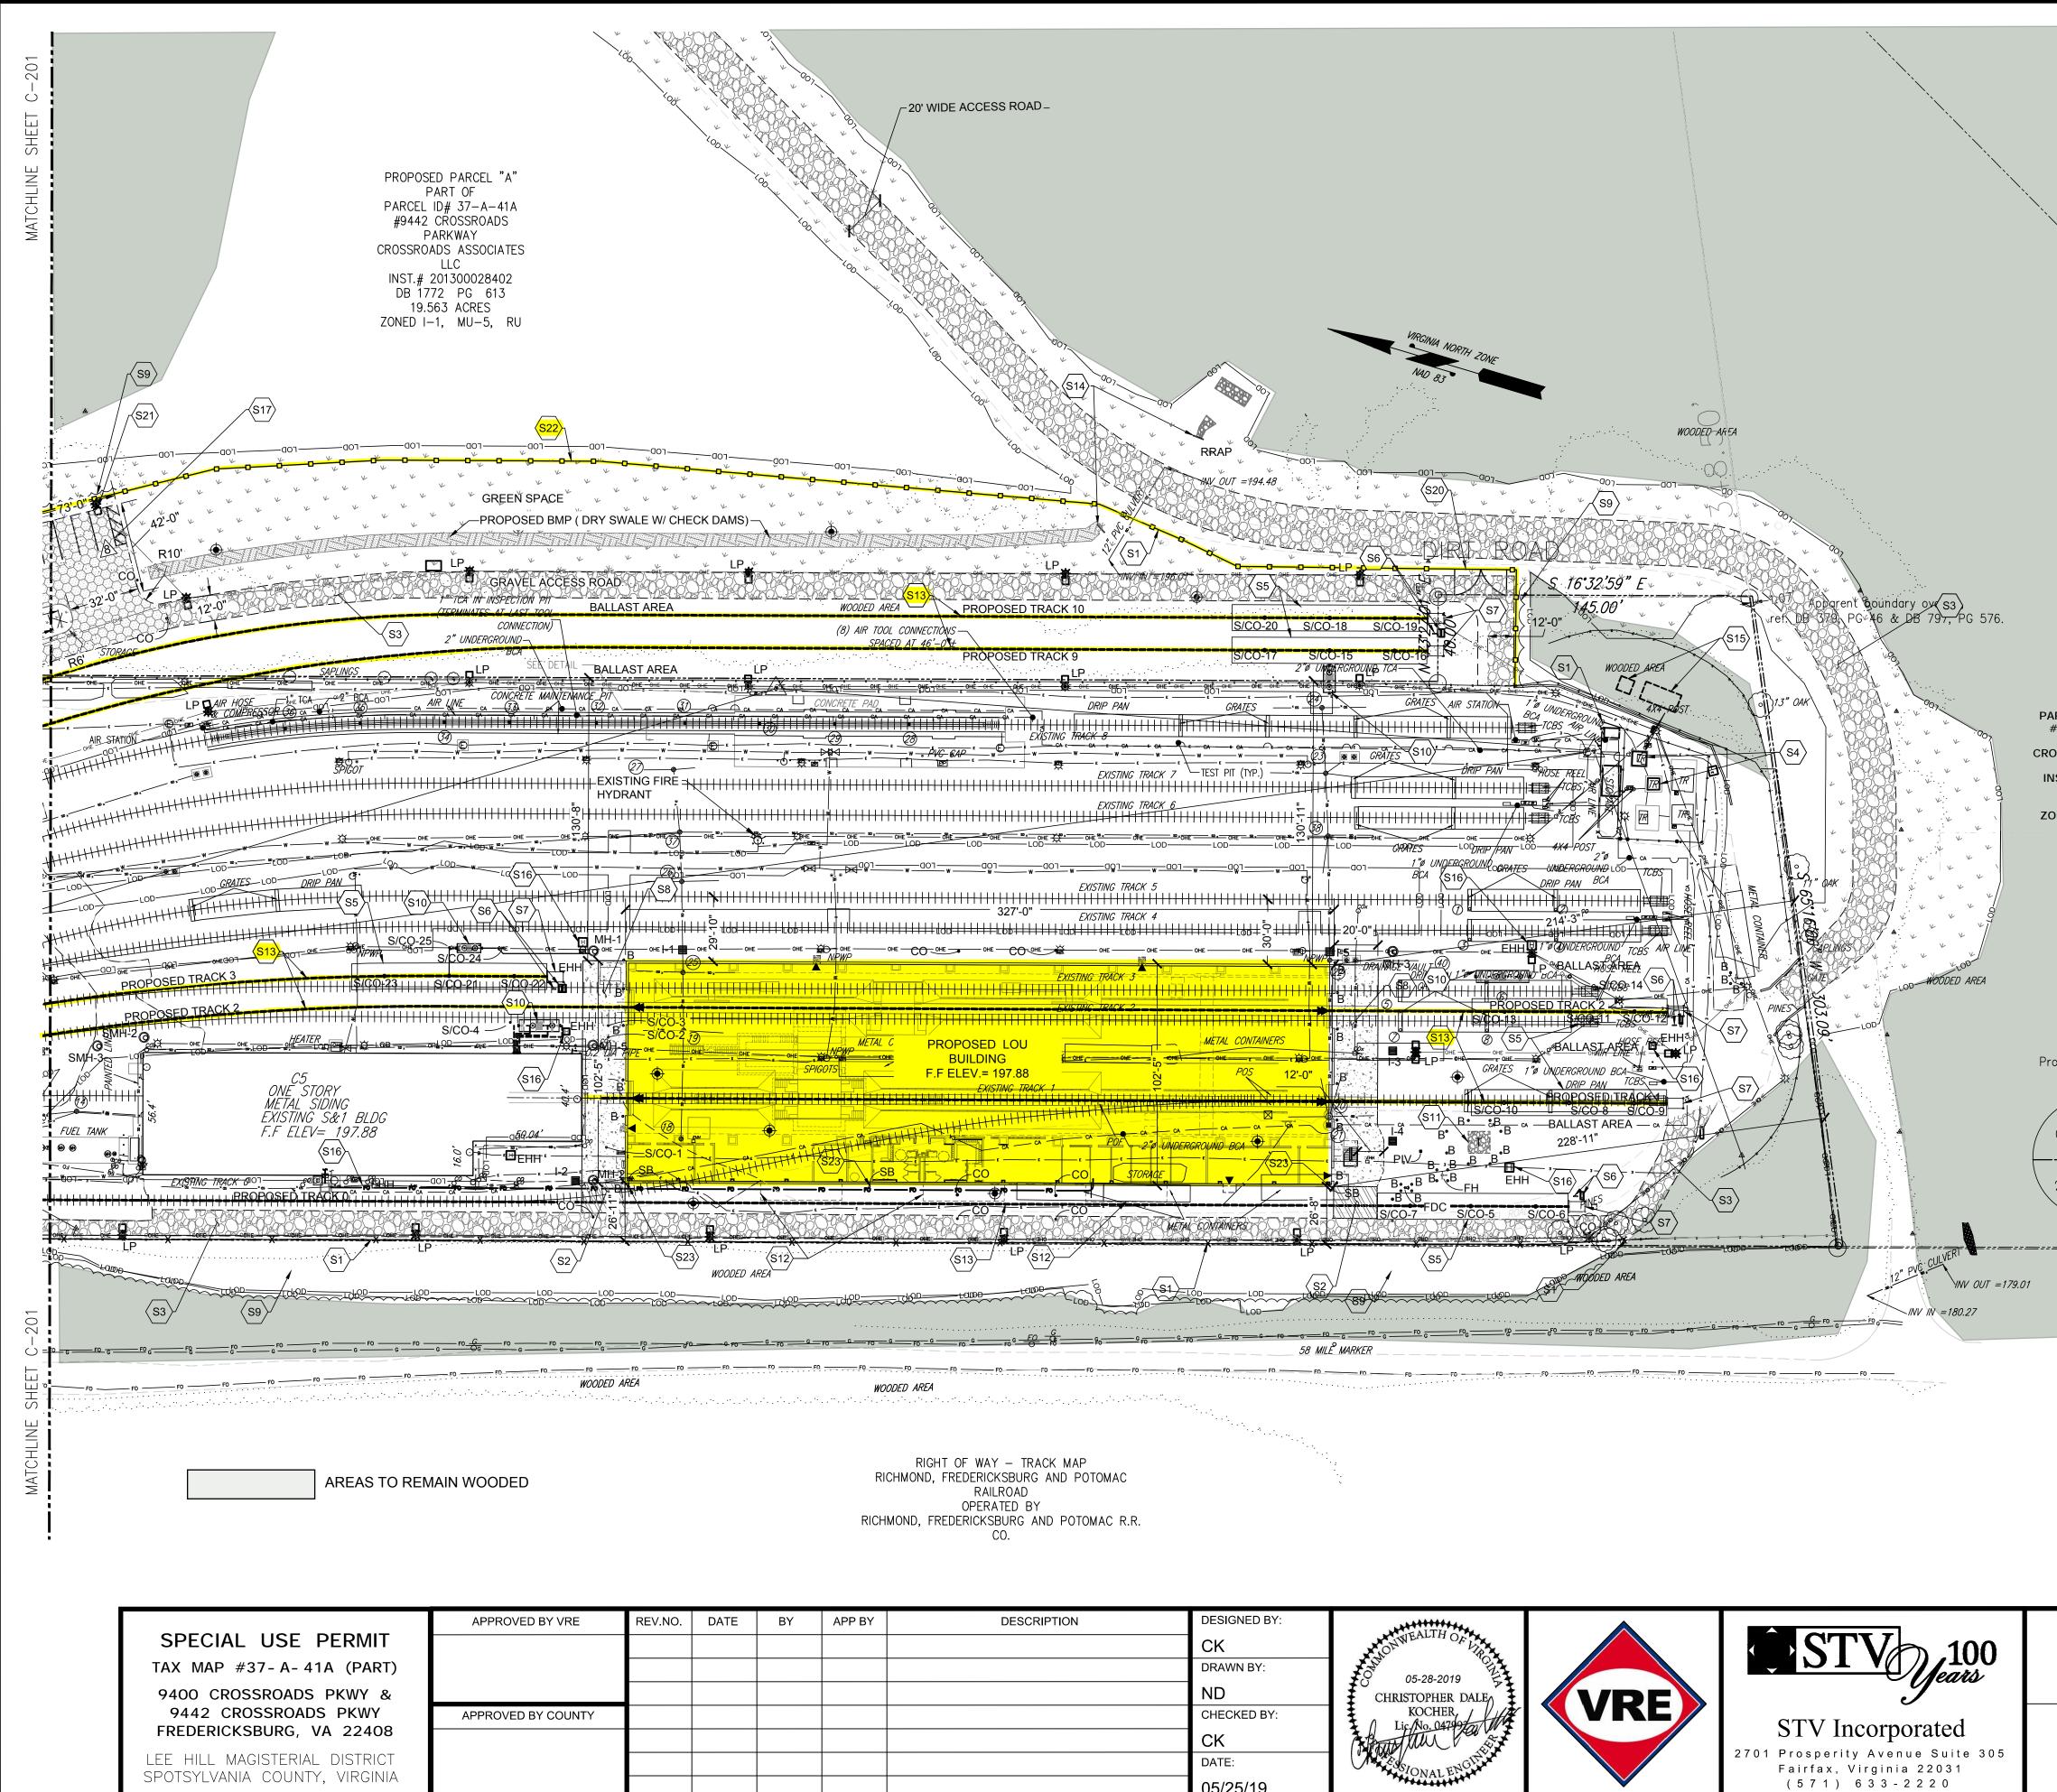


		$ \langle \rangle$ SHEET KEYNC	DTES
CESS ROAD -		S1PROPOSED CHAIN LINK FENCE. SEE DETS2PROPOSED ASPHALT PAVEMENT AT GRAS3PROPOSED GRAVEL ACCESS ROAD.S4PROVIDE GRAVEL BASE FOR CONCRETEELECTRICAL PLANS FOR DETAILS.S5PROPOSED DRIP PAN WITH GRATE COLL	ADE CROSSING. E TRANSFORMER PAD BY REC, SEE
N V ROA		C-701 S6 PROPOSED WAYSIDE POWER AND COMP S7 PROPOSED TRAIN CAR BUMPER STOP. S8 PROPOSED CONCRETE APRON PAD. S9 PROPOSED TREE LINE. S10 PROPOSED OIL WATER SEPARATOR.	PRESSED AIR .
A SIA CON	WOODED-AFTEA	\$11       10'X10' 8" GRAVEL BASE FOR TRANSMISS         \$12       PROPOSED OVERHEAD DUNNAGE. SEE A         \$12       PROPOSED OVERHEAD DUNNAGE. SEE A         \$12       MECHANICAL PLANS FOR DETAILS.         \$13       CENTER LINE OF PROPOSED RAIL TRACK         \$14       PROPOSED FULL HEIGHT CONCRETE HE         \$15       FUTURE SWITCHGEAR LOCATIONS. NOT         \$16       PROPOSED ELECTRIC HAND HOLE. SEE	ARCHITECTURAL, STRUCTURAL AND KS. SEE TRACK PLANS FOR DETAILS. ADWALL. IN CONTRACT.
UP UP OPOSED TRACK 10	16'32'59" Ev 145.00' vref. DB 379, PG 576.	\$17       PROPOSED PERMEABLE PAVEMENT FOR         \$18       NOT USED.         \$19       NOT USED.         \$20       PROPOSED 12' WIDE CHAIN-LINK FENCE         \$21       PROPOSED SIGNAGE. SEE DETAIL 5 ON S	R PARKING LOT. GATE. SHEET C-705.
S/CO-20       S/CO-18       S/CO-19       12-         OPOSED TRACK 9       S/CO-17       S/CO-15       S/CO-16       12-         UP       2 % UNCARGROUND TCA       2 % UNCARGROUND TCA       12-         OFF	S1 WOODED AREA DERGROUND S1 WOODED AREA ODERGROUND S1 OAK ODERGROUND S1 OAK ODERGROUND S1 OAK ODE OF S1 OAK ODE OF	PARCEL "A" PART OF PARCEL ID# 37- A- 41A #9442 CROSSROADS PARKWAY PARCEL ID# 37- A- 41A PARCEL ID# 37- A- 41	JD RAIN CLEAN OUT
	E REEL ACBS 3 TCBS WEERGROUND LOD P PAN BCA SA SA SA SA SA SA SA SA SA S	CROSSROADS ASSOCIATES LLC       INST.# 201300028402         INST.# 201300028402       INST.# 201300028402         DB 1772 PG 613       INST.# 201300028402         CROSSROADS ACRES       Image: Comparison of the comparison of t	LET RAIN MANHOLE Y SEWER MANHOLE. JT 6-INCH UNDERDRAIN RANT ARTMENT CONNECTION LES
EXISTING TRACK 3 EXISTING TRACK 3 EXISTING TRACK 3 EXISTING TRACK 3 EXISTING TRACK 2 EXISTING TRA	A 3 HHHHHHHHHHHHHHH BALLASTOSEREA HEAL	Image: Second state of the second s	R SEPARATOR HAND HOLE SSION PAD BY REC. ACCESS ROAD
	BALLAST AJER HH S BALLAST AJER HH S DRIP PAN TCB SIG SIG SIG SIG SIG SIG SIG SIG SIG SIG	Property line and pinched pince ref. DB 379, PG 461 Apparent bougdory over 0.29' PROPOSED BMP FACI PROPOSED ASPHALT PROPOSED PERMEAE LIMIT OF DISTURBANCE PROPOSED CHAIN LIN PROPOSED CHAIN LIN PROPOSED TIMBER S	PACE ILITY PAVEMENT BLE PAVEMENT CE. NK FENCE.
CO CO CO CO CO CO CO CO CO CO	$\frac{12^{n} \text{PVC}}{\text{INV} \text{INV}} = 180.27$	NTS NUMBER OF PROPOSE - SB PROPOSED CONCRET KEY N	ED PARKING SPACES TE SPLASH BLOCK
<u>F0</u> <u>F0</u> <u>F0</u> <u>F0</u> <u>C F0</u> <u>C </u>			
WAY – TRACK MAP RICKSBURG AND POTOMAC RAILROAD ERATED BY CKSBURG AND POTOMAC R.R. CO.		40'	APHIC SCALE 0 40' 80' E: 1"=40'
DESCRIPTION     DESIGNED BY:       CK     ND       05-28-2019       KOCHER	VRE STV Jears	LIFECYCLE OVERHAUL AND UPGRADE FACILITY	IFB NO: 015-012 DRAWING NO: C-202
CHECKED BY: CK DATE: 05/25/19 CK CK 05/25/19	STV Incorporated 2701 Prosperity Avenue Suite 305 Fairfax, Virginia 22031 (571) 633-2220	SITE PLAN 2 OF 2	SCALE: 1" = 40' SHEET NO: <b>8</b> OF <b>22</b>

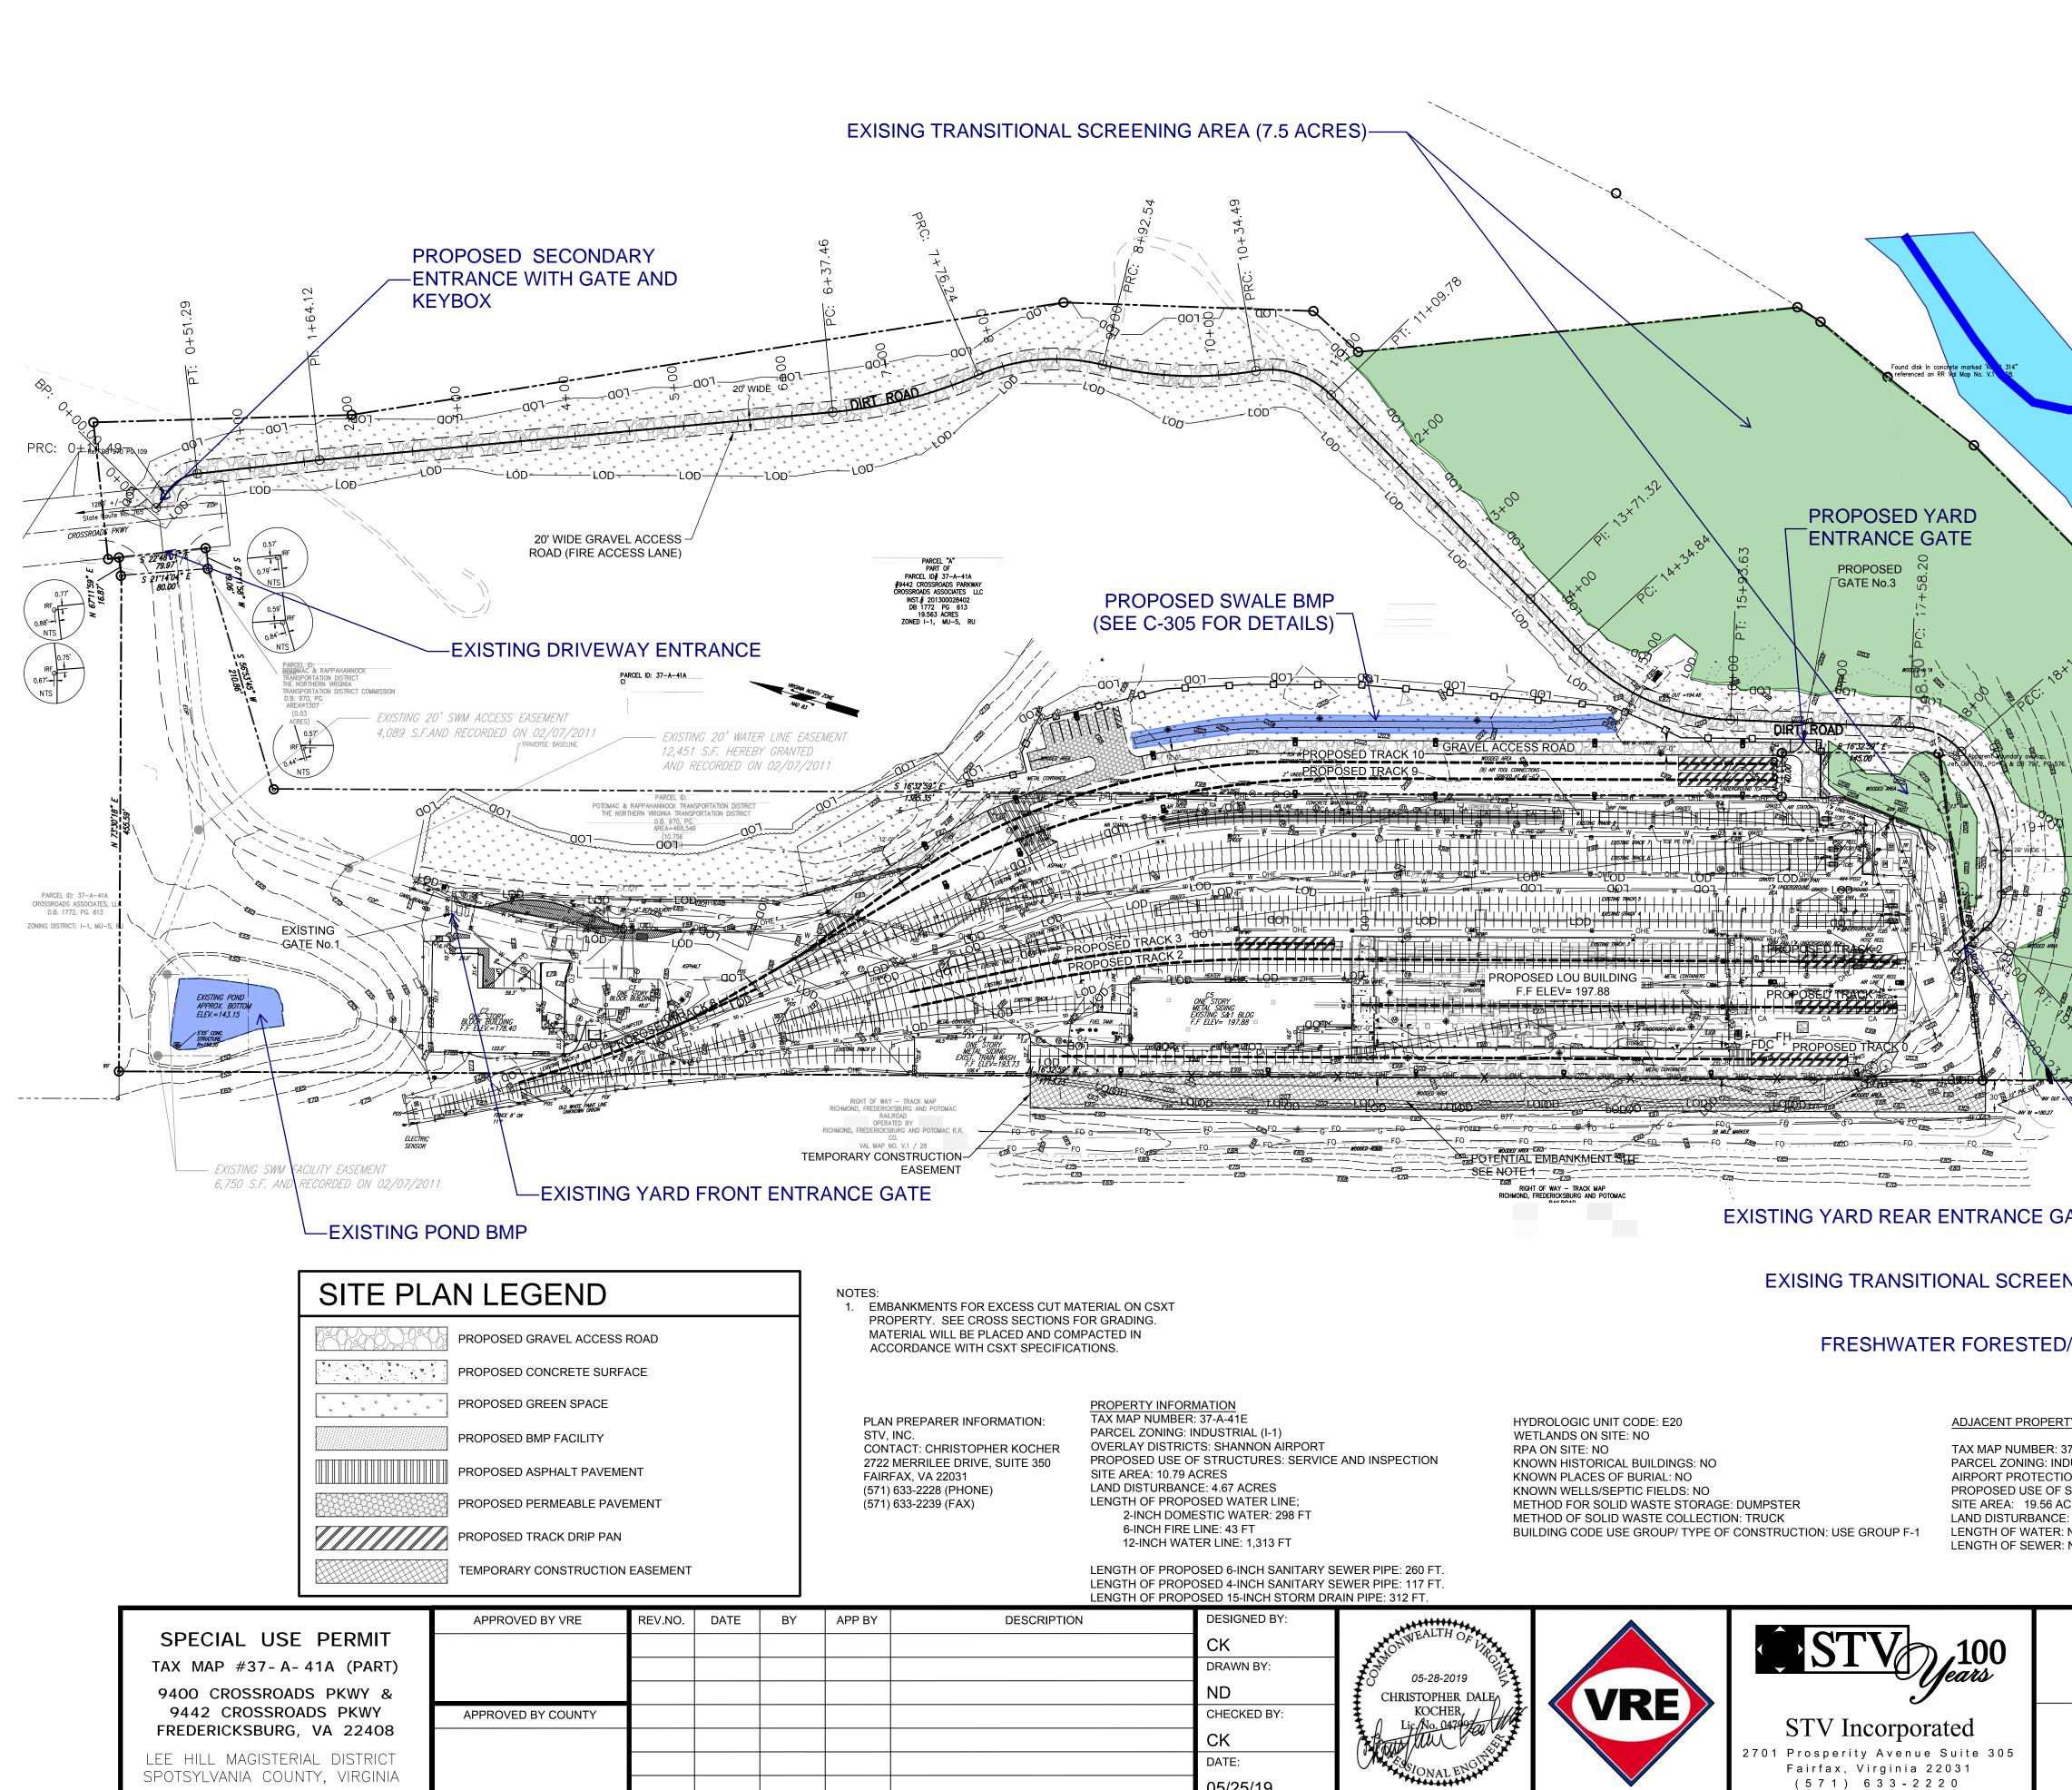



DESCRIPTION	DESIGNED BY: CK DRAWN BY: ND	O 05-28-2019 CHRISTOPHER DALE		STV 100	
	CHECKED BY: CK DATE: 05/25/19	KOCHER Lic No. 047990	VRE	STV Incorporated 2701 Prosperity Avenue Suite 305 Fairfax, Virginia 22031 (571) 633-2220	

[			]	[				7
	NON RESI	DENTIAL STRU	LOU BLDG.		VERAGE RA			_
·	NET FLOOR AREA (S	Q. FT.)	28,934	TOTAL SITE DRAI			4 SQ. FT. PROPOSED	-
	GROSS FLOOR AREA		33,252	IMPERVIOUS	86,684		121,532	-
	HEIGHT AT EAVE (FT	.)	48.00	PERVIOUS	1,070,70	05	1,115,572	
	HEIGHT AT RIDGE (F	-	55.75	RATIO (IMP:PER)			1:9.18	
	HEIGHT AT MID-ROO	F (FT.)	51.88	PERCENT INC	REASE IN IM	IPERVIOU	IS AREA: 2.82%	
								7
	PROPO	SED PARKING	TABLE	ESTIMATED P	UBLIC UTIL		GE- LOU BLDG.	_
	TYPE	NUMBER	SIZE	DAILY PUBLIC WA	ATER		115 GPD	_
	EMPLOYEE	7*	8.5'X11'	SEWAGE FLOW			115 GPD	
	HANDICAP	1 2	8.5'X11' 8.5'X11'	SI	TE COVER	AGE TAB	LE	
	* PARKING SPACES H	11		TOTAL SITE AREA			30.28 ACRE	_
	SPOTSYLVANIA COU	JNTY ZONING O	RDINANCE ARTICLE	TOTAL IMPERVIO			2.79 ACRE	_
	OUR PI POSED FA	ACILITY FALLS L	I REQUIRED SPACES. INDER WAREHOUSE	TOTAL RAILYARD	) AREA		4.78 ACRE	
	STORAGE ARD, MO PER 2 EMPLO (EE PI	LUS 1 SPACE PE	ER 5,000 SQFT OF	TOTAL GREEN SF			21.82 ACRE	_
	STORAGE ARE SE			% OF GREEN SPA	ACE		72%	
P PC:	- 19+17.75 - 19+52.42 - EXISTING ty GATE, NO.2 found, performed boundary over Apparent boundary over	be found, idp.		Spotsyl	vania C	ounty	Streams	
NING	GAREA							
D/SHI	RUB WETLAN	ID LIMITS						
37-A-41/ IDUSTRI ION OVE	ERLAY DISTRICT: SHA TURES: NONE PROPOSED)		r	80'	CALE: 1":	0 =80'	C SCAL 80'	<u>    E</u> 160'
						B NO:	015-012 NO:	
	UPC			IĬ			C-203	
	OVE	RALL	SITE PL/	AN SCALE: 1" =		1" = 80'		
					S	HEET NO	9 OF 22	2

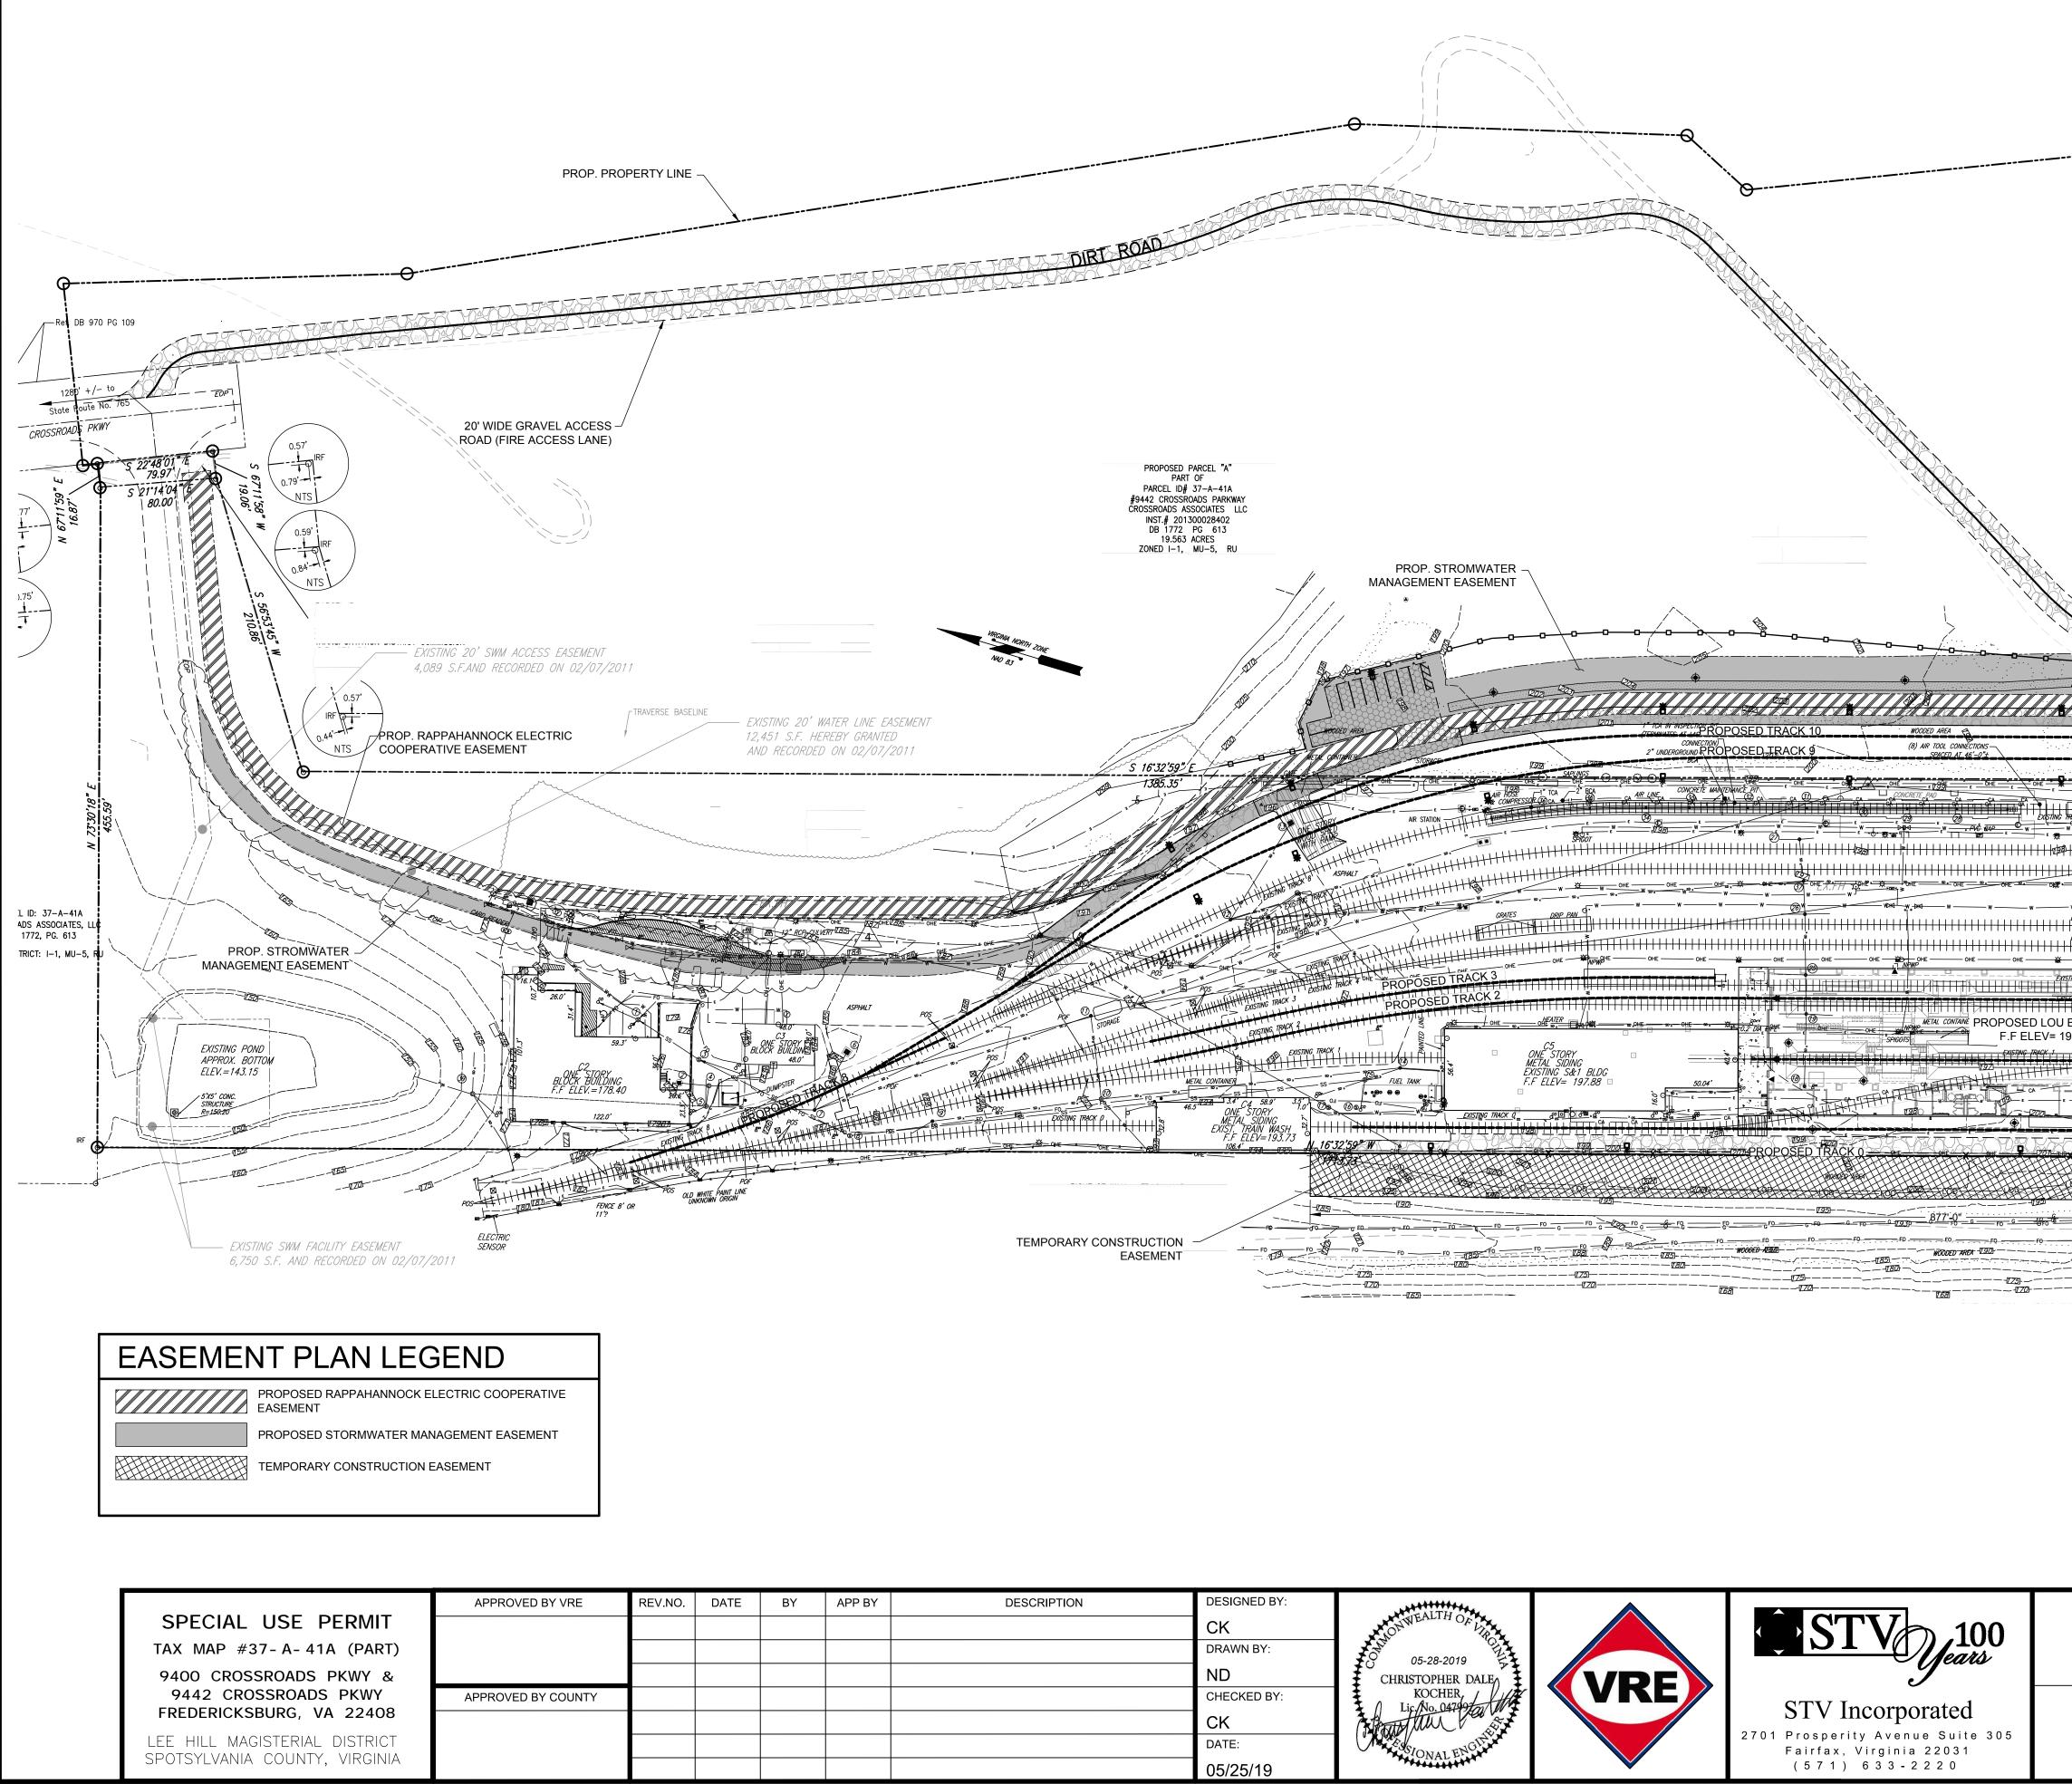

Found disk in concrete marked	N 'DE&D 314"
referenced on RR Val Map No	0. V.1 / 28.
	$\mathbf{X}$
PROP. PROPERTY LINE	
WOODED-WEA	λ
THE OUT = 194.48	
THE WAY WAY AND THE THE PARTY OF THE ROAD	
<i>L / / / / / / / / / / / / / / / / / / /</i>	arent boundary overlap, P. PG 13 & DB 797, PG 576.
2 0 UNDERGROUND TCA	
- OHE	
Mack '8'     CAR     E     CAR     E     CAR       w     w     w     w     w     w     w       t     w     w     w     w     w       t     w     w     w     w       t     w     w     w     w       t     w     w     w     w       t     w     w     w       t     w     w     w       t     w     w     w       t     w     w     w       t     w     w     w       t     w     w     w       t     w     w     w       t     w     w     w       t     w     w     w       t     w     w     w       t     w     w     w       t     w     w     w       t     w     w     w       t     w     w     w       t     w     w     w       t     w     w     w       t     w     w     w       t     w     w     w       t     w     w       t	
GRATES DRIP PAN 4X4 POST 1° UNDERGROUND GRATES UNDERGROUND CA TOO 1° UNDERGROUND GRATES UNDERGROUND	
EXISTING TRACK 5 EXISTING TRACK 4 HILLING OHE	
ISTING TRACK 3	PROP. PROPERTY
BUILDING METAL CONTAINERS	N     // LINE        // // Property line and pin
	Property line and pin ref. DB 379, Apparent bough
	NTS NTS
	30'-P" 12" PIC CUVERI WW OUT =179.01
$\frac{1}{10} \frac{1}{10} \frac$	180.27 180.27
F0	
	/ / /
	APHIC SCALE
60' SCALE:	0 60' 120'
SUALE.	1 -00
	IFB NO: 015-012
LIFECYCLE OVERHAUL AND UPGRADE FACILITY	DRAWING NO:
	C-204 SCALE:
PROPOSED EASEMENT PLAN	1" = 60'
	SHEET NO: <b>10</b> OF <b>22</b>

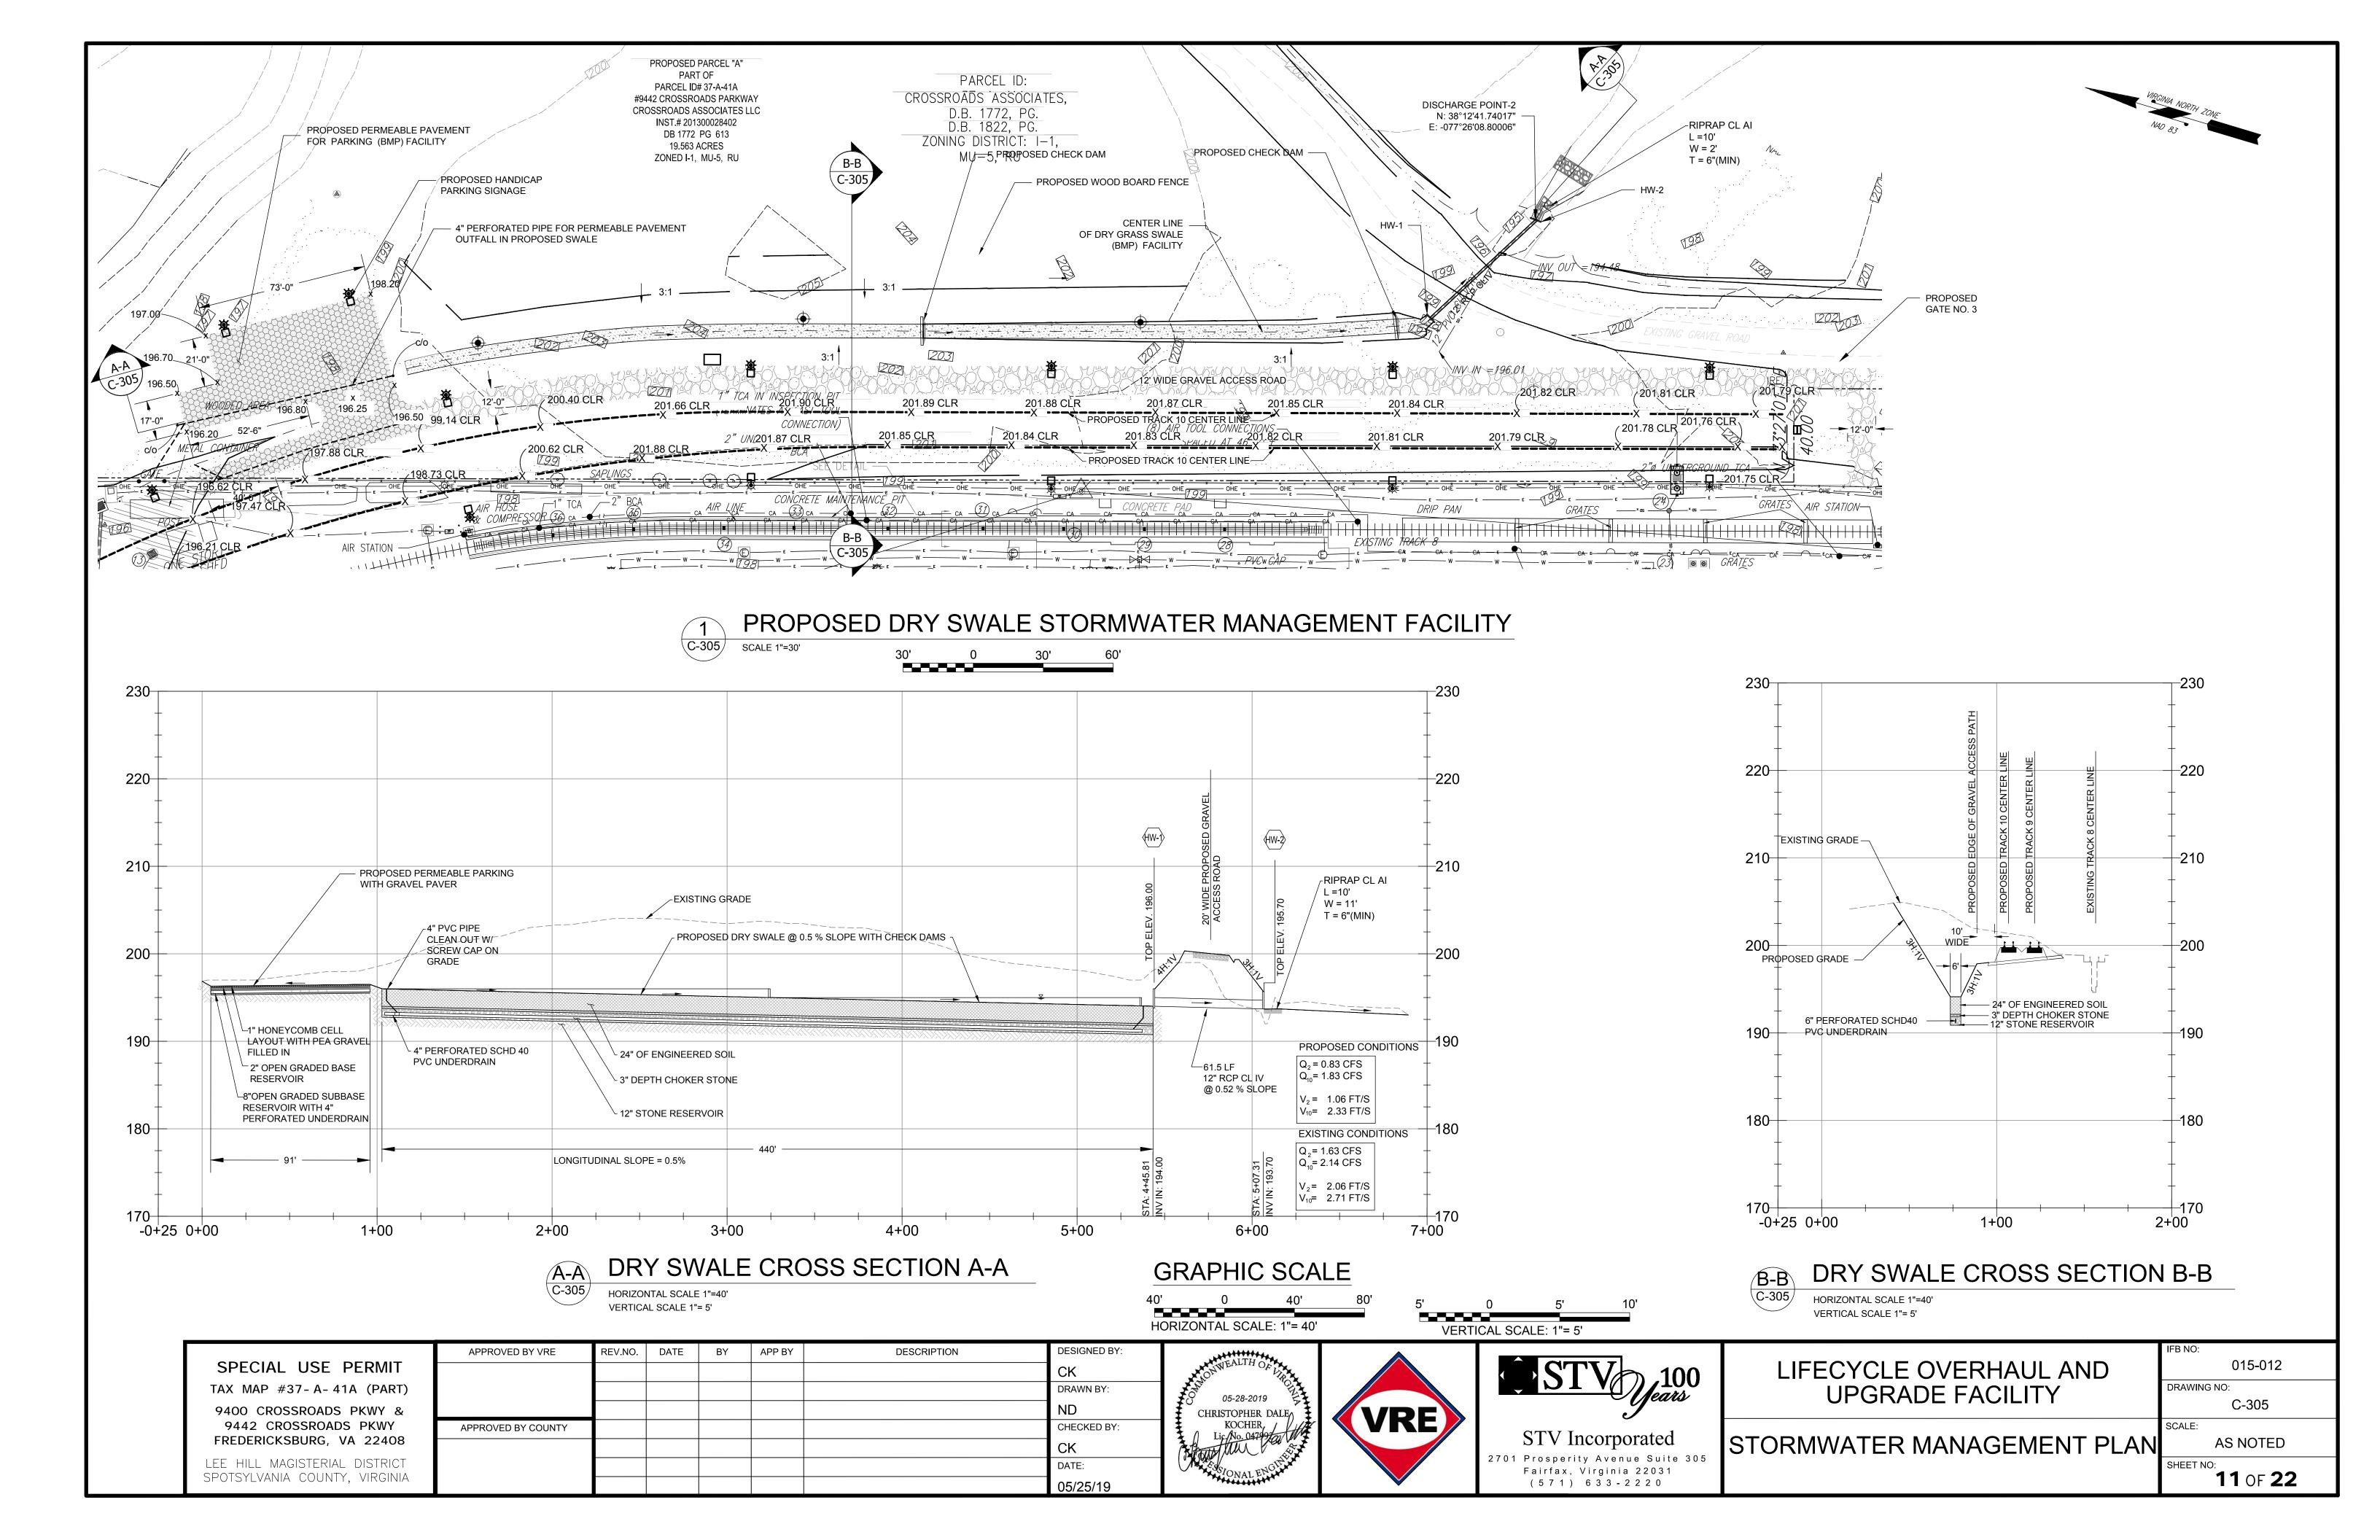

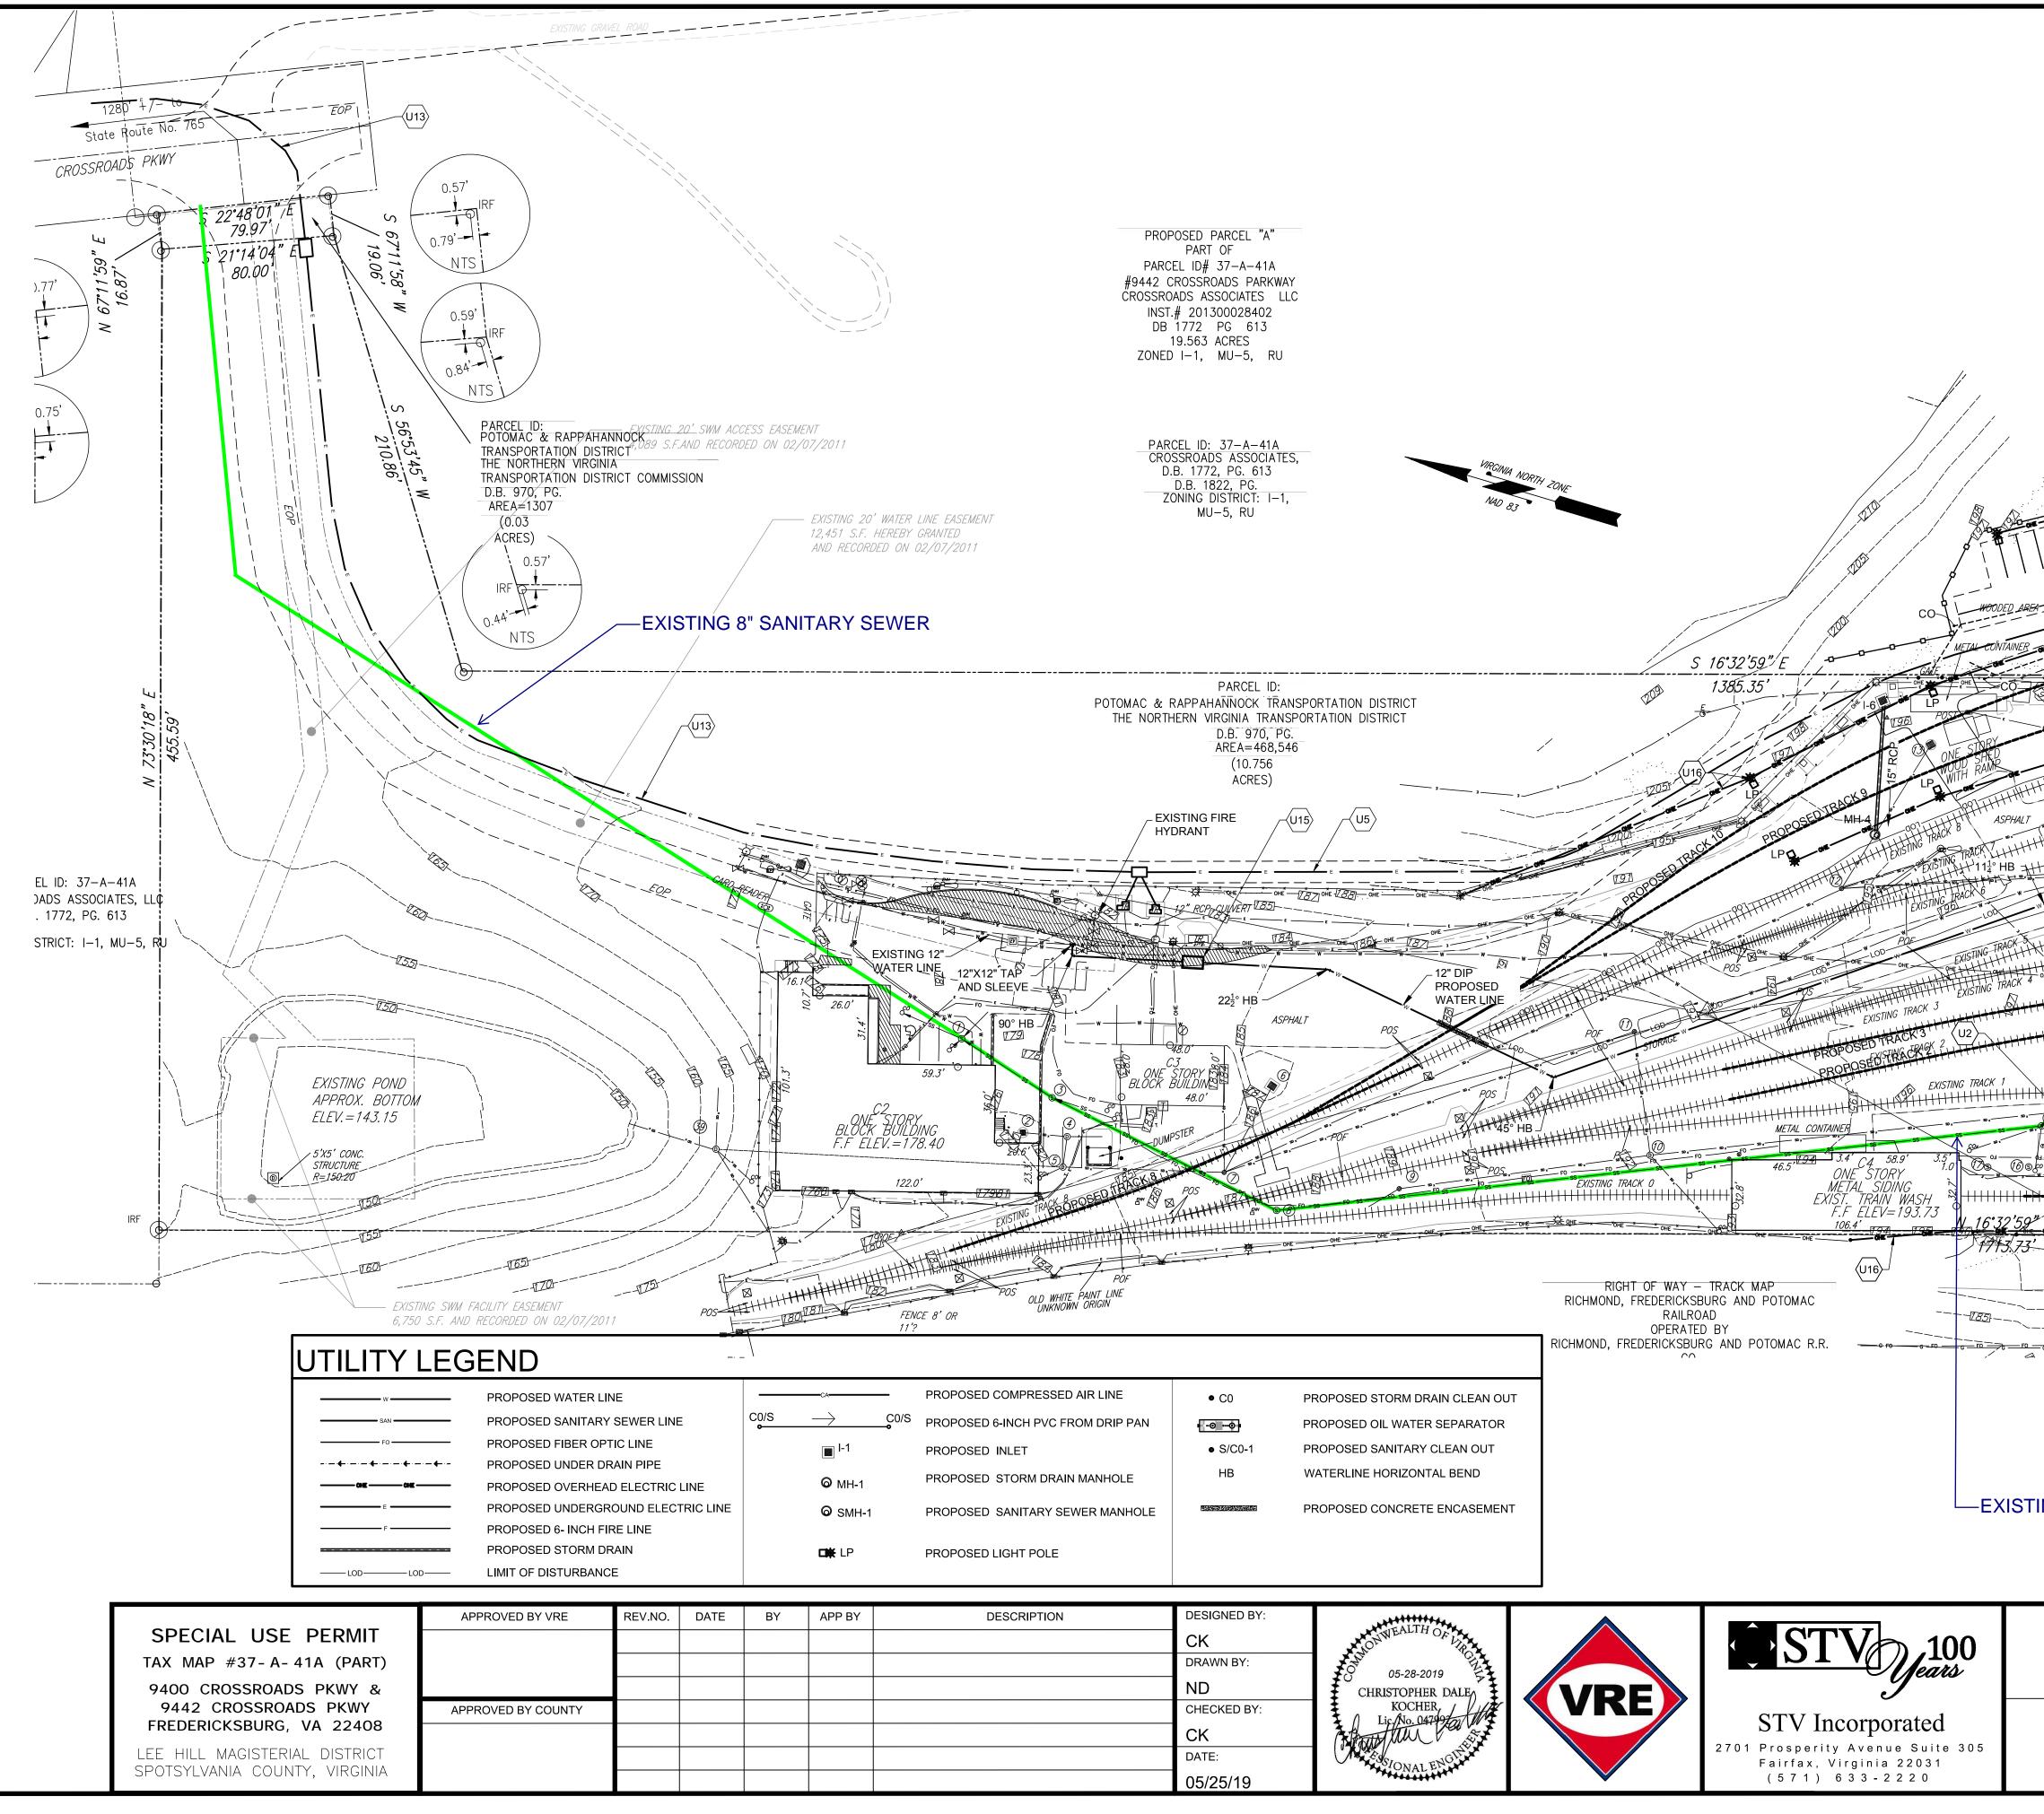

	U6       NOT USED.         U7       NOT USED.         U9       NOT USED.         U10       NOT USED.         U11       NOT USED.         U12       NOT USED.         U13       PROPOSED 35KV DIRECT BURIED CABL         U14       NOT USED.         U15       DOUBLE CHECK VALVE ASSEMBLY VAU         U16       PROPOSED ELECTRIC LIGHT POLES AL         CABLES. SEE ELECTRICAL PLANS FOR D	ONG WITH OVER HEAD ELECTRIC
PROSE	POSED 4" SANITARY SEWER	
PROSE		ЛАР
PROSE	KEY N	<b>ЛАР</b> 2-502
PROSE	KEY N	
MATCHLINE SHEET C-502	KEY N	C-502
MATCHLINE SHEET C-502	KEY N C-501 C-501 C GF 40'	2-502
	KEY N C-501 C-501 C GF 40'	C-502
NG 8" SANITARY SEWE	KEY N C-501 C C-501 C C C C C C C C C C C C C	C-502
NG 8" SANITARY SEWE	KEY K         Image: Constraint of the second seco	D-502 C-

 $\rightarrow$  SHEET KEYED NOTES


 $\langle U2 \rangle$  PROVIDE 4-INCH SCH 40 PVC SANITARY SEWER LINE.

 $\langle U1 \rangle$  NOT USED.

 $\langle U3 \rangle$  NOT USED.

 $\langle U4 \rangle$  NOT USED.

۰ th

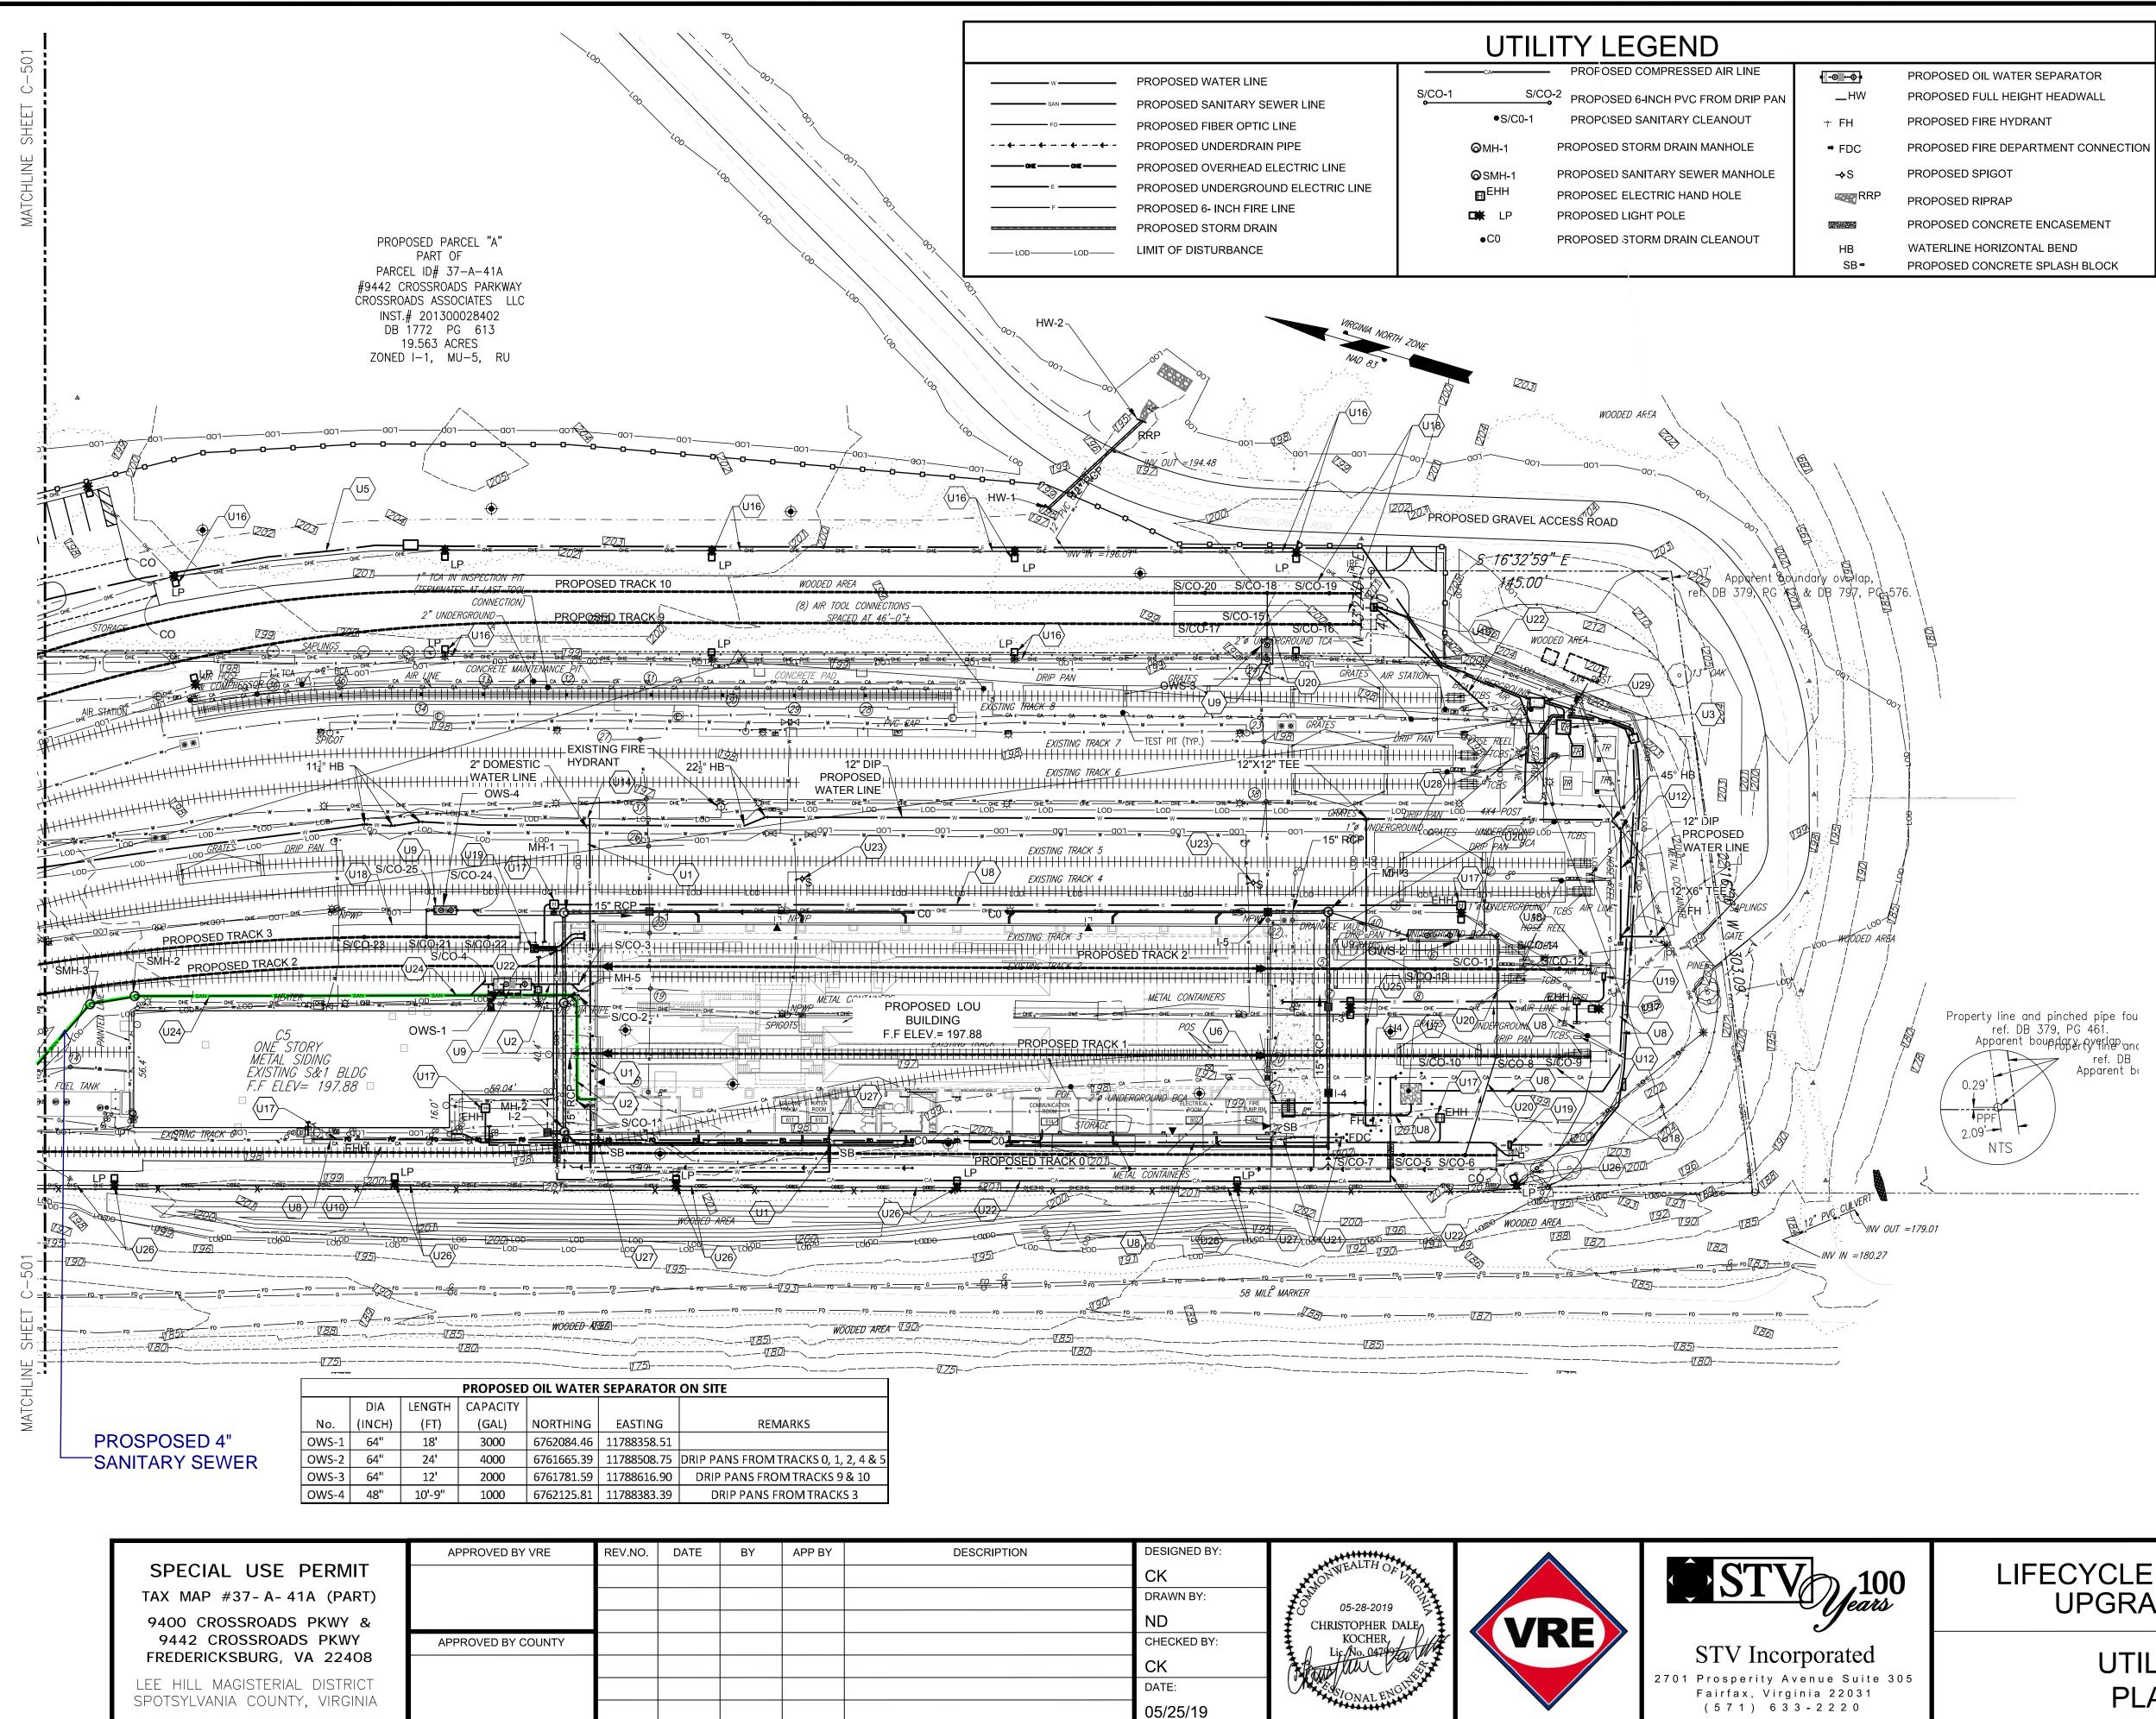


			→S PROPOSED SPIGO WRP PROPOSED RIPRA PROPOSED CONCI HB WATERLINE HORIZ	O4     PER ARTICLE 2 - FIRE REGULATION AND CONSTRUCTION REQUIREME       ETE ENCASEMENT     O4       O4     PER ARTICLE 2 - FIRE REGULATION AND CONSTRUCTION REQUIREME       O4     PER ARTICLE 2 - FIRE REGULATION AND CONSTRUCTION REQUIREME       O4     O4       O4     PER ARTICLE 2 - FIRE REGULATION AND CONSTRUCTION REQUIREME       O4     O4       O5     O4       O4     O4       O4	OUIT 30" DEEP WITH DRAG LINE FOR REC CTRICAL PLANS FOR DETAILS.
	B         B	WOODED AF54           00         007         007         007           00         PROPOSED GRAVEL ACCESS ROAD         007         007           000         PROPOSED GRAVEL ACCESS ROAD         007         007           000         PROPOSED GRAVEL ACCESS ROAD         007         007           000         PROPOSED GRAVEL ACCESS ROAD         0175         0175           000         PROPOSED GRAVEL ACCESS ROAD         0175         0175           000         PROPOSED GRAVEL ACCESS ROAD         0175         0175           000         PROPOSED ROAD         0175         0175         0175           000         PROPOSED ROAD         PROPOSED ROAD         0170         0175           000         PROPOSED ROAD         PROPOSED ROAD         PROPOSED ROAD         0170           000         PROPOSED ROAD <td>SB- PROPOSED CONCI undary overlap, &amp; DB 797, PG 576.</td> <td>e and pinched pipe fou         e and pinched pipe f</td> <td>FOR CONCRETE TRANSMISSION PAD BY EE ELECTRICAL PLAN FOR DETAILS. FOR COMMUNICATION FROM S &amp; I PRESSED AIR STATIONS TO REMAIN FOR , PROTECT, AND CONSTRUCT AROUND TING 6" WATER LINE. CONTRACTOR TO ALONG WITH OVERHEAD ELECTRIC CABLES, NLS. SEE ELECTRICAL PLANS. TION GRATE. IN STATION. LECT OIL FROM DRIP PANS. PARTMENT CONNECTION VIA 6" STAND 22. TARY SEWER LINE. ALONG WITH OVERHEAD ELECTRIC STING LIGHT POLES. SEE ELECTRICAL OCKS, SIZE 12"X 24". LECTRICAL PLANS.</td>	SB- PROPOSED CONCI undary overlap, & DB 797, PG 576.	e and pinched pipe fou         e and pinched pipe f	FOR CONCRETE TRANSMISSION PAD BY EE ELECTRICAL PLAN FOR DETAILS. FOR COMMUNICATION FROM S & I PRESSED AIR STATIONS TO REMAIN FOR , PROTECT, AND CONSTRUCT AROUND TING 6" WATER LINE. CONTRACTOR TO ALONG WITH OVERHEAD ELECTRIC CABLES, NLS. SEE ELECTRICAL PLANS. TION GRATE. IN STATION. LECT OIL FROM DRIP PANS. PARTMENT CONNECTION VIA 6" STAND 22. TARY SEWER LINE. ALONG WITH OVERHEAD ELECTRIC STING LIGHT POLES. SEE ELECTRICAL OCKS, SIZE 12"X 24". LECTRICAL PLANS.
DRAWN BY: DRAWN BY:	Image: State         Image: State<	27U8 CO-5 S/CO-6 CO CO CO CO CO CO CO CO CO CO	2.09 <sup>°</sup> NT 12 <sup>°</sup> PVC CULVER <sup>T</sup> WV OUT =179.01 INV IN =180.27	F         Γ <t< th=""><th>C-502         J</th></t<>	C-502         J
	DRAWN BY: 05-28-2019				DRAWING NO:
CK STV Incorporated UTILITY PLAN 1" = 40'	CHECKED BY: KOCHER, / Lic,/No. 047997		rporated	UTILITY PI AN	SCALE:
DATE: 05/25/19 05/2	DATE:	Fairfax, Virg	inia 22031		


 $\rightarrow$  SHEET KEYED NOTES


 $\langle U3 \rangle$  PROVIDE GRAVEL BASE FOR CONCRETE TRANDFORMER PAD BY REC.

 $\langle U1 \rangle$  provide 2-inch copper water line for domestic use.

 $\langle U2 \rangle$  PROVIDE 4-INCH SCH.40 PVC SANITARY SEWER LINE.

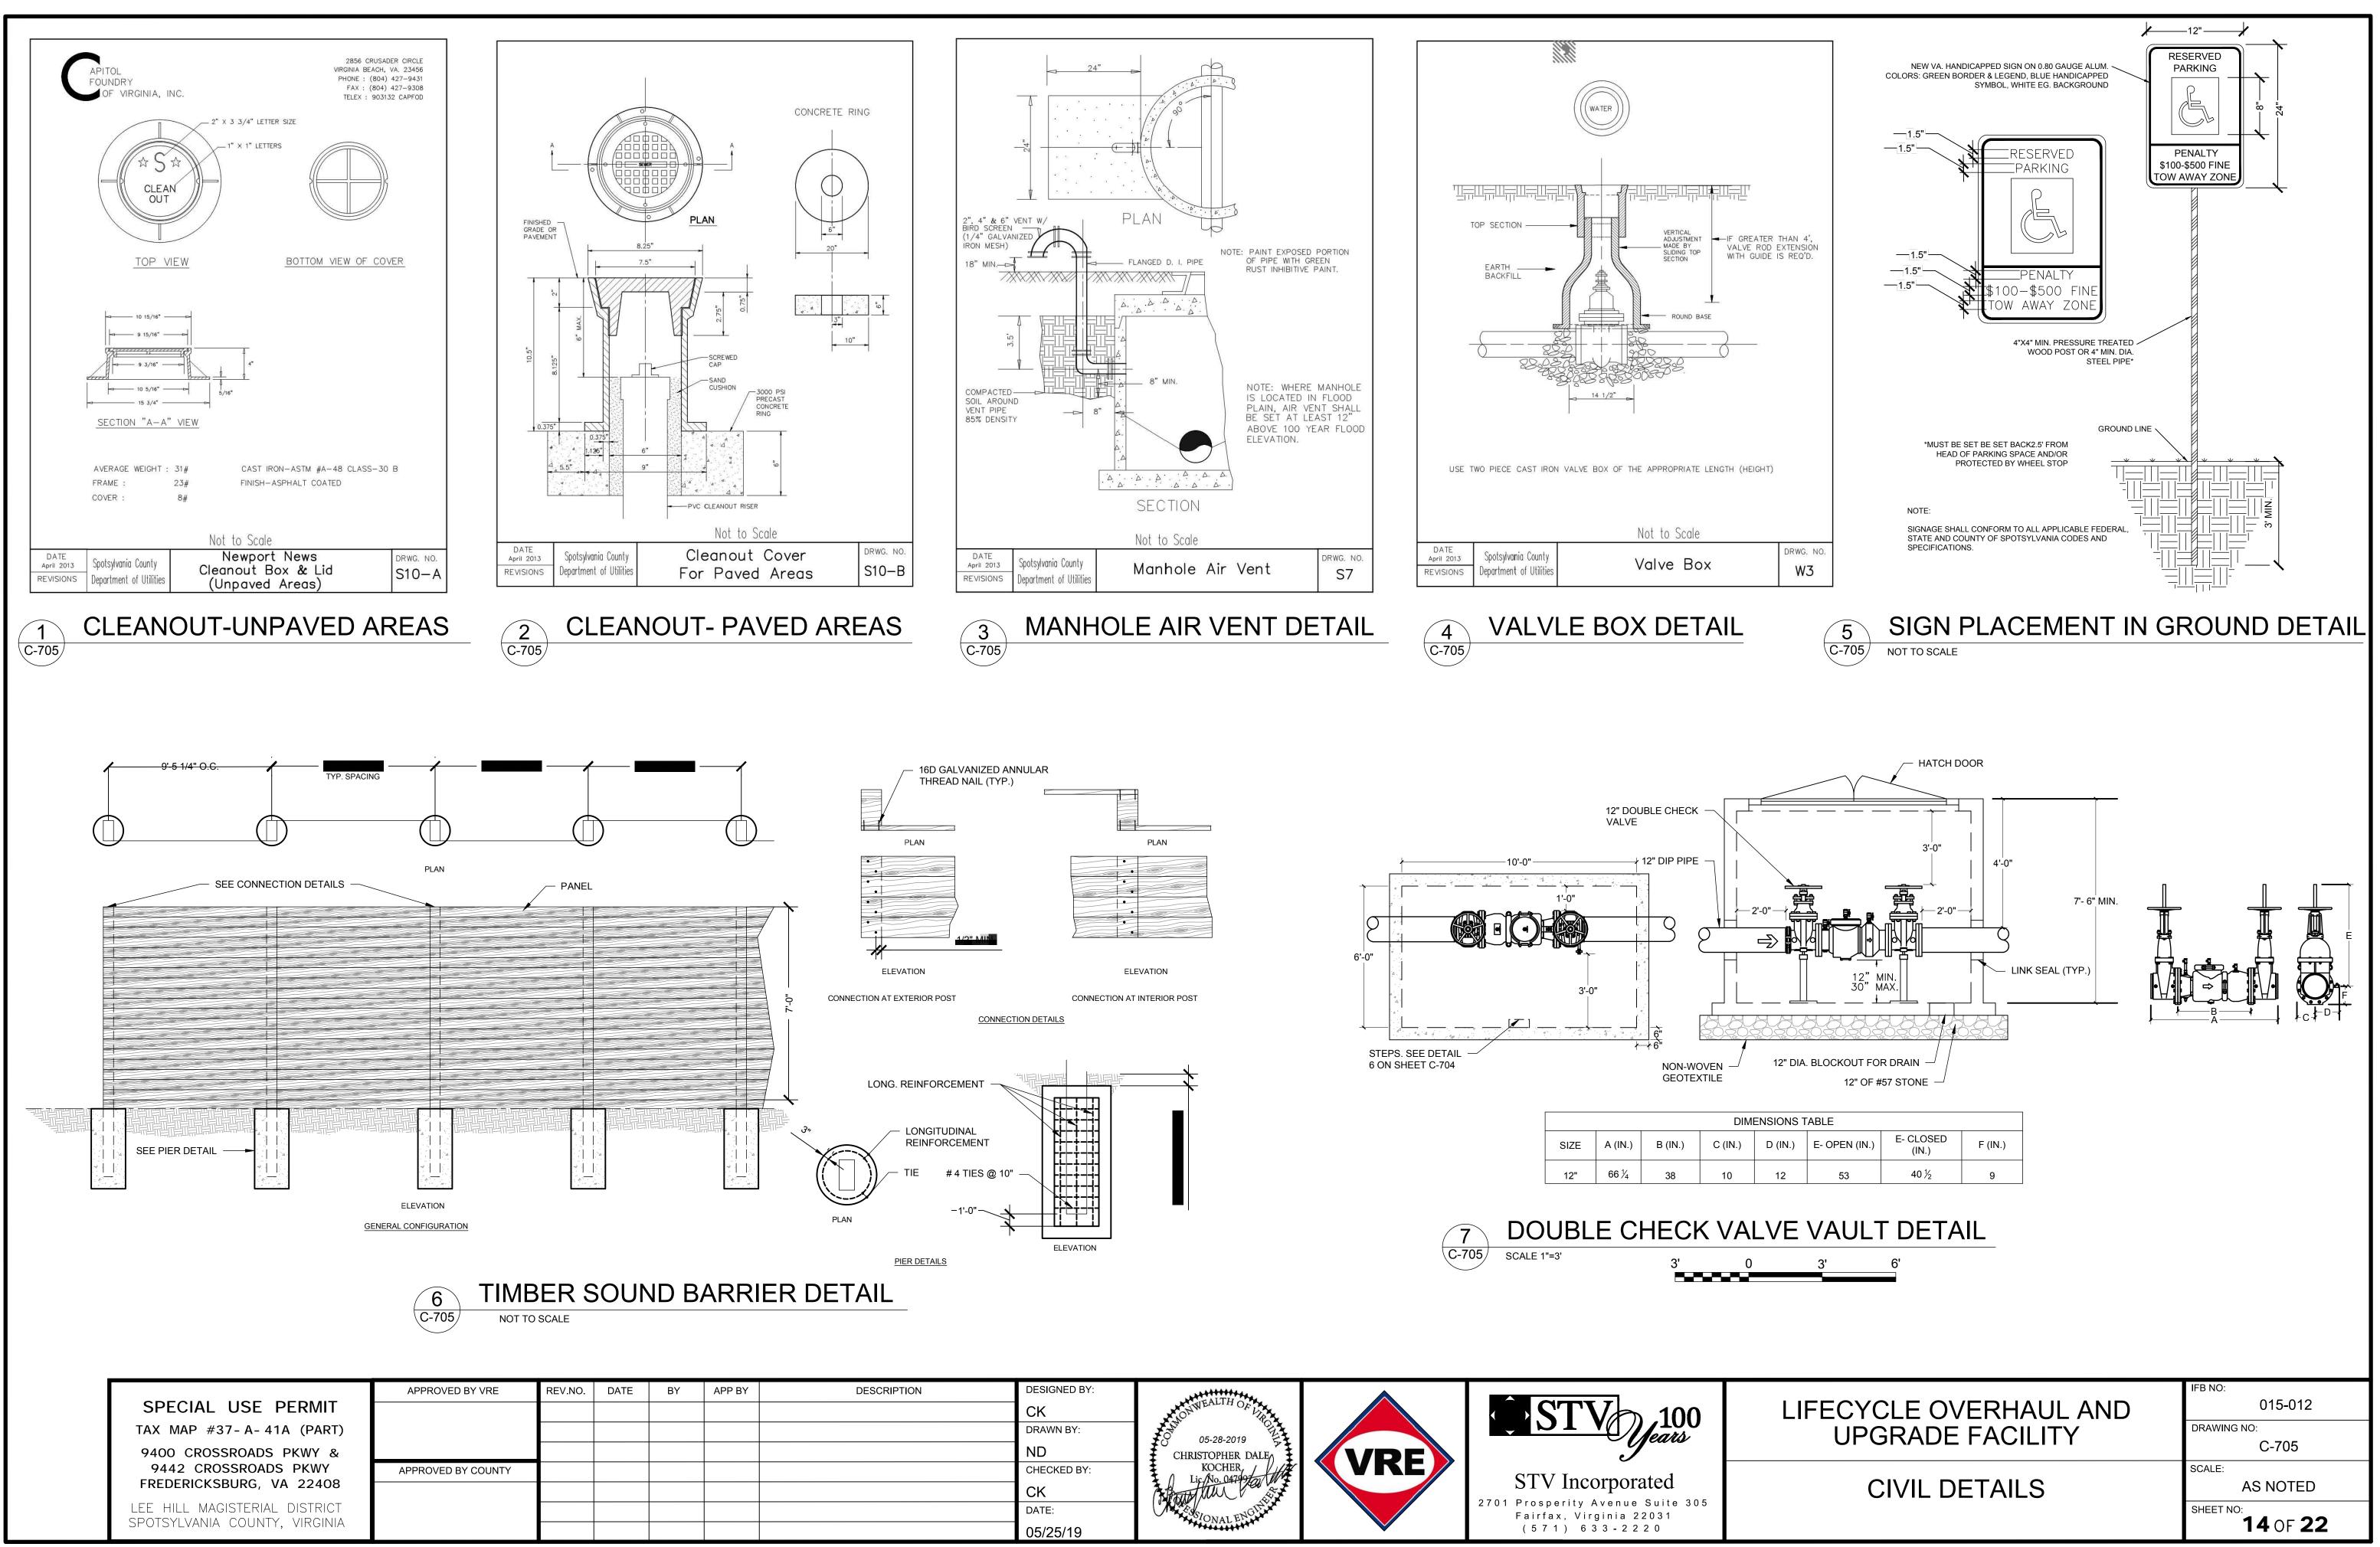


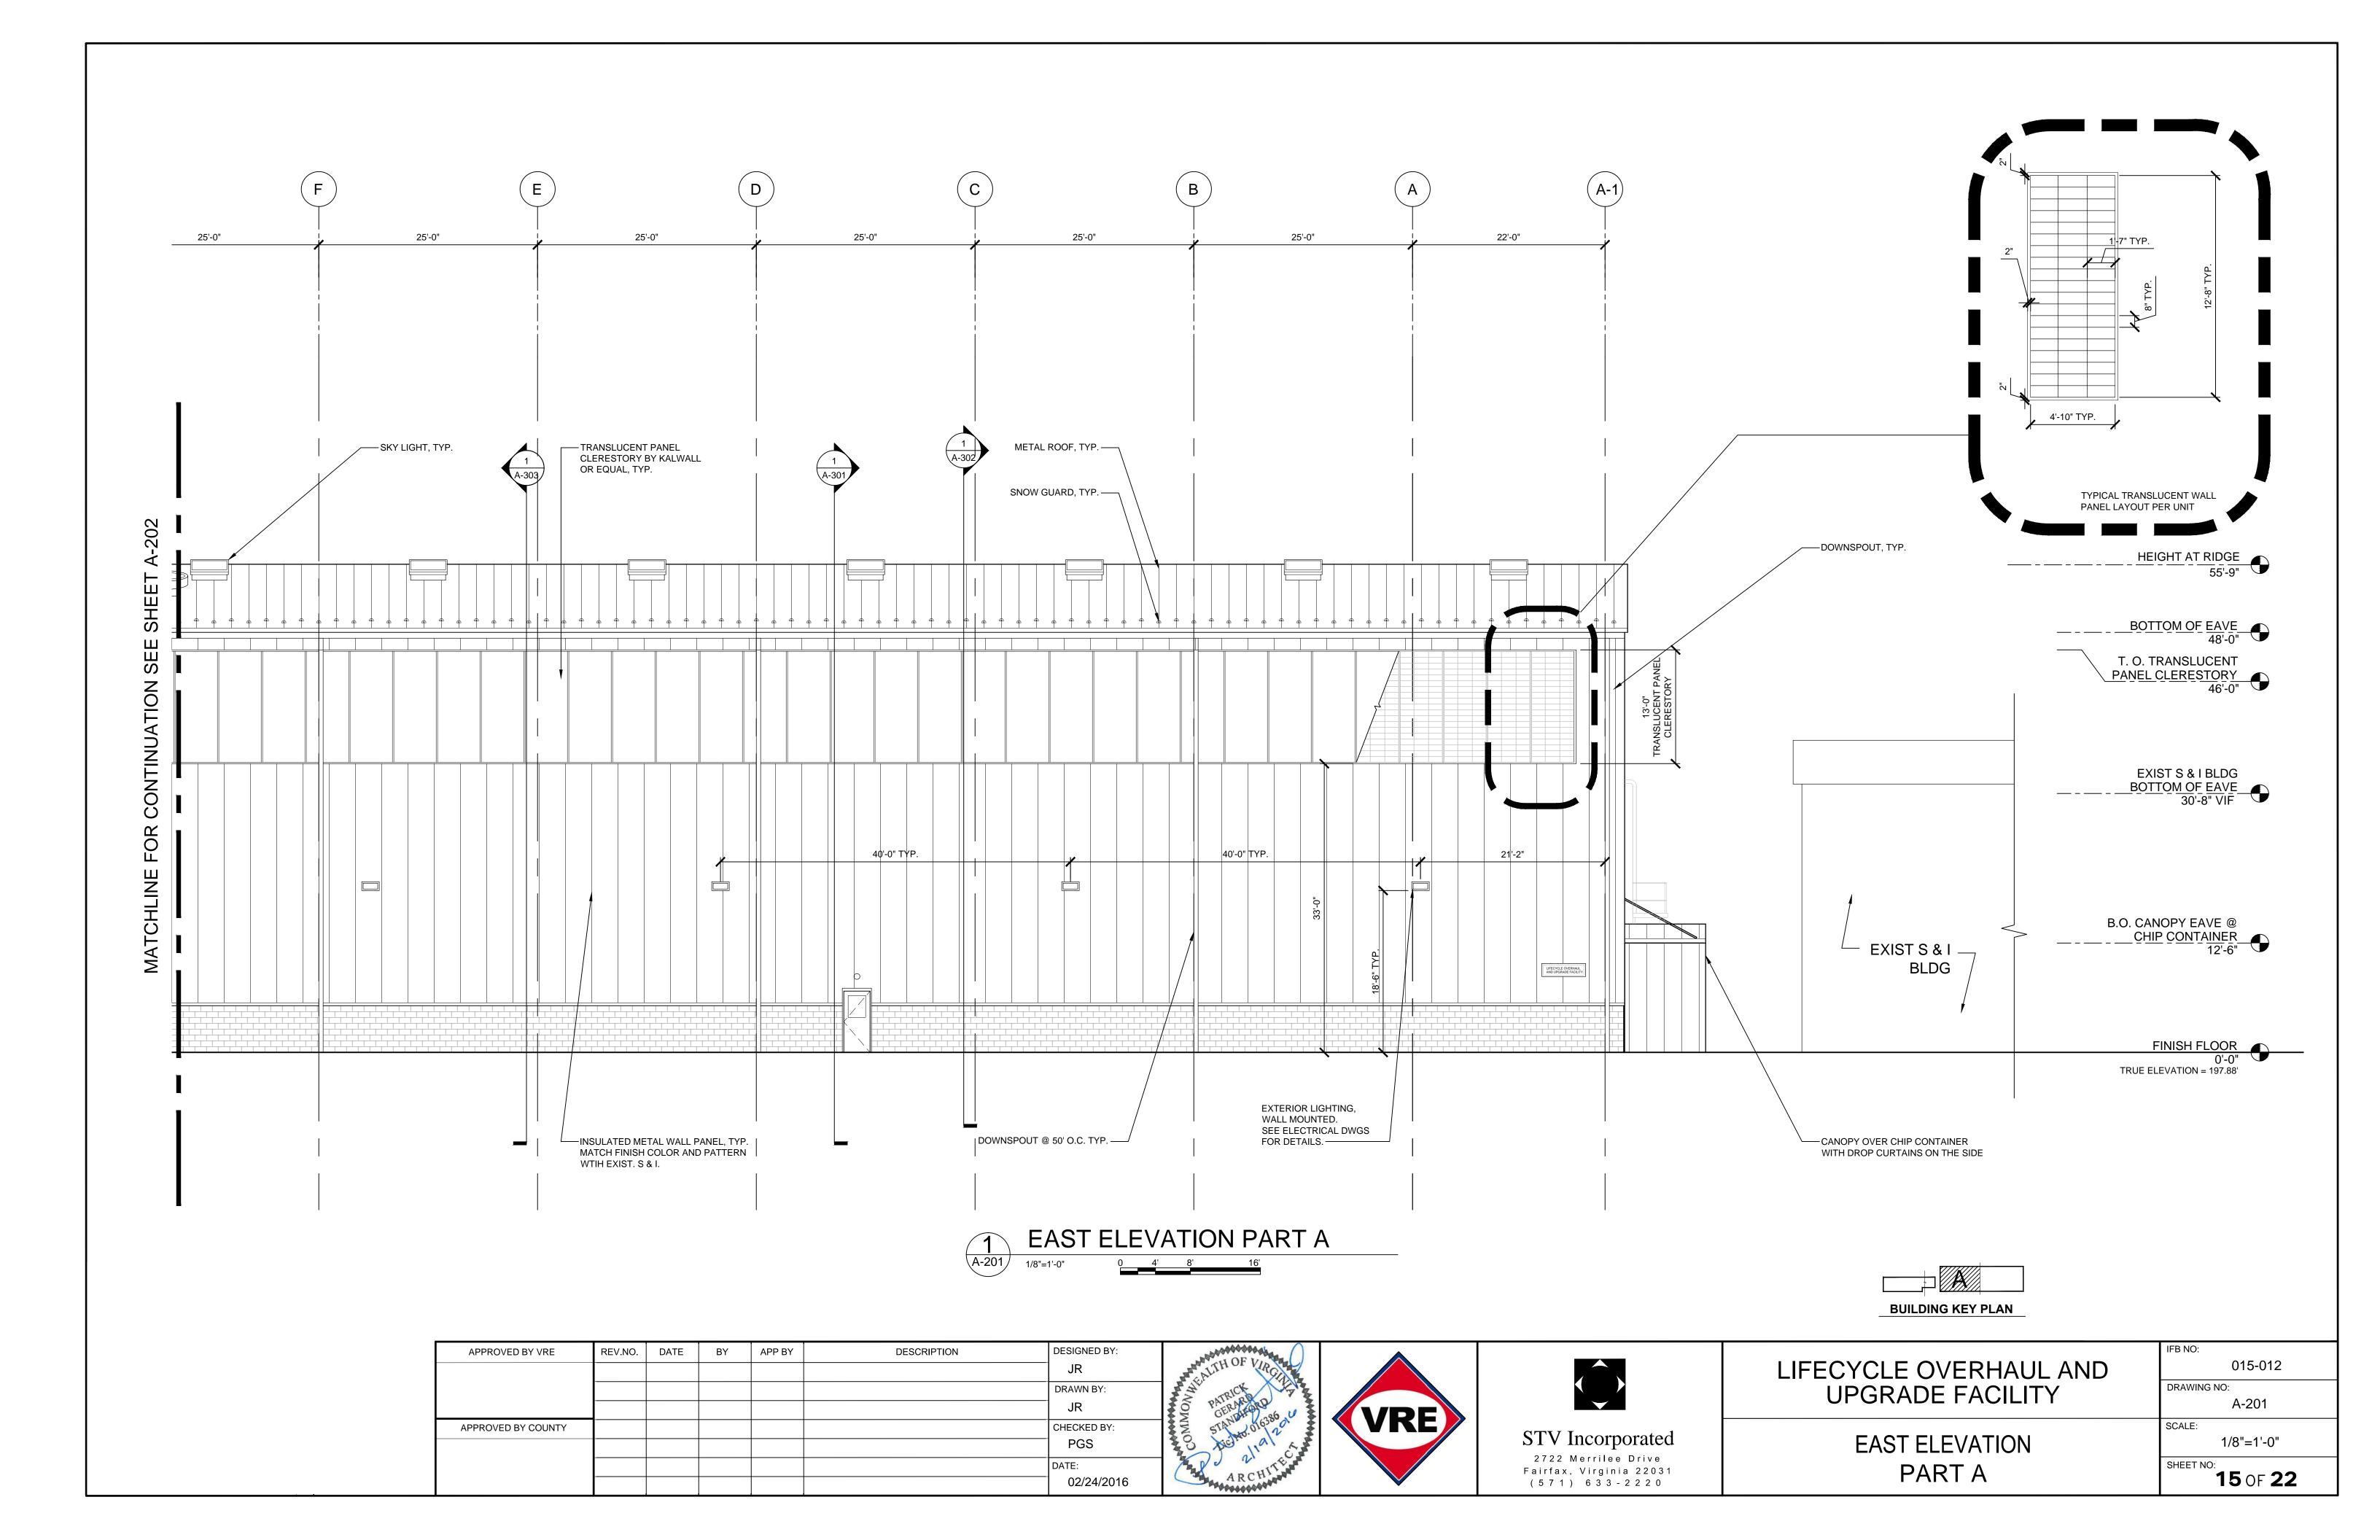

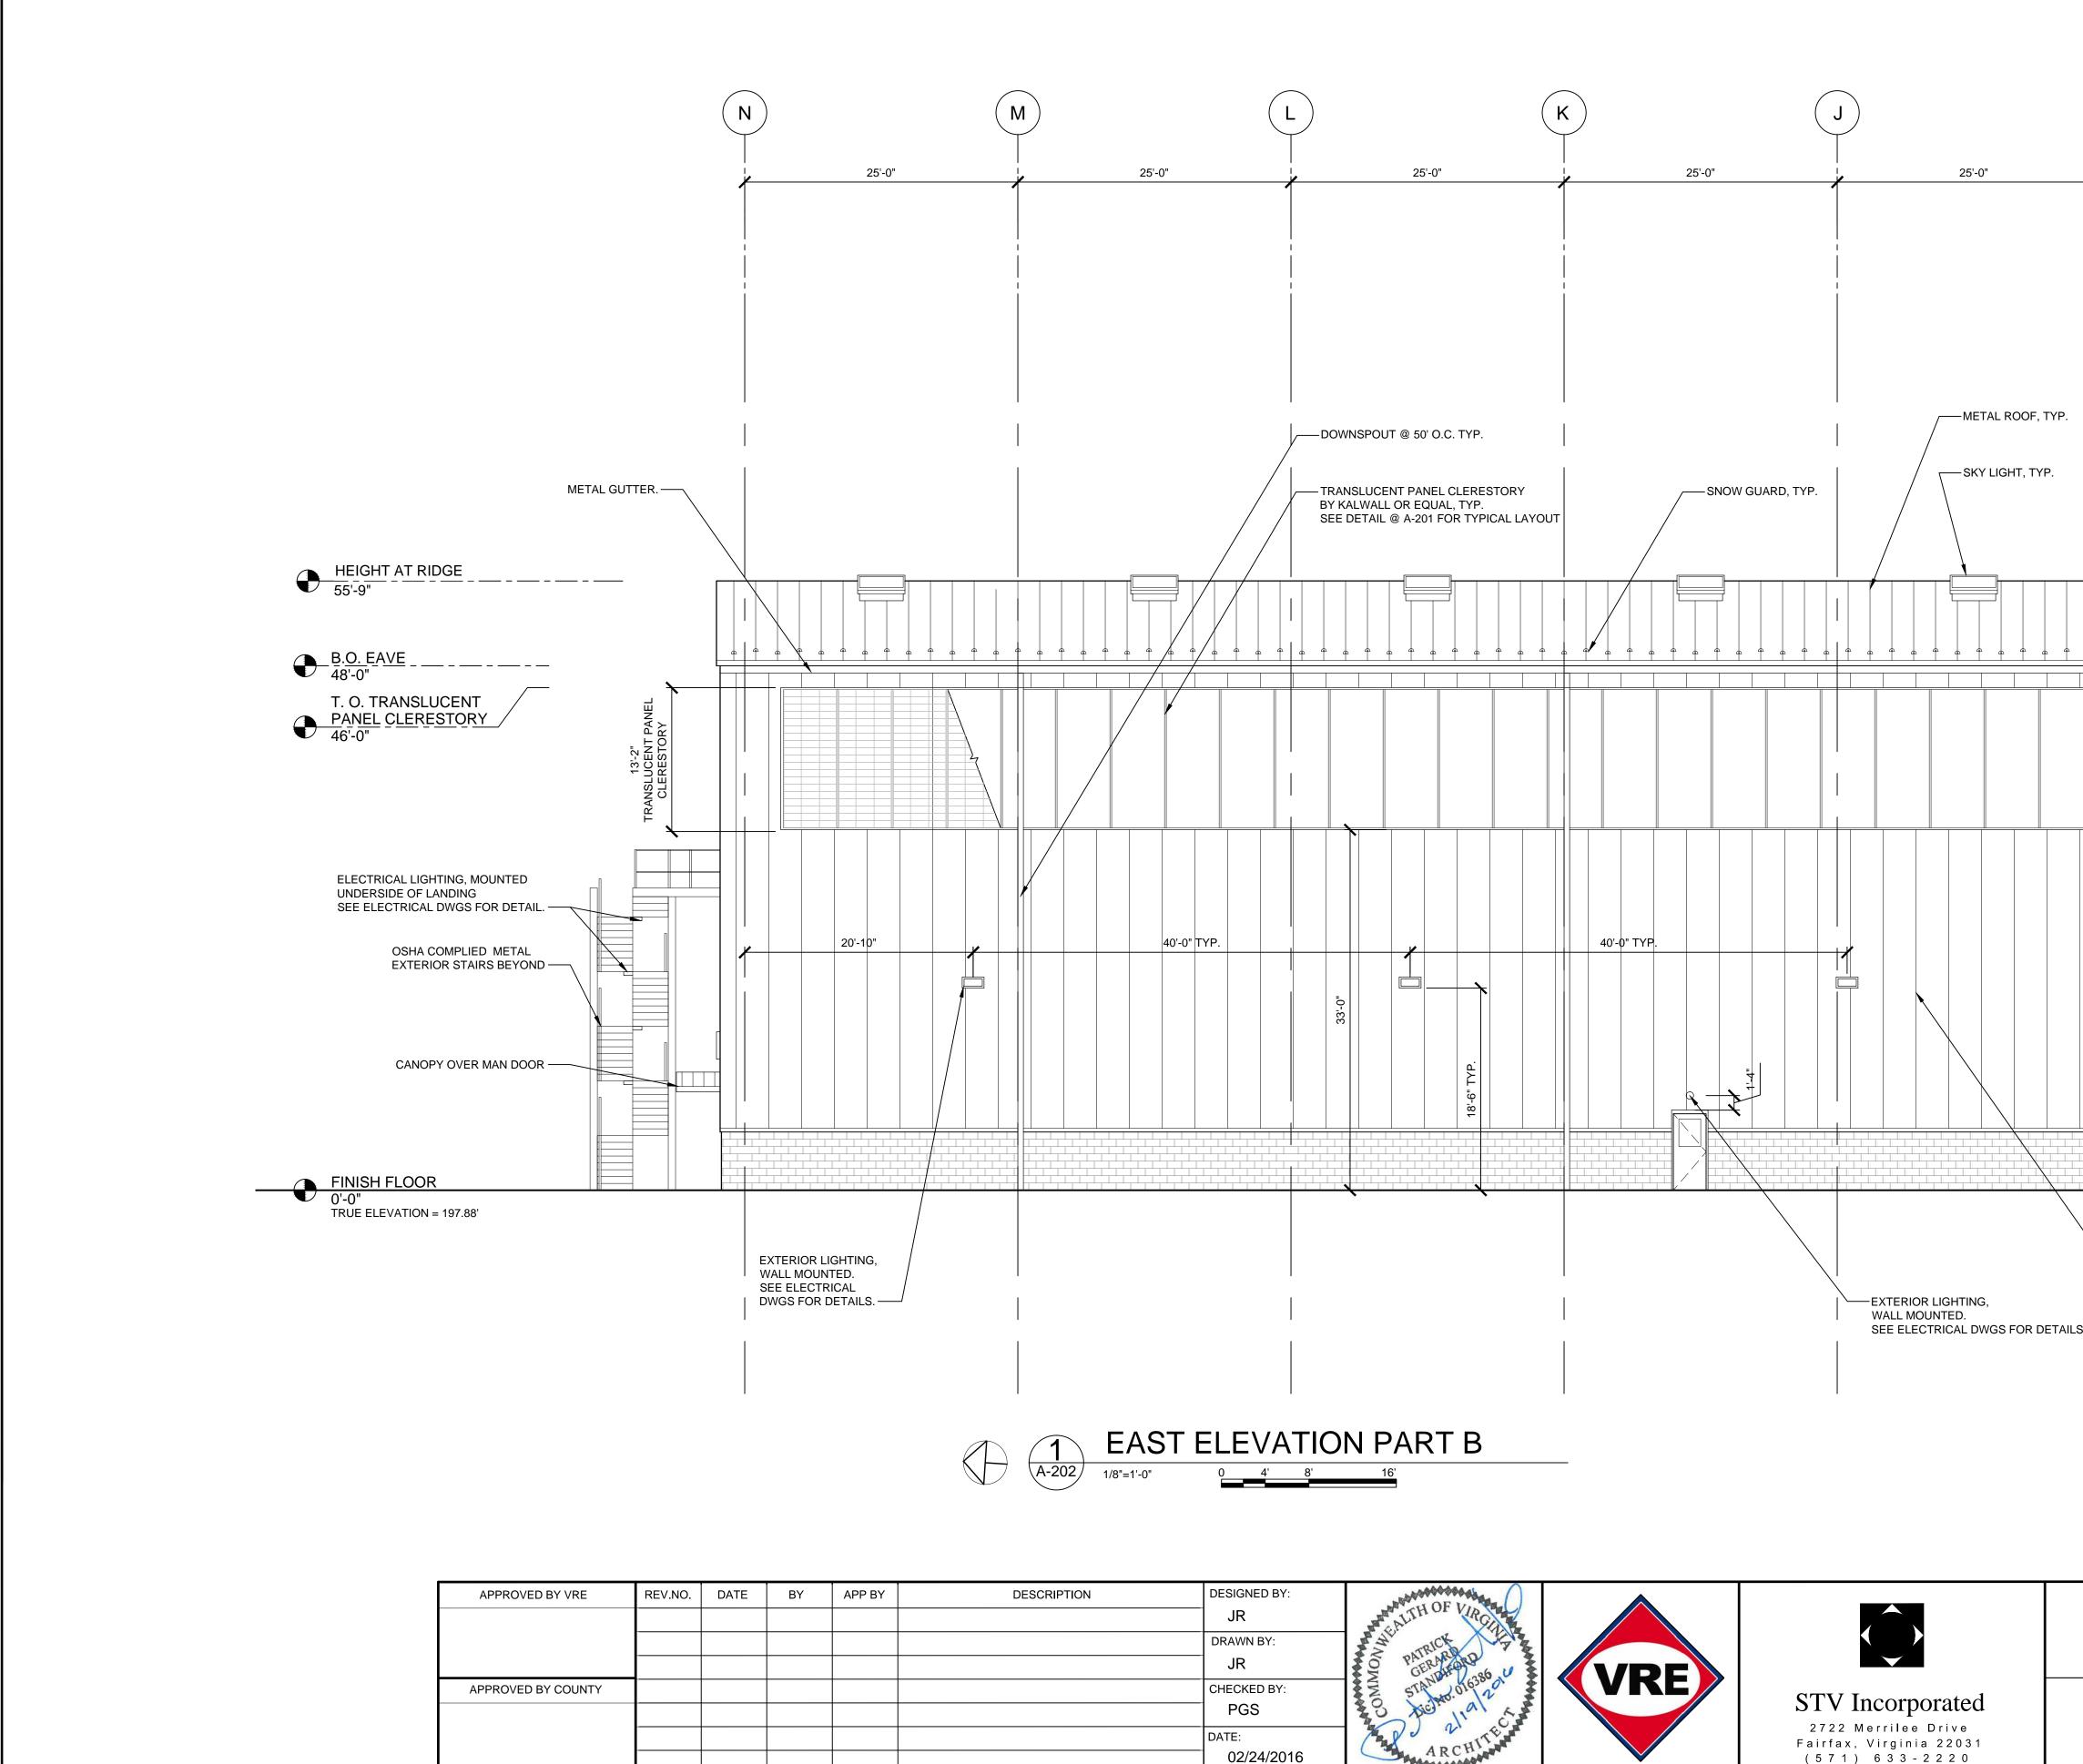


JR DRAWN BY: JR	PATRICK PATRICK			
 CHECKED BY: PGS DATE: 02/24/2016	ARCHITE ARCHITE	VRE	STV Incorporated 2722 Merrilee Drive Fairfax, Virginia 22031 (571) 633-2220	

BUILDING KEY PLAN LIFECYCLE OVERHAUL AND UPGRADE FACILITY	IFB NO: 015-012 DRAWING NO: A-202
EAST ELEVATION PART B	SCALE: 1/8"=1'-0" SHEET NO: <b>16</b> OF <b>22</b>

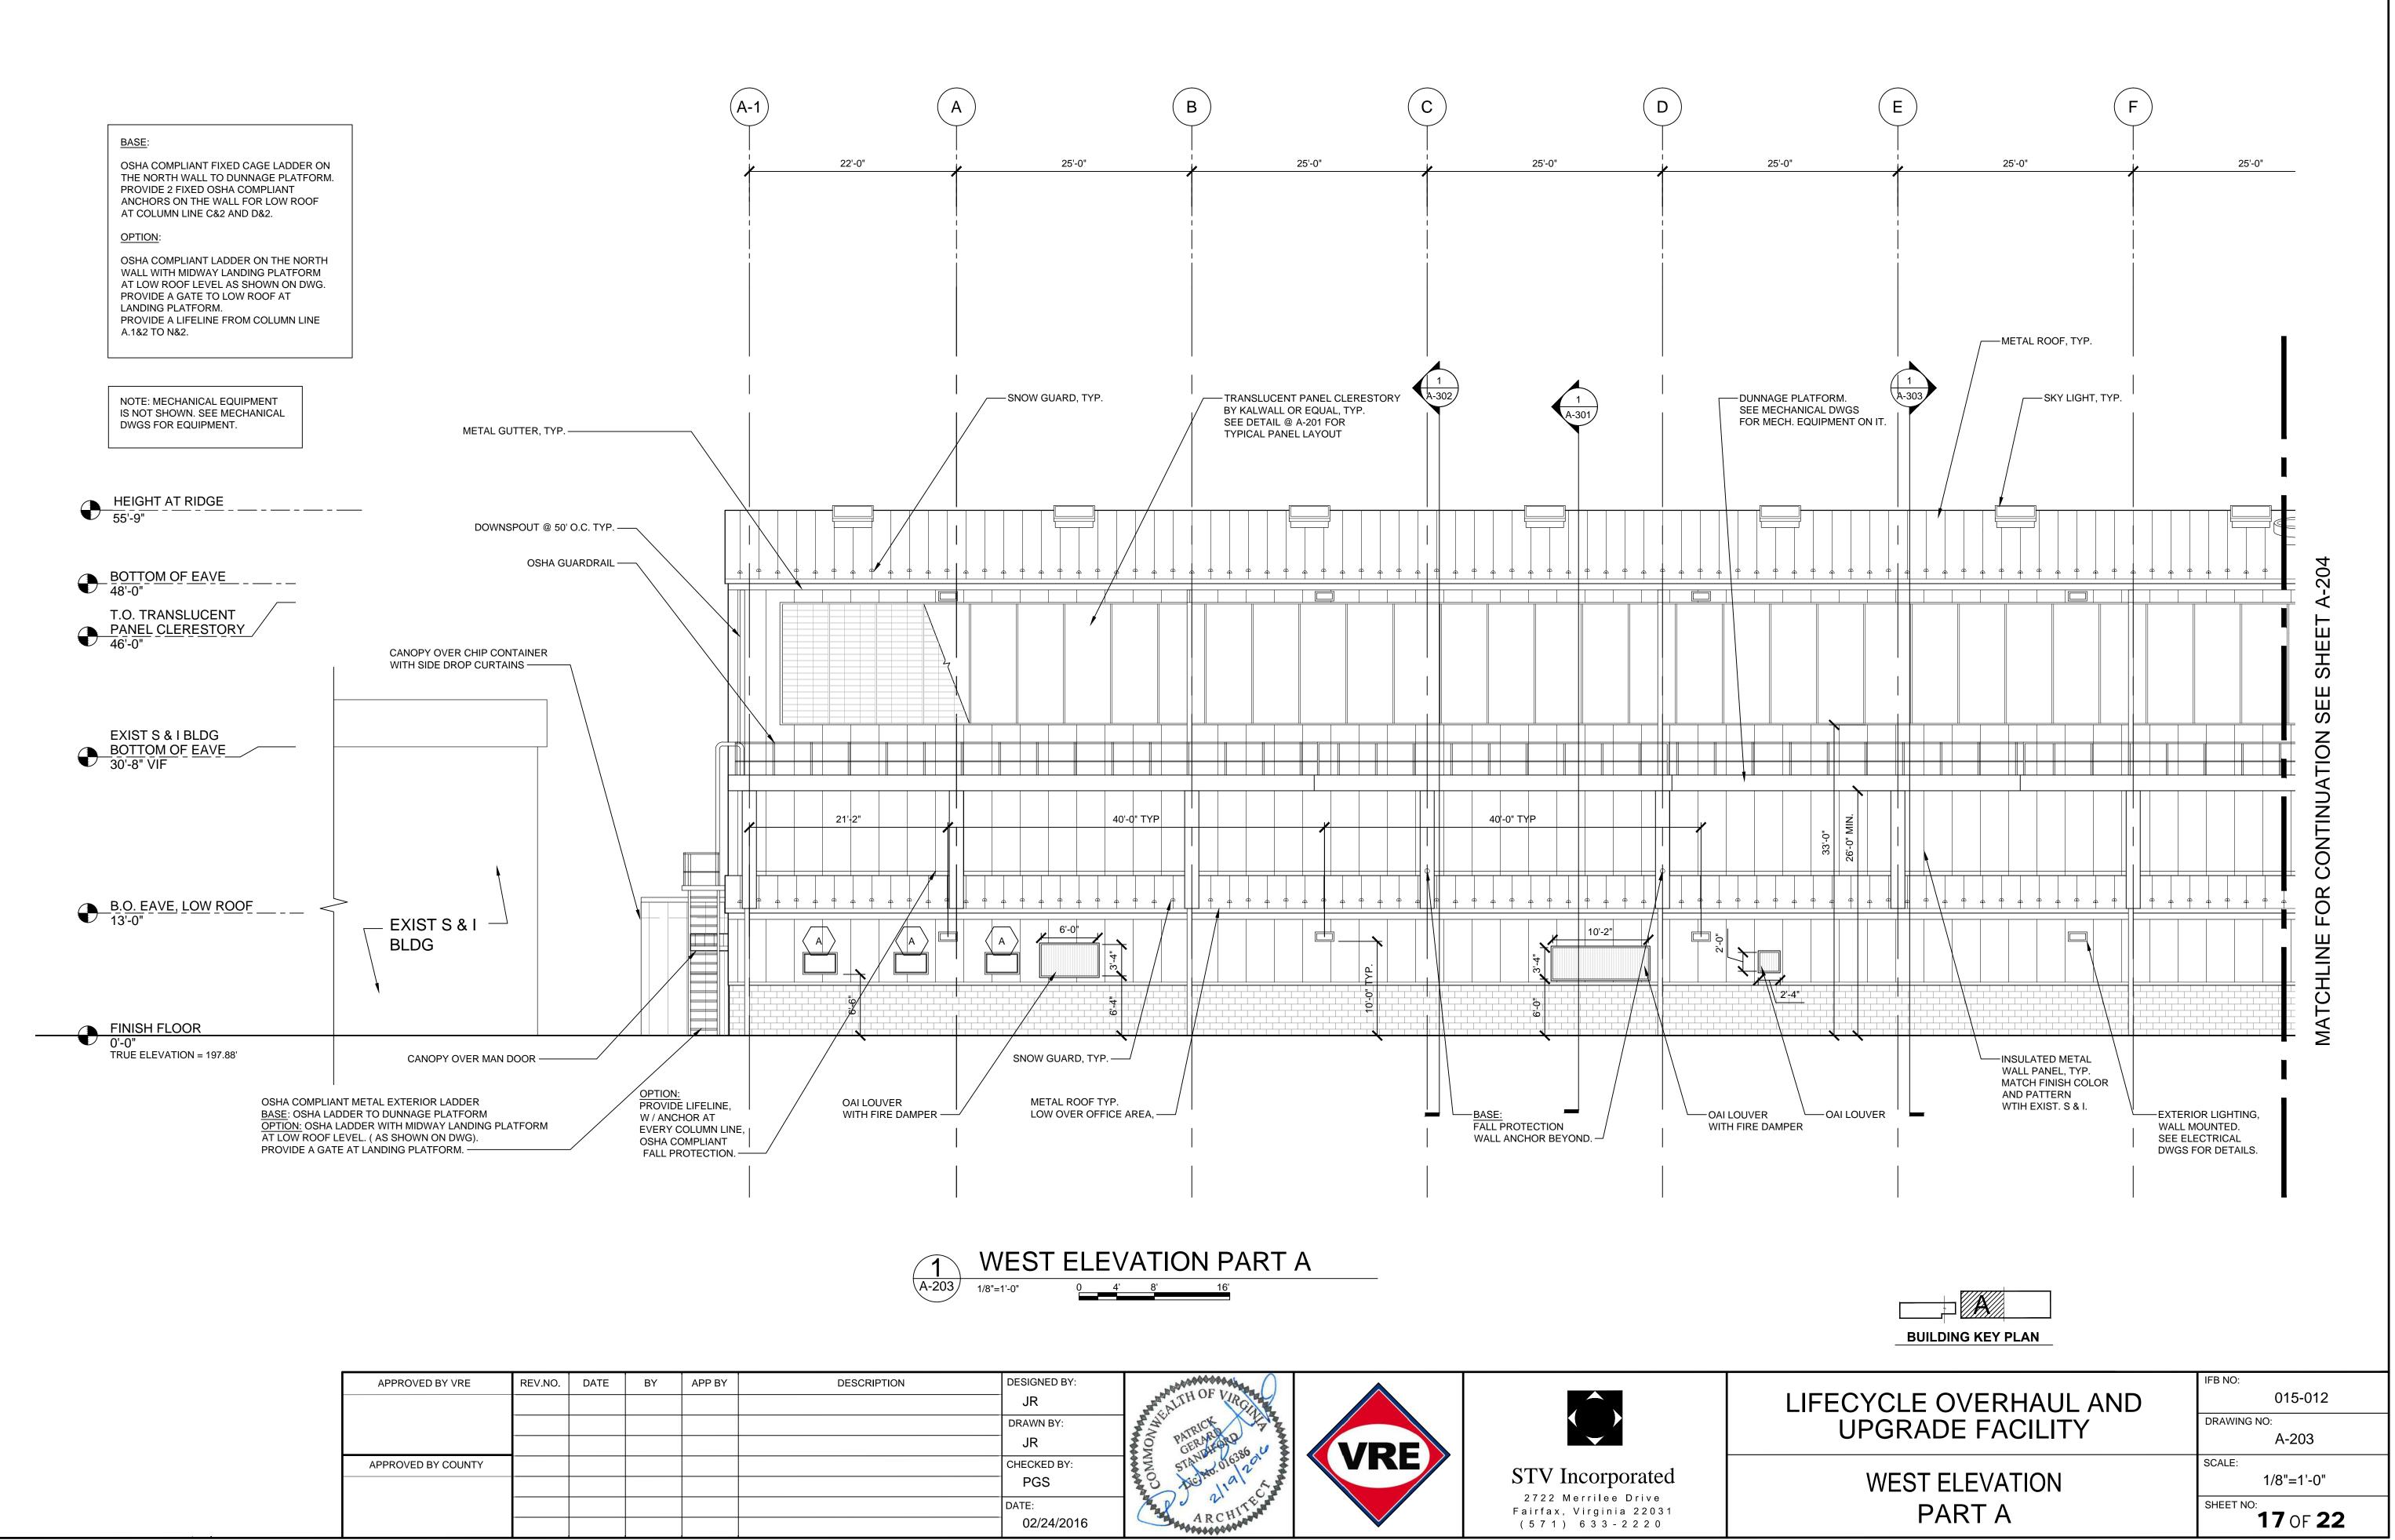


APPROVED BY VRE	REV.NO.	DATE	BY	APP BY	
APPROVED BY COUNTY					
	-				

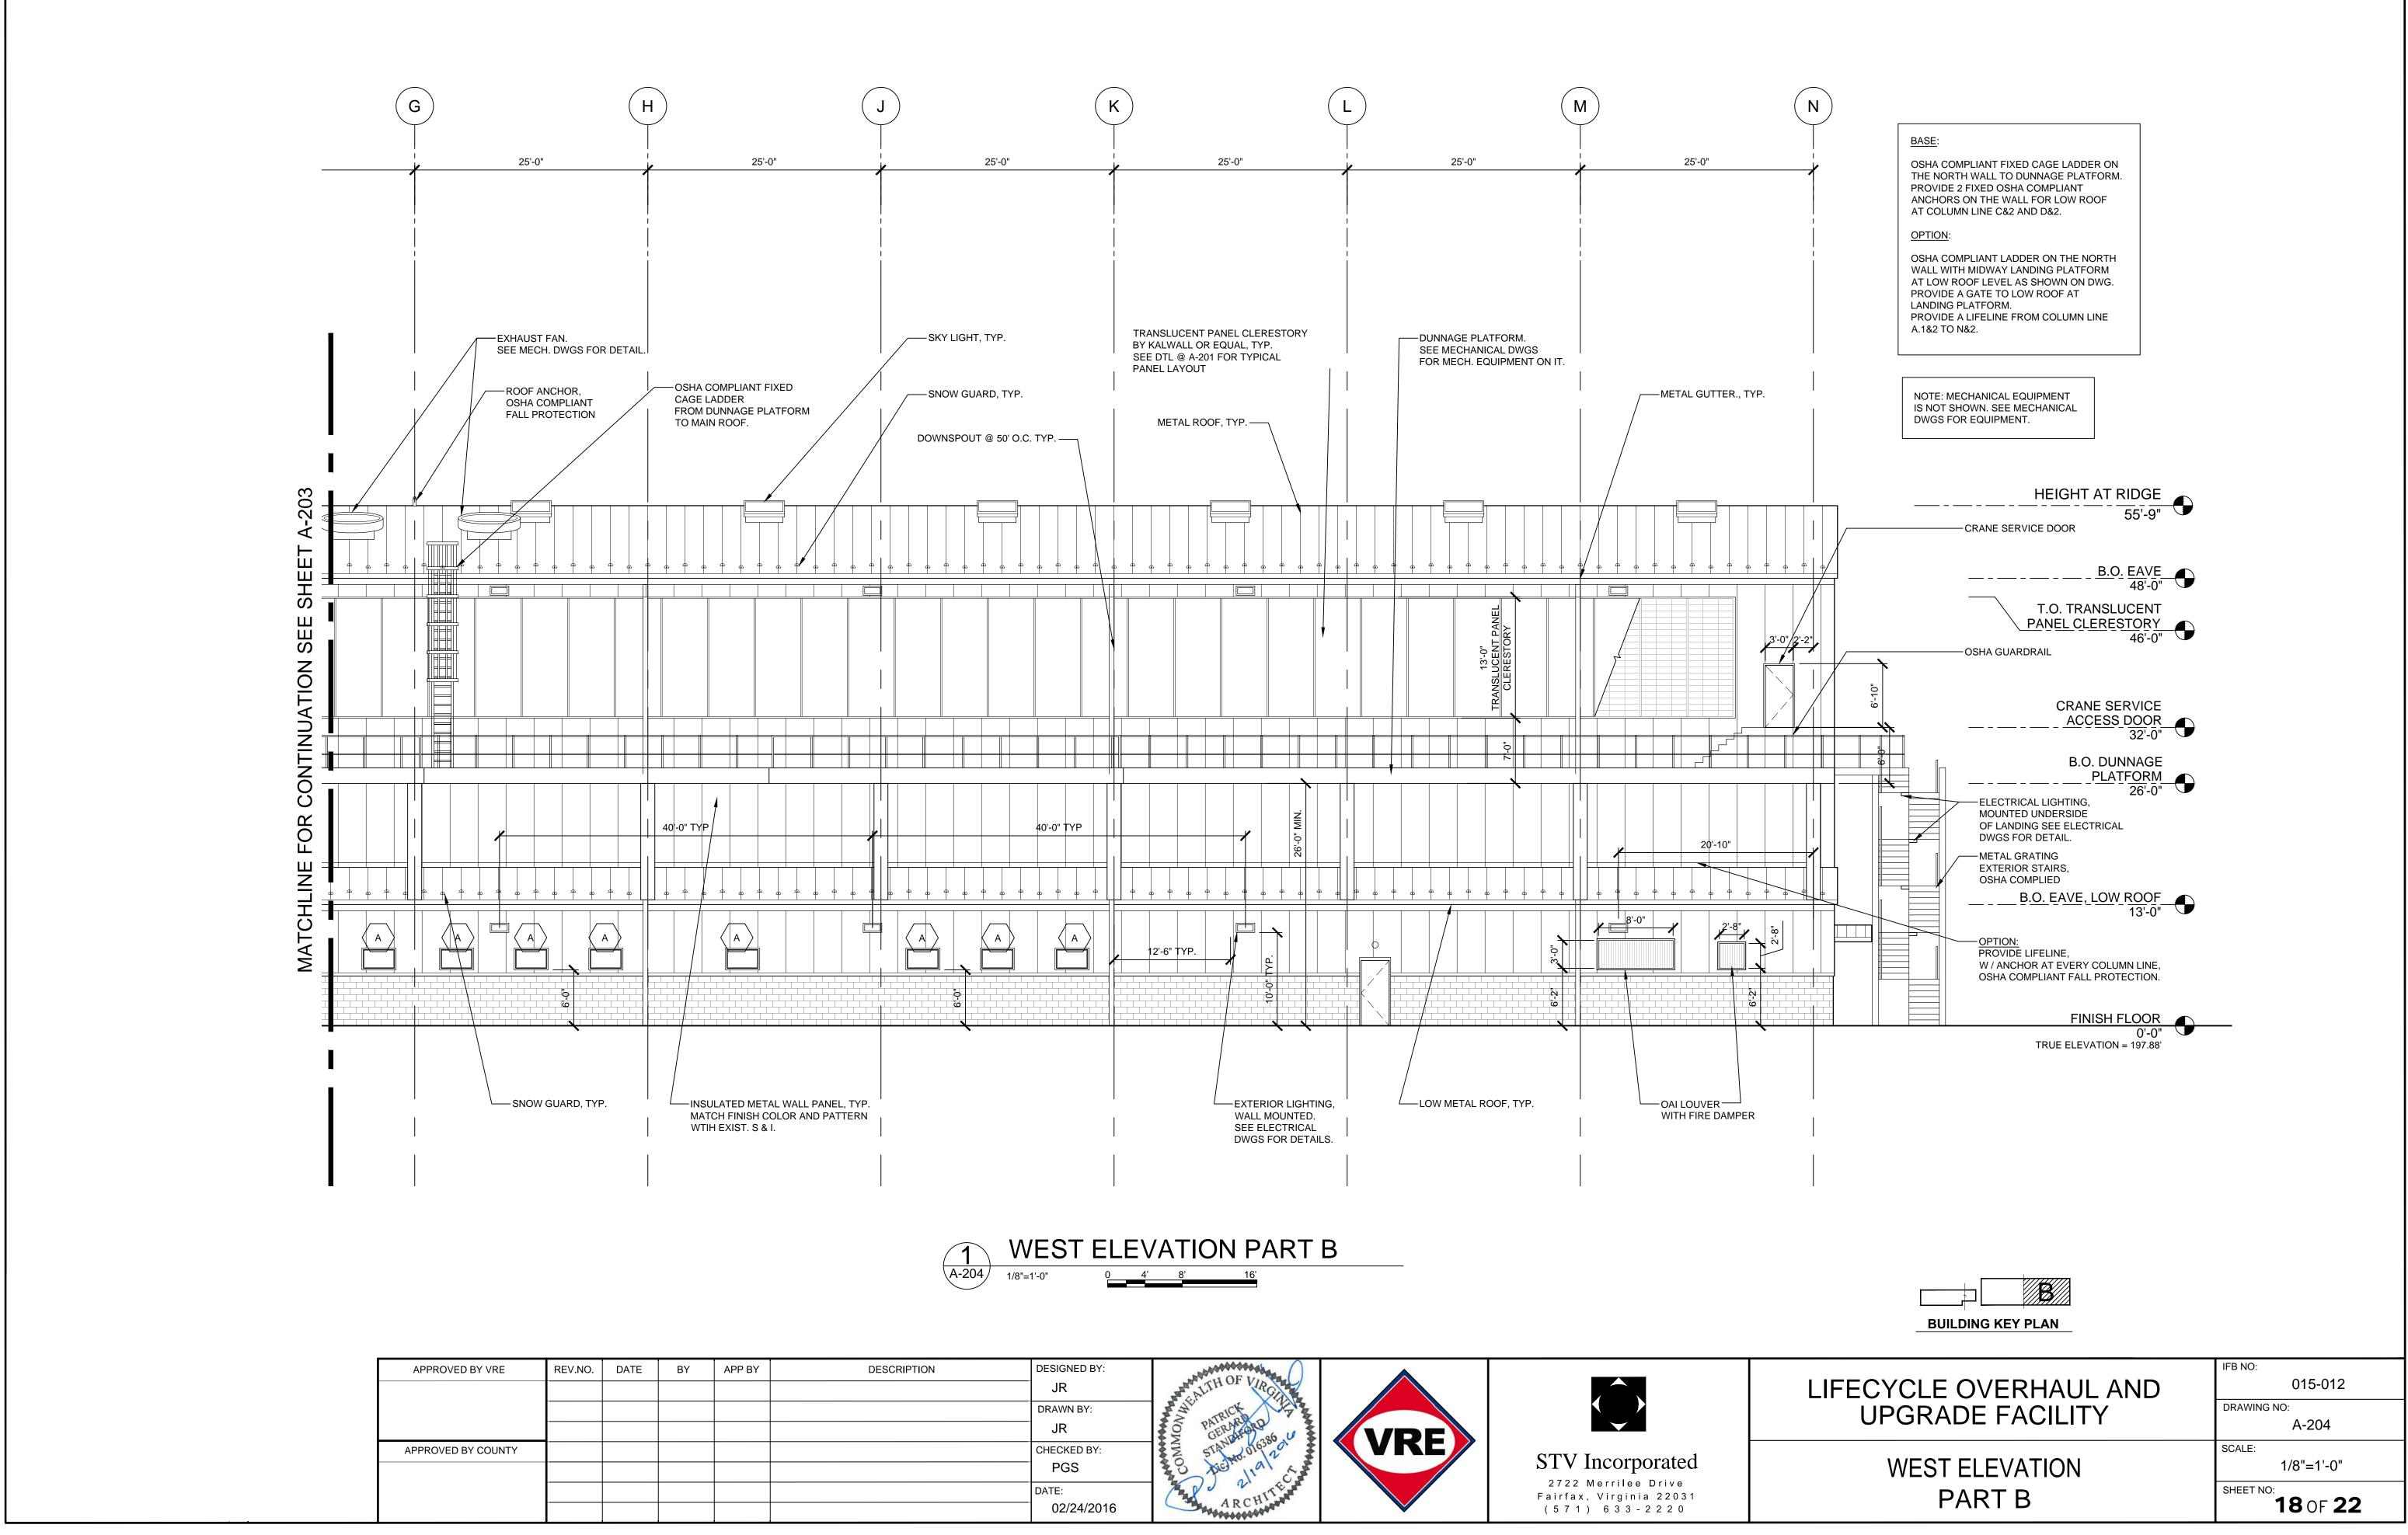

	$\frown$
	(3)
BASE:	Ť
OSHA COMPLIANT FIXED CAGE LADDER ON THE NORTH WALL TO DUNNAGE PLATFORM. PROVIDE 2 FIXED OSHA COMPLIANT ANCHORS ON THE WALL FOR LOW ROOF AT COLUMN LINE C&2 AND D&2.	
OPTION:	
OSHA COMPLIANT LADDER ON THE NORTH WALL WITH MIDWAY LANDING PLATFORM AT LOW ROOF LEVEL AS SHOWN ON DWG. PROVIDE A GATE TO LOW ROOF AT LANDING PLATFORM. PROVIDE A LIFELINE FROM COLUMN LINE A.1&2 TO N&2.	
EXHAUST FAN. SEE MECH. DWGS	FOR DETAIL.
METAL G	UTTER, TYP.
HEIGHT AT RIDGE 55'-9" OSHA COMPLIANT FIXED CAGE	E LADDER.
<b>30</b> -9	
BOTTOM OF EAVE	
DOWNSPOUT @	50' O.C. TYP
DUNNAGE PLATFORM W/ OSHA GUARDR/ SEE STRUCTURAL DWGS FOR DETAILS.	AIL SYSTEM.
EXIST S & I BLDG BOTTOM OF EAVE	
T.O. DUNNAGE PLATFORM	
ELECTRICAL LIGHTING, M UNDERSIDE OF LANDING SEE ELECTRICAL DWGS	
SNOW	GUARD, TYP
B.O. LOW ROOF	
13'-0" <u>BASE</u> : PROVIDE TWO FIXED_ANCHO THE WALL AT COLUMN LINE 2&C, 28 OSHA COMPLIANT FALL PROTECTIO <u>OPTION</u> : PROVIDE LIFELINE, OSHA COMPLIANT FALL PROTECTIO FROM COLUMN LINE A.1&2 TO N&2.	AD, DN.
	5- 
FINISH FLOOR 0'-0"	<b>────∖</b>


APPROVED BY VRE	REV.NO.	DATE	BY	APP BY	
APPROVED BY COUNTY					

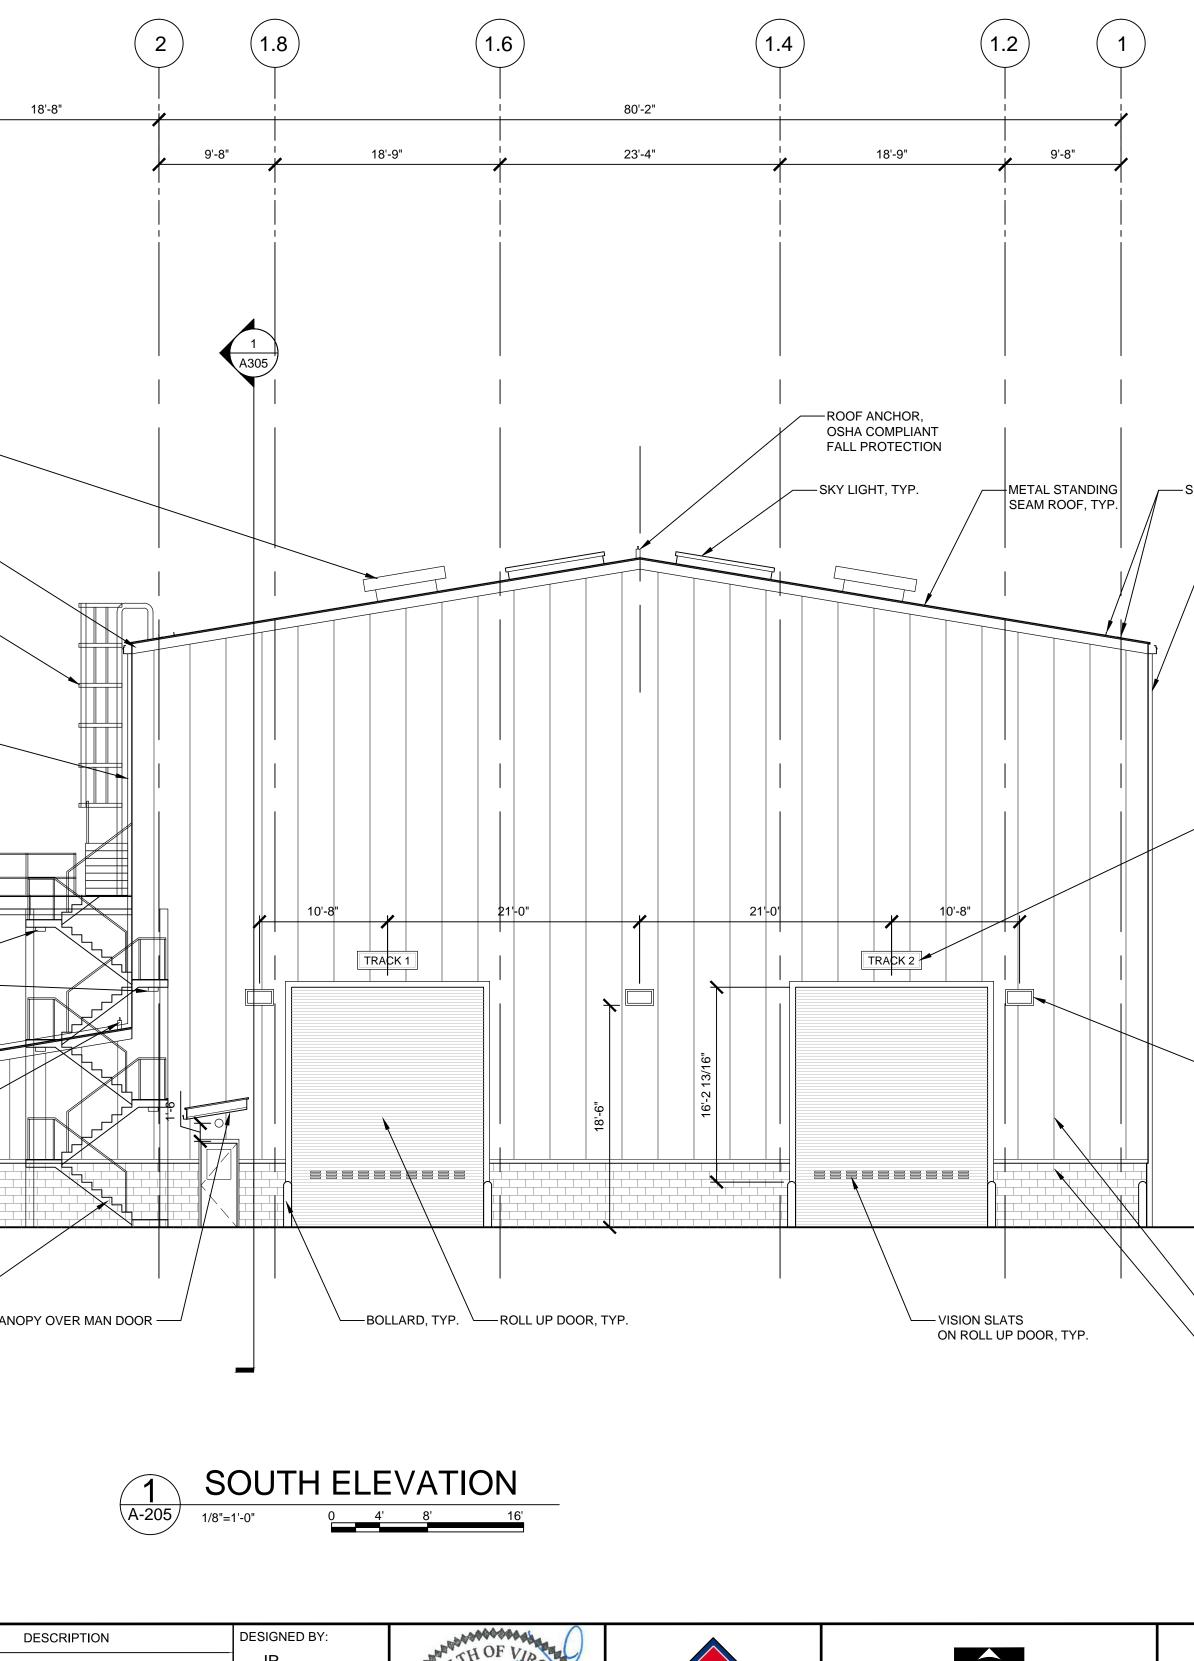


DESCRIPTION	JR DRAWN BY:	HALTH OF VIRCE			
	JR	ON PATRICKARD OD GERNARD 6386	VRF		
	CHECKED BY: PGS	B Shi No.01 2		STV Incorporated	
	DATE: 02/24/2016	ARCHIT		Fairfax, Virginia 22031 (571) 633-2220	


	DOWNSPOUT @ 50'-0" O.C., TYP.	
FOR DETAIL EXTERIOR LIGHTING, WALL MOUNTED. SEE ELECTRICAL DWGS FOR DETAILS. FINISH FLOOR 0'-0" TRUE ELEVATION = 197.88 INSULATED METAL WALL PANEL, TVP. 8' SPLITFACE CONCRETE BLOCK, TVP. BUILDING KEY PLAN IFB NO: 015-012 DRAWING NO:	48'-0" T.O. TRANSLUCENT PANEL CLERESTORY	
SEE ELECTRICAL DWGS FOR DETAILS. FINISH FLOOR 0'-0" TRUE ELEVATION = 197.88' INSULATED METAL WALL PANEL, TYP. 8' SPLITFACE CONCRETE BLOCK, TYP. BUILDING KEY PLAN LIFECYCLE OVERHAUL AND		
0-0" TRUE ELEVATION = 197.88' INSULATED METAL WALL PANEL, TYP. 8" SPLITFACE CONCRETE BLOCK, TYP. BUILDING KEY PLAN BUILDING KEY PLAN IFB NO: 015-012 DRAWING NO:		
LIFECYCLE OVERHAUL AND UPGRADE EACILITY DRAWING NO:	0'-0" TRUE ELEVATION = 197.88' INSULATED METAL WALL PANEL, TYP.	
LIFECYCLE OVERHAUL AND 015-012 DRAWING NO:	BUILDING KEY PLAN	
A-205	LIFECYCLE OVERHAUL AND UPGRADE FACILITY	015-012
SOUTH ELEVATION SCALE: 1/8"=1'-0" SHEET NO: 19 OF 22	SOUTH ELEVATION	1/8"=1'-0"

SNOW GUARD, TYP.

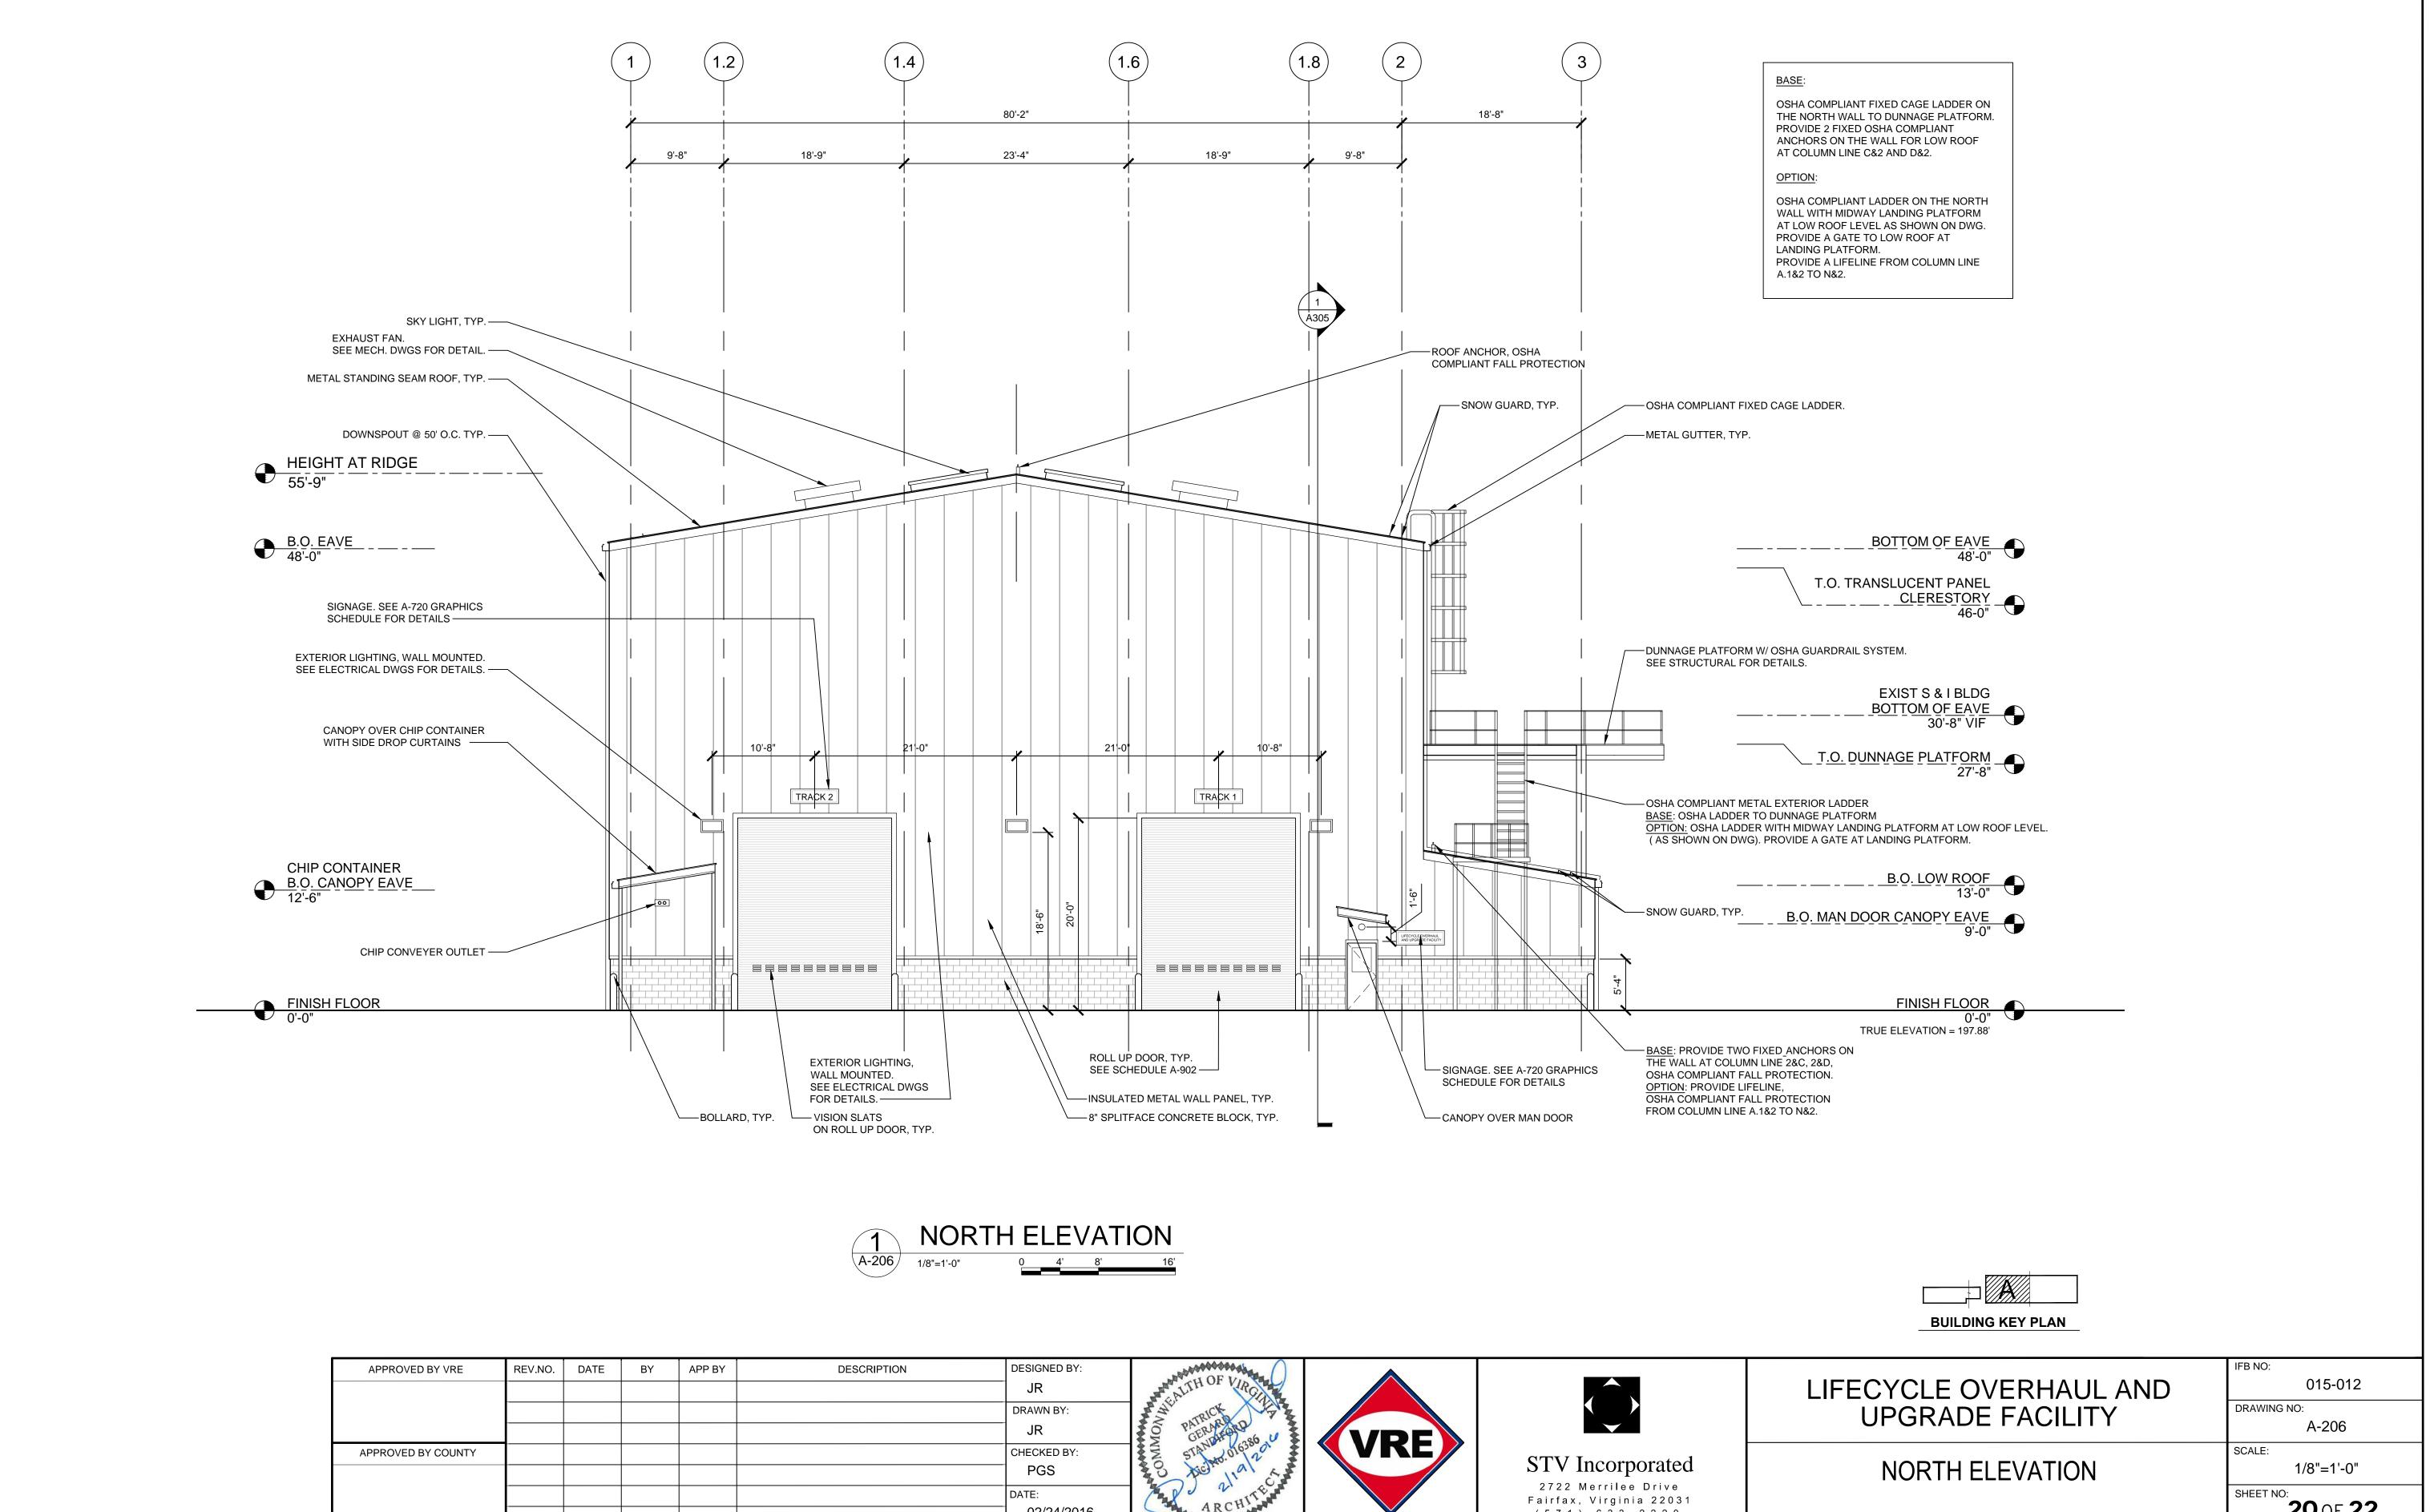

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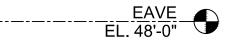


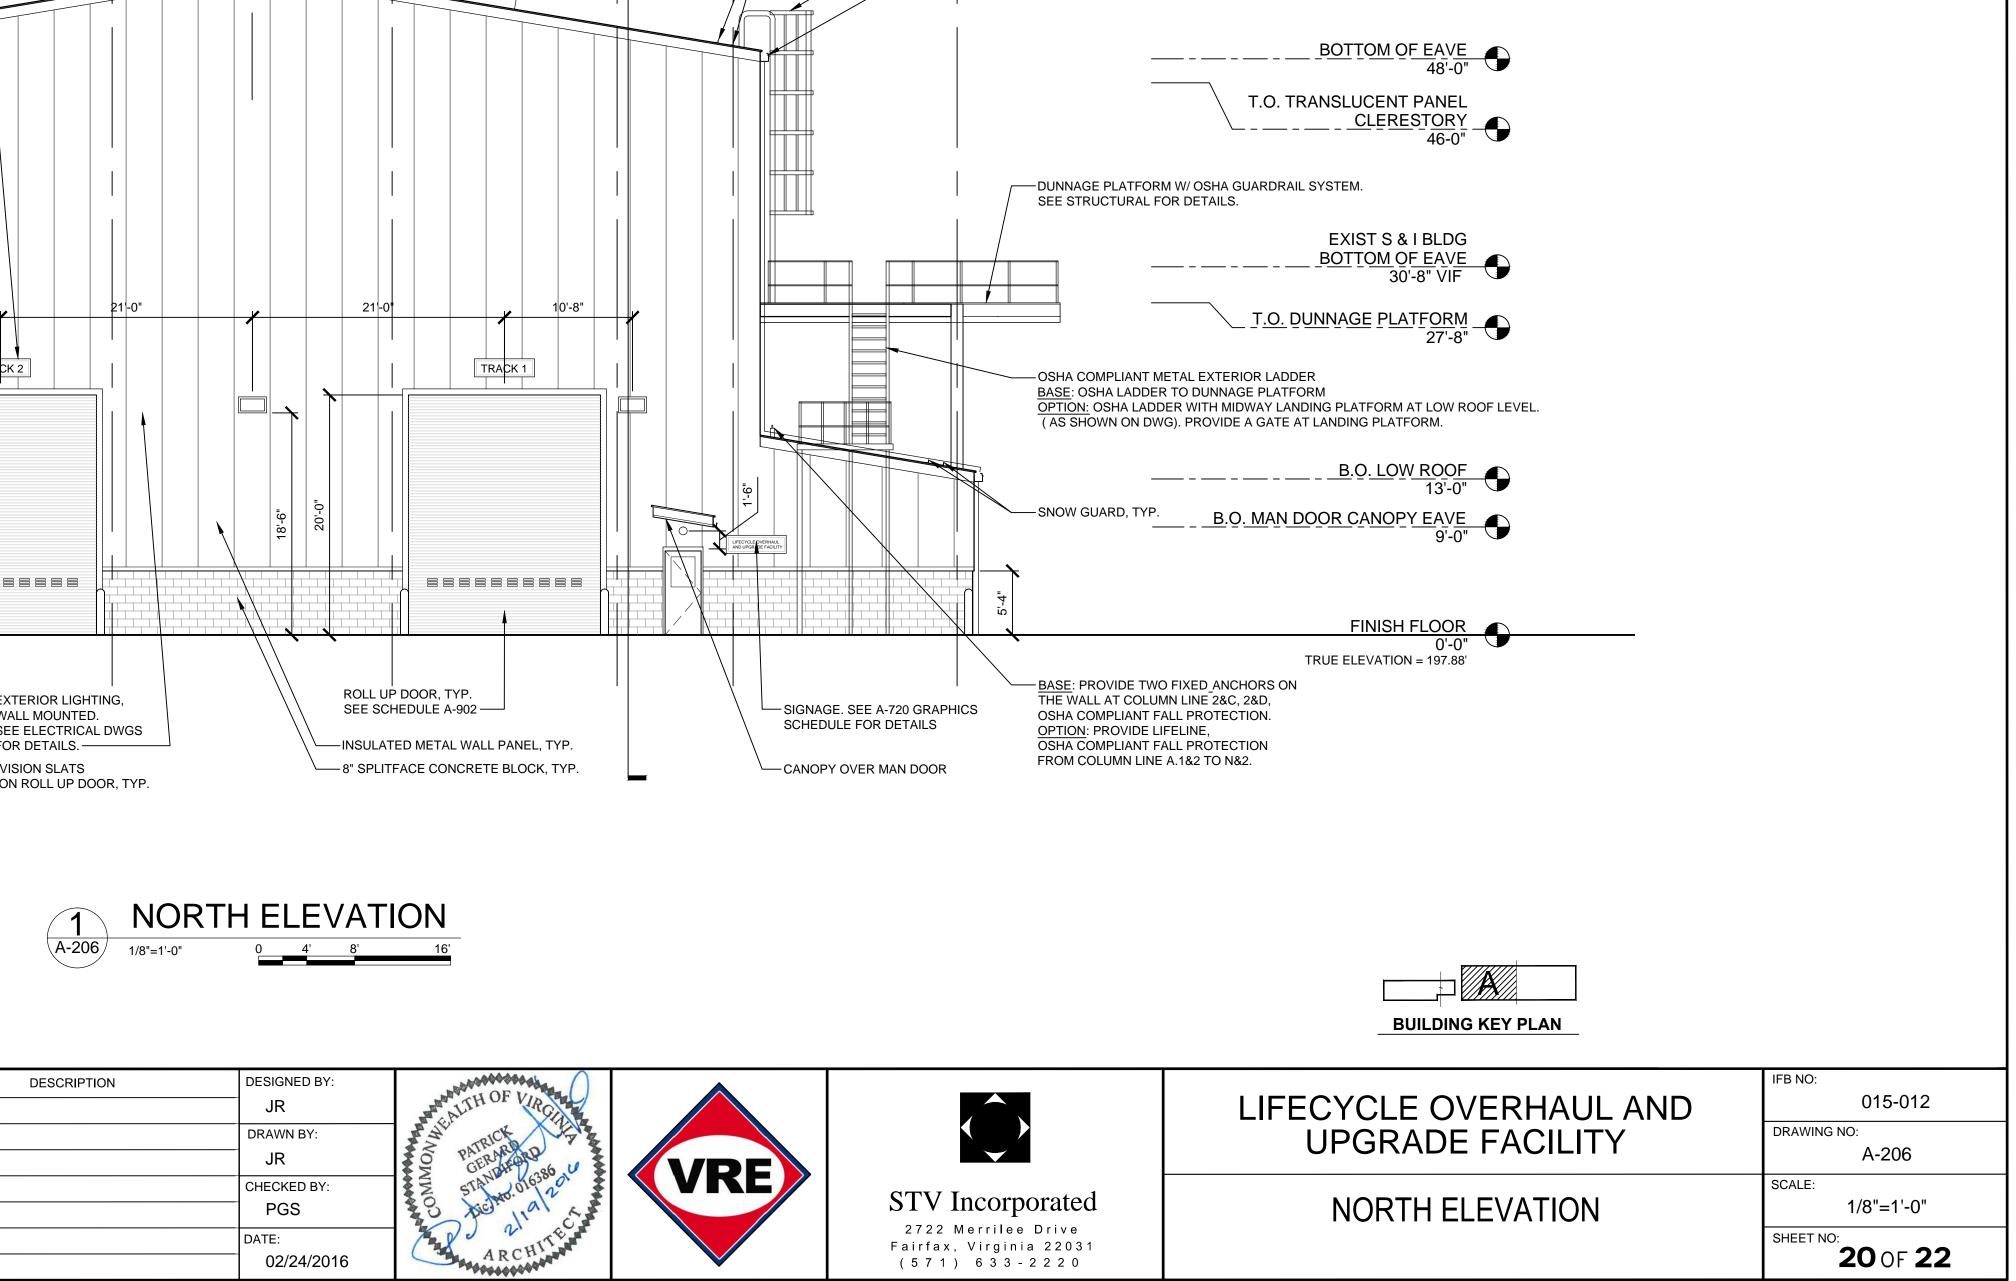
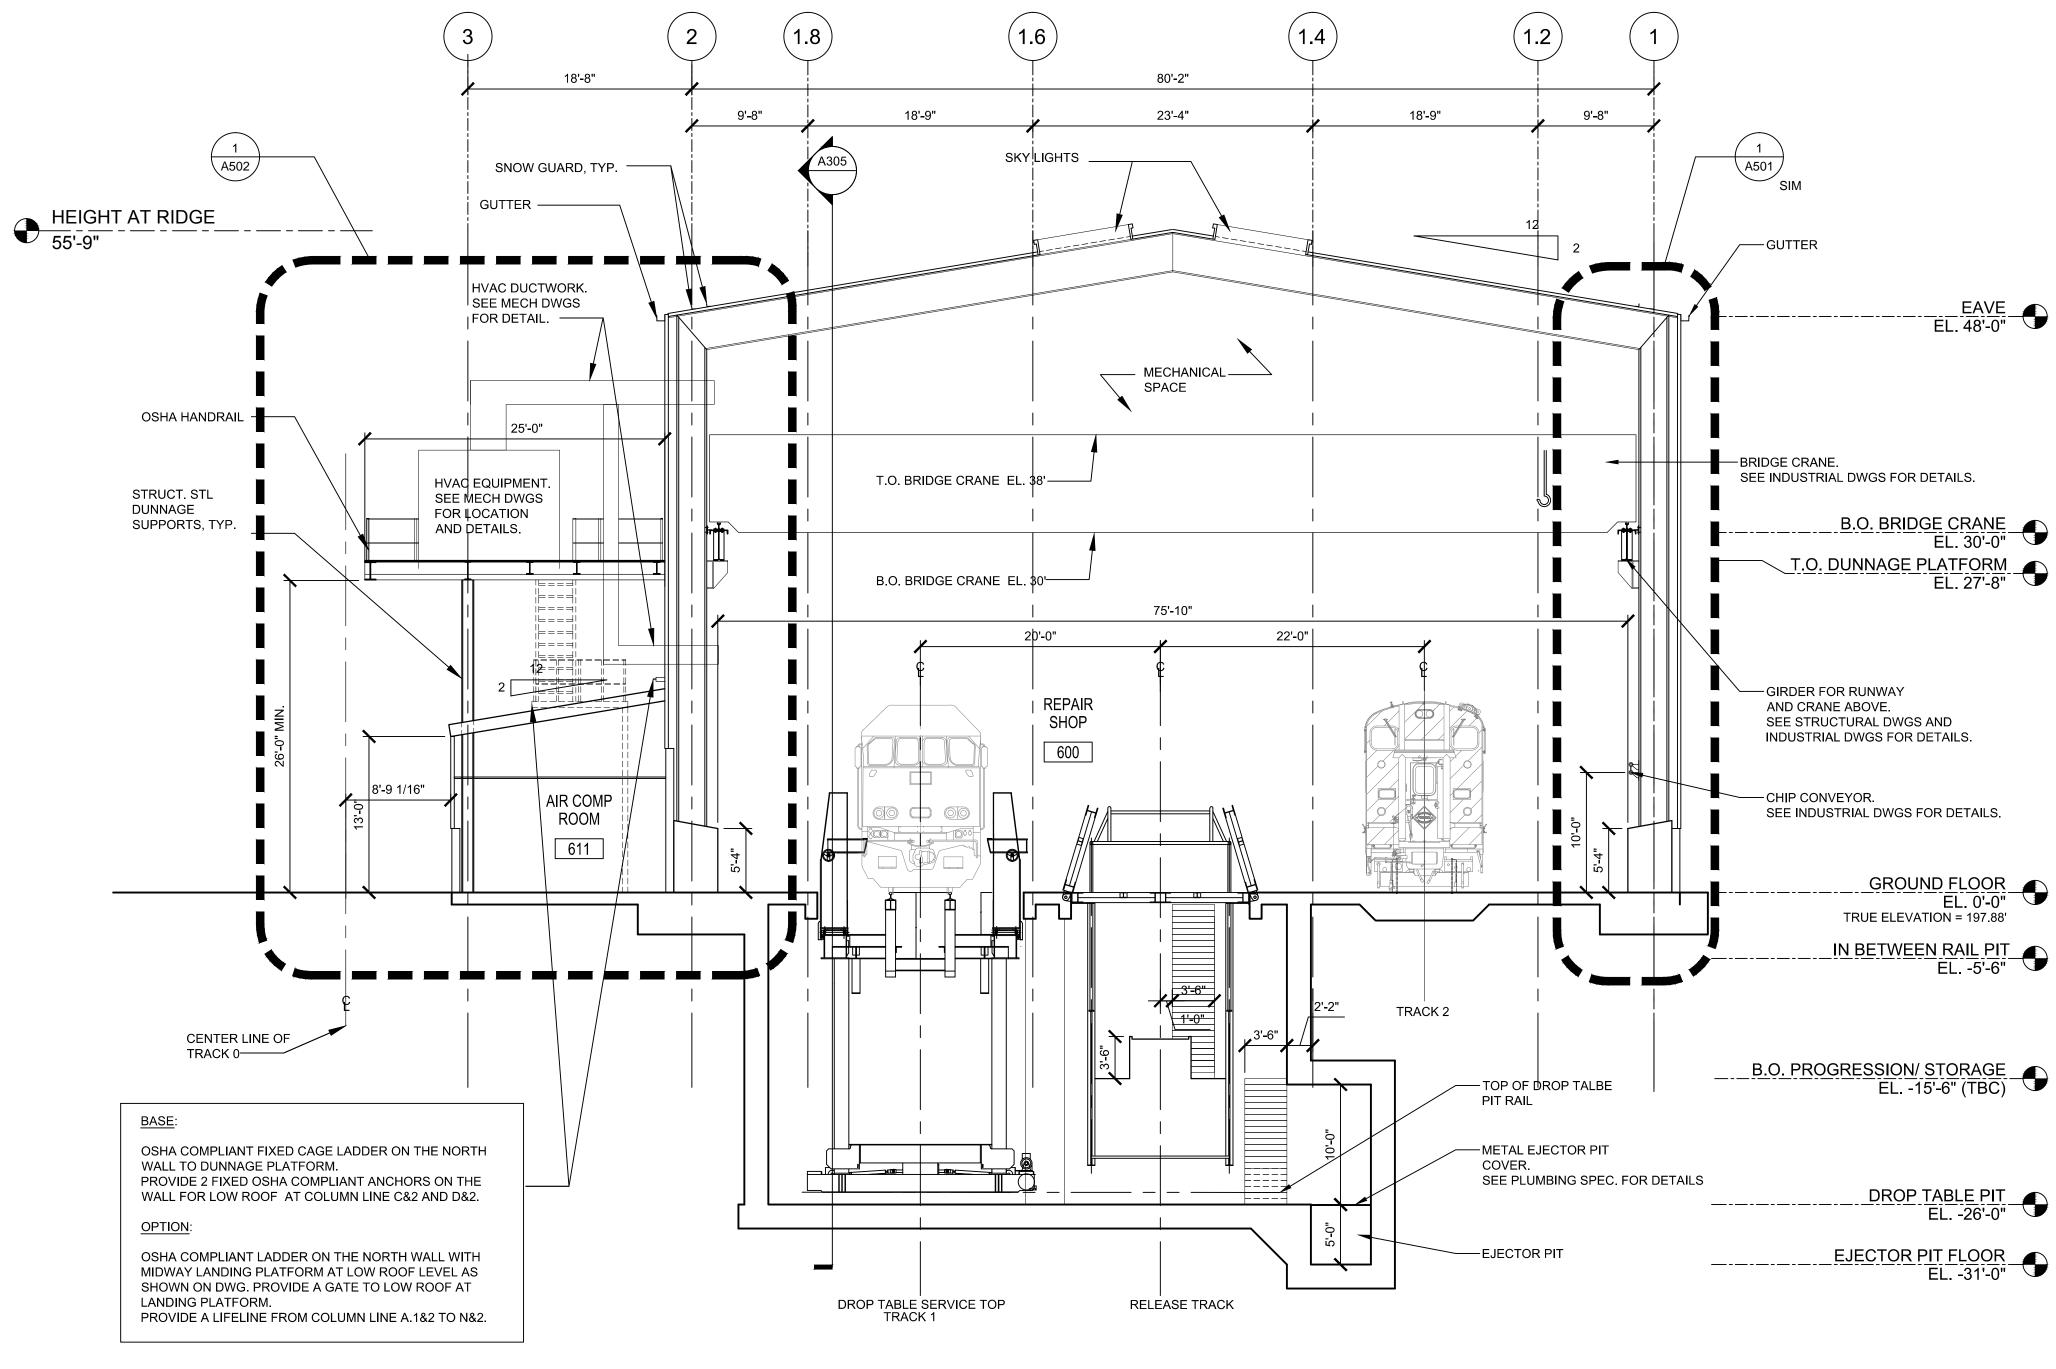
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APPROVED BY COUNTY					







B.O. BRIDGE CRANE EL. 30'-0"

LIFECYCLE OVERHAUL AND	IFB NO: 015-012
UPGRADE FACILITY	DRAWING NO: A-301
BUILDING SECTION	SCALE: 1/8"=1'-0"
	SHEET NO: <b>21</b> OF <b>22</b>

